

LEARNING CENTRE AT N.KENDIKOLHUDHOO

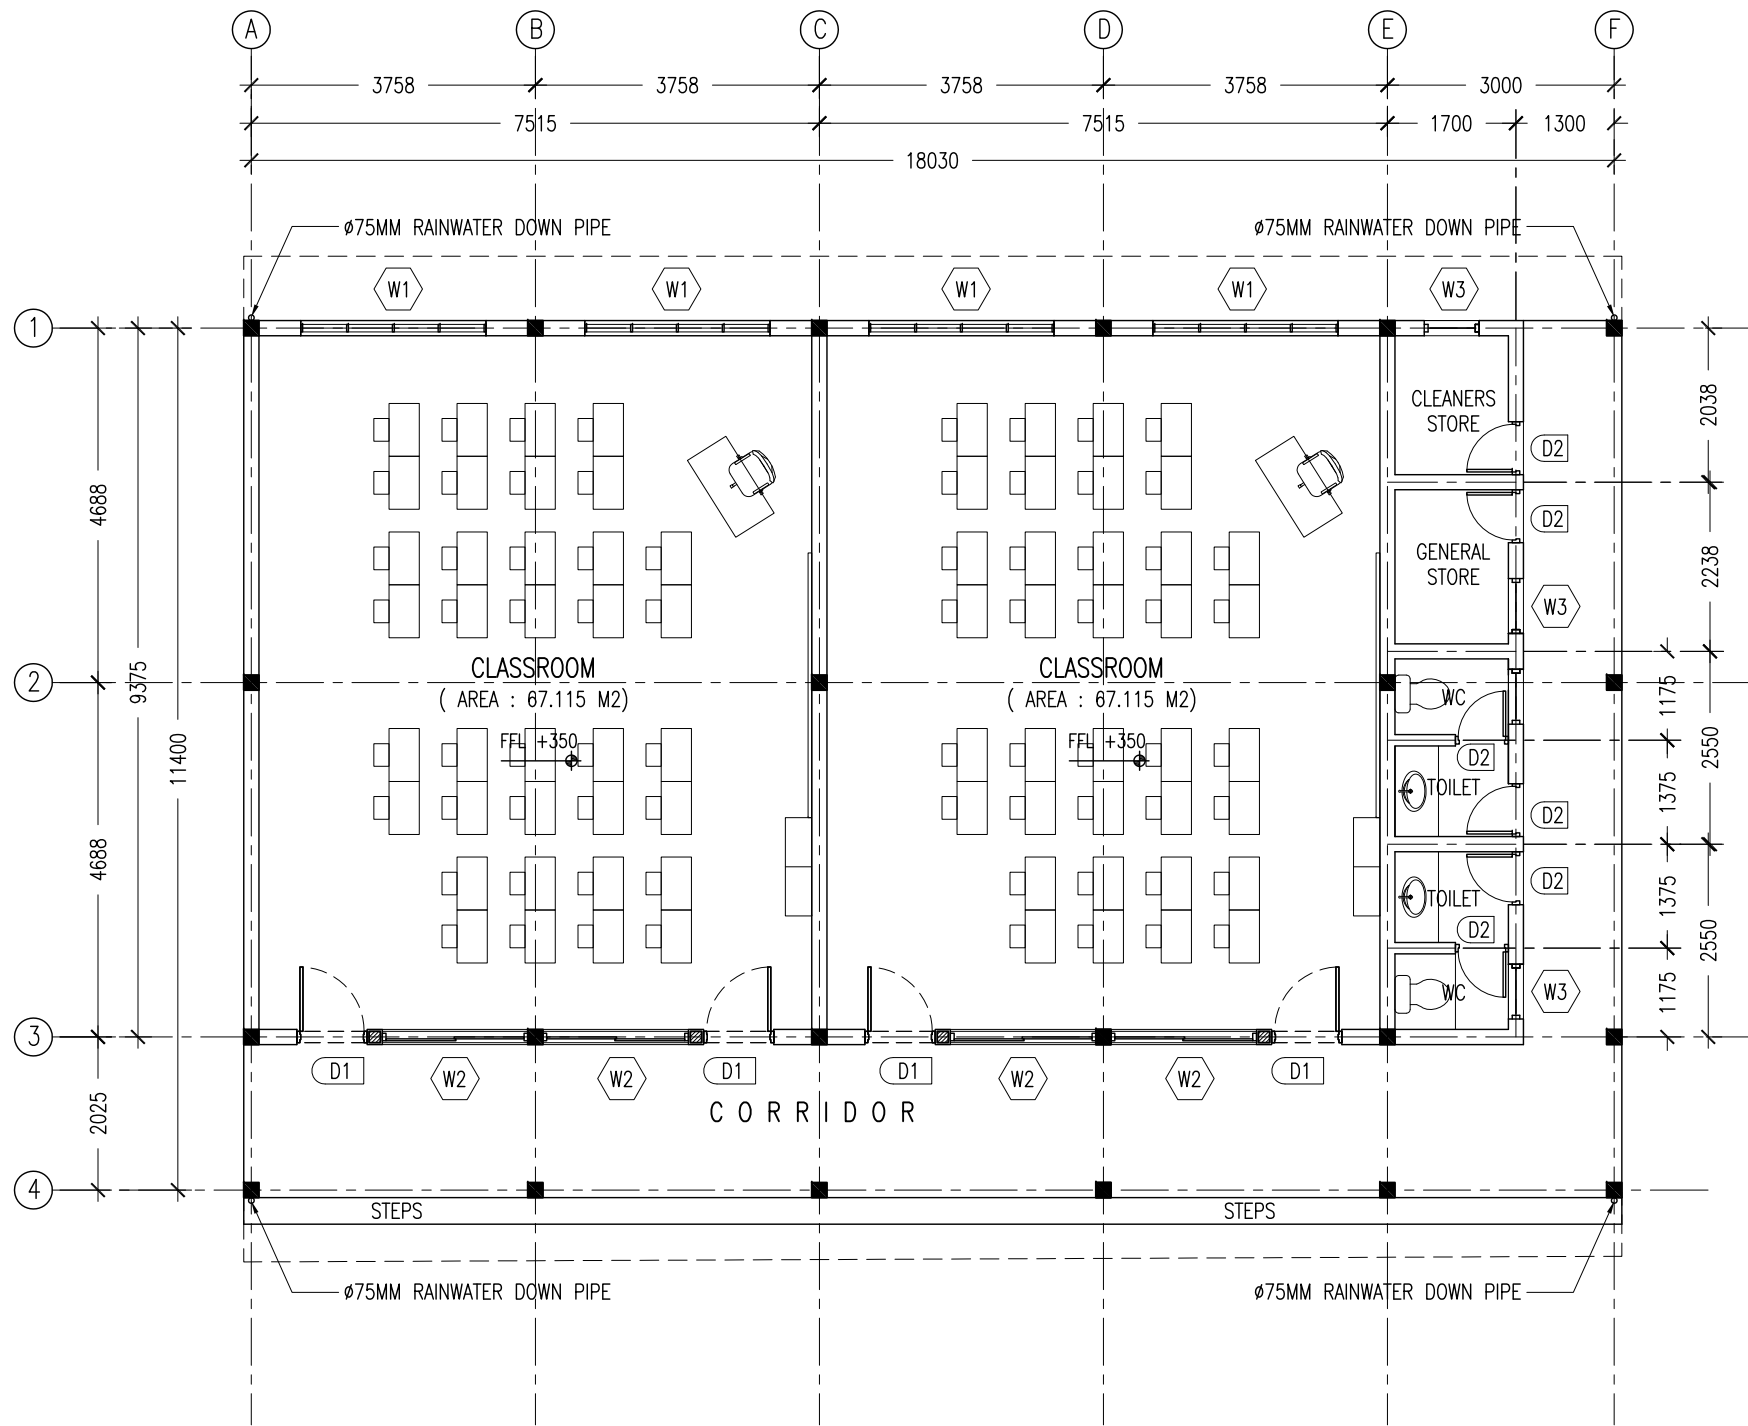
ARCHITECTURAL AND STRUCTURAL DRAWINGS

MARCH 2016

CLIENT : MALDIVES NATIONAL UNIVERSITY

DESIGN BY

ArchEng
studio
Ma Fiyajahaage, 1st floor, Male'. Republic of Maldives
admin@archeng.biz



GROUND FLOOR LAYOUT PLAN
SCALE 1:100

CONTRACTORS MUST
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SCALE READINGS



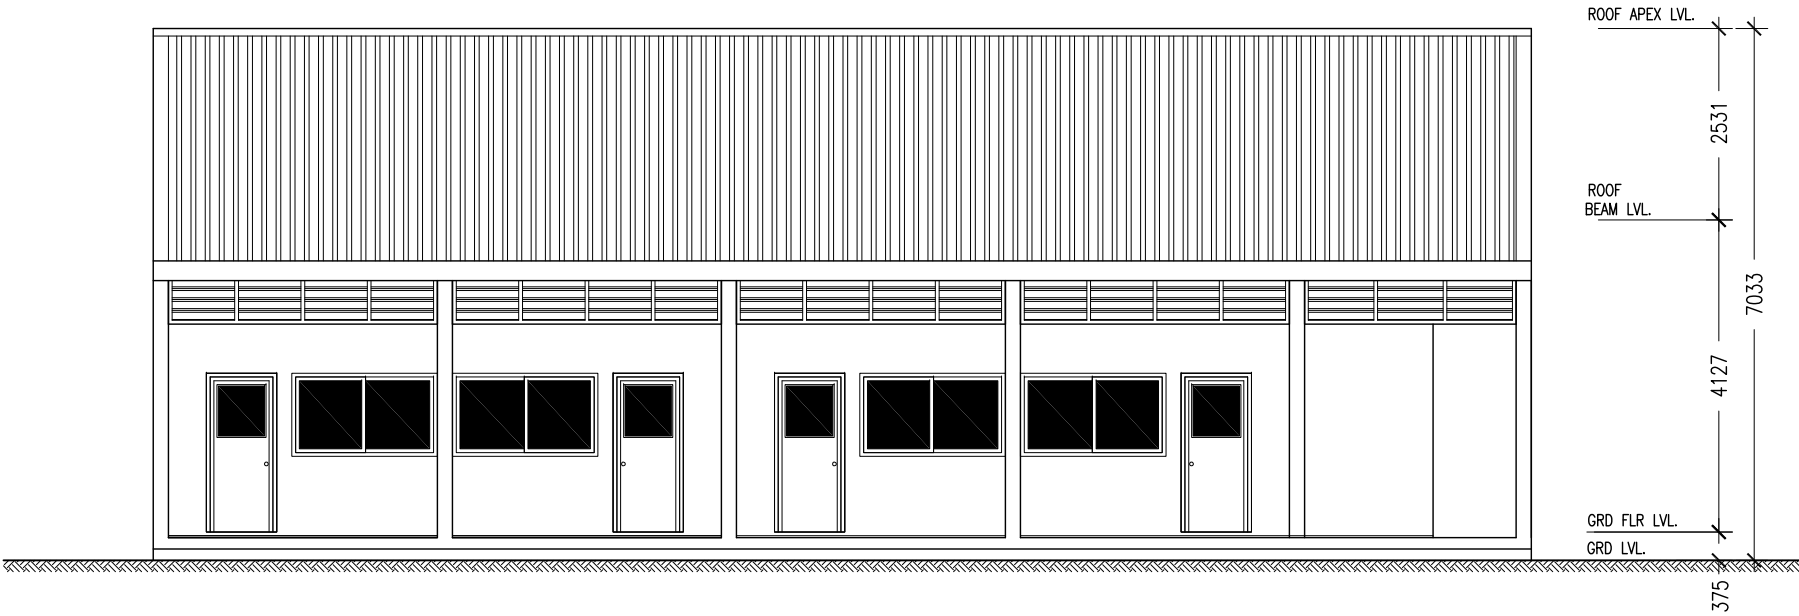
REVISION:

ARCHITECT: MOHAMED HAMEEN
ENGINEER: MOHAMED AHSAN
SERVICES ENG:
ESTIMATOR:
DRAWN BY: ASFAN AHMED

PROJECT: PROPOSED LEARNING CENTRE
LOCATION: N. KENDIKOLUDHOO
DRAWING TITLE: AS GIVEN
CLIENT: MALDIVES NATIONAL UNIVERSITY
SCALE: AS GIVEN DIMENSION: MM DATE: JANUARY 2016

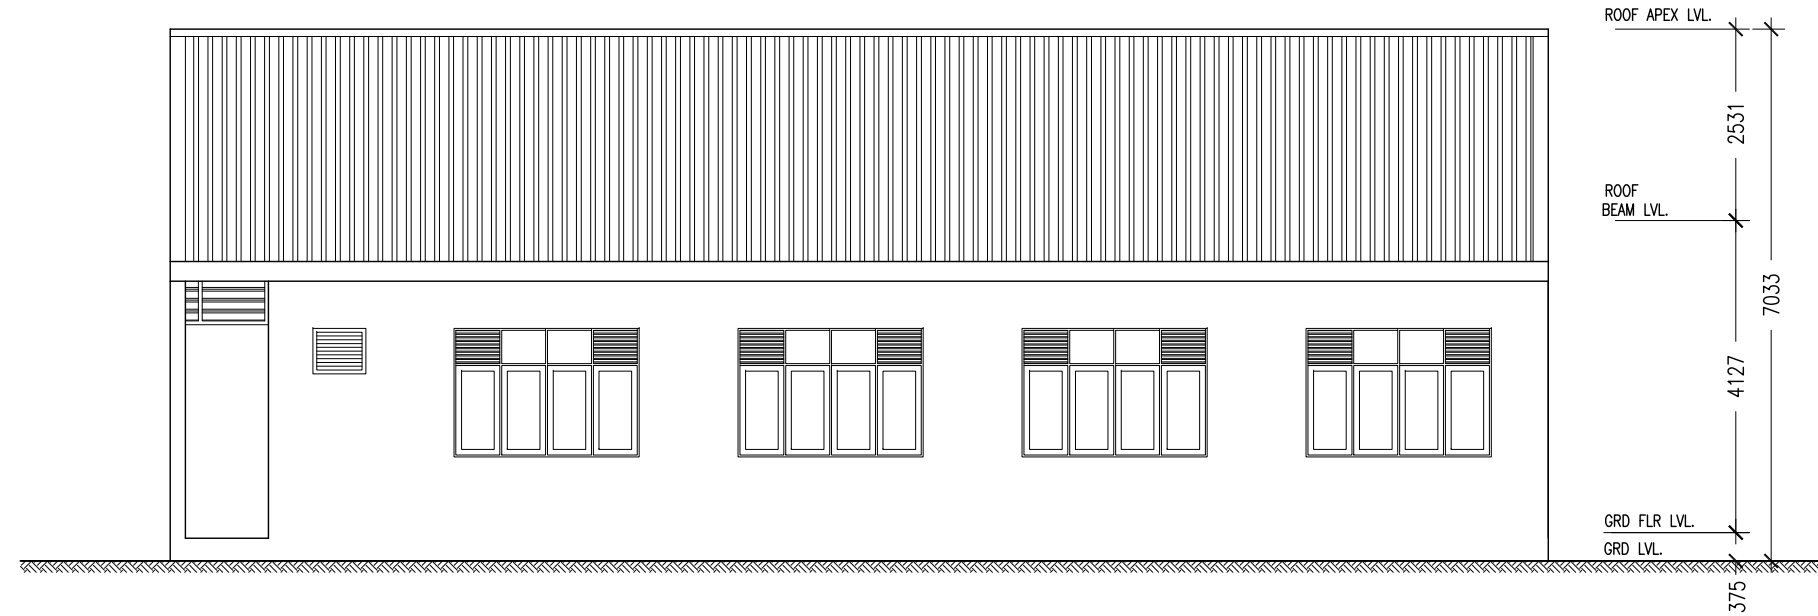
A-01
DWG NO
PROJECT NO.: 16-008

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FRONT ELEVATION

SCALE 1:100



BACK ELEVATION

SCALE 1:100

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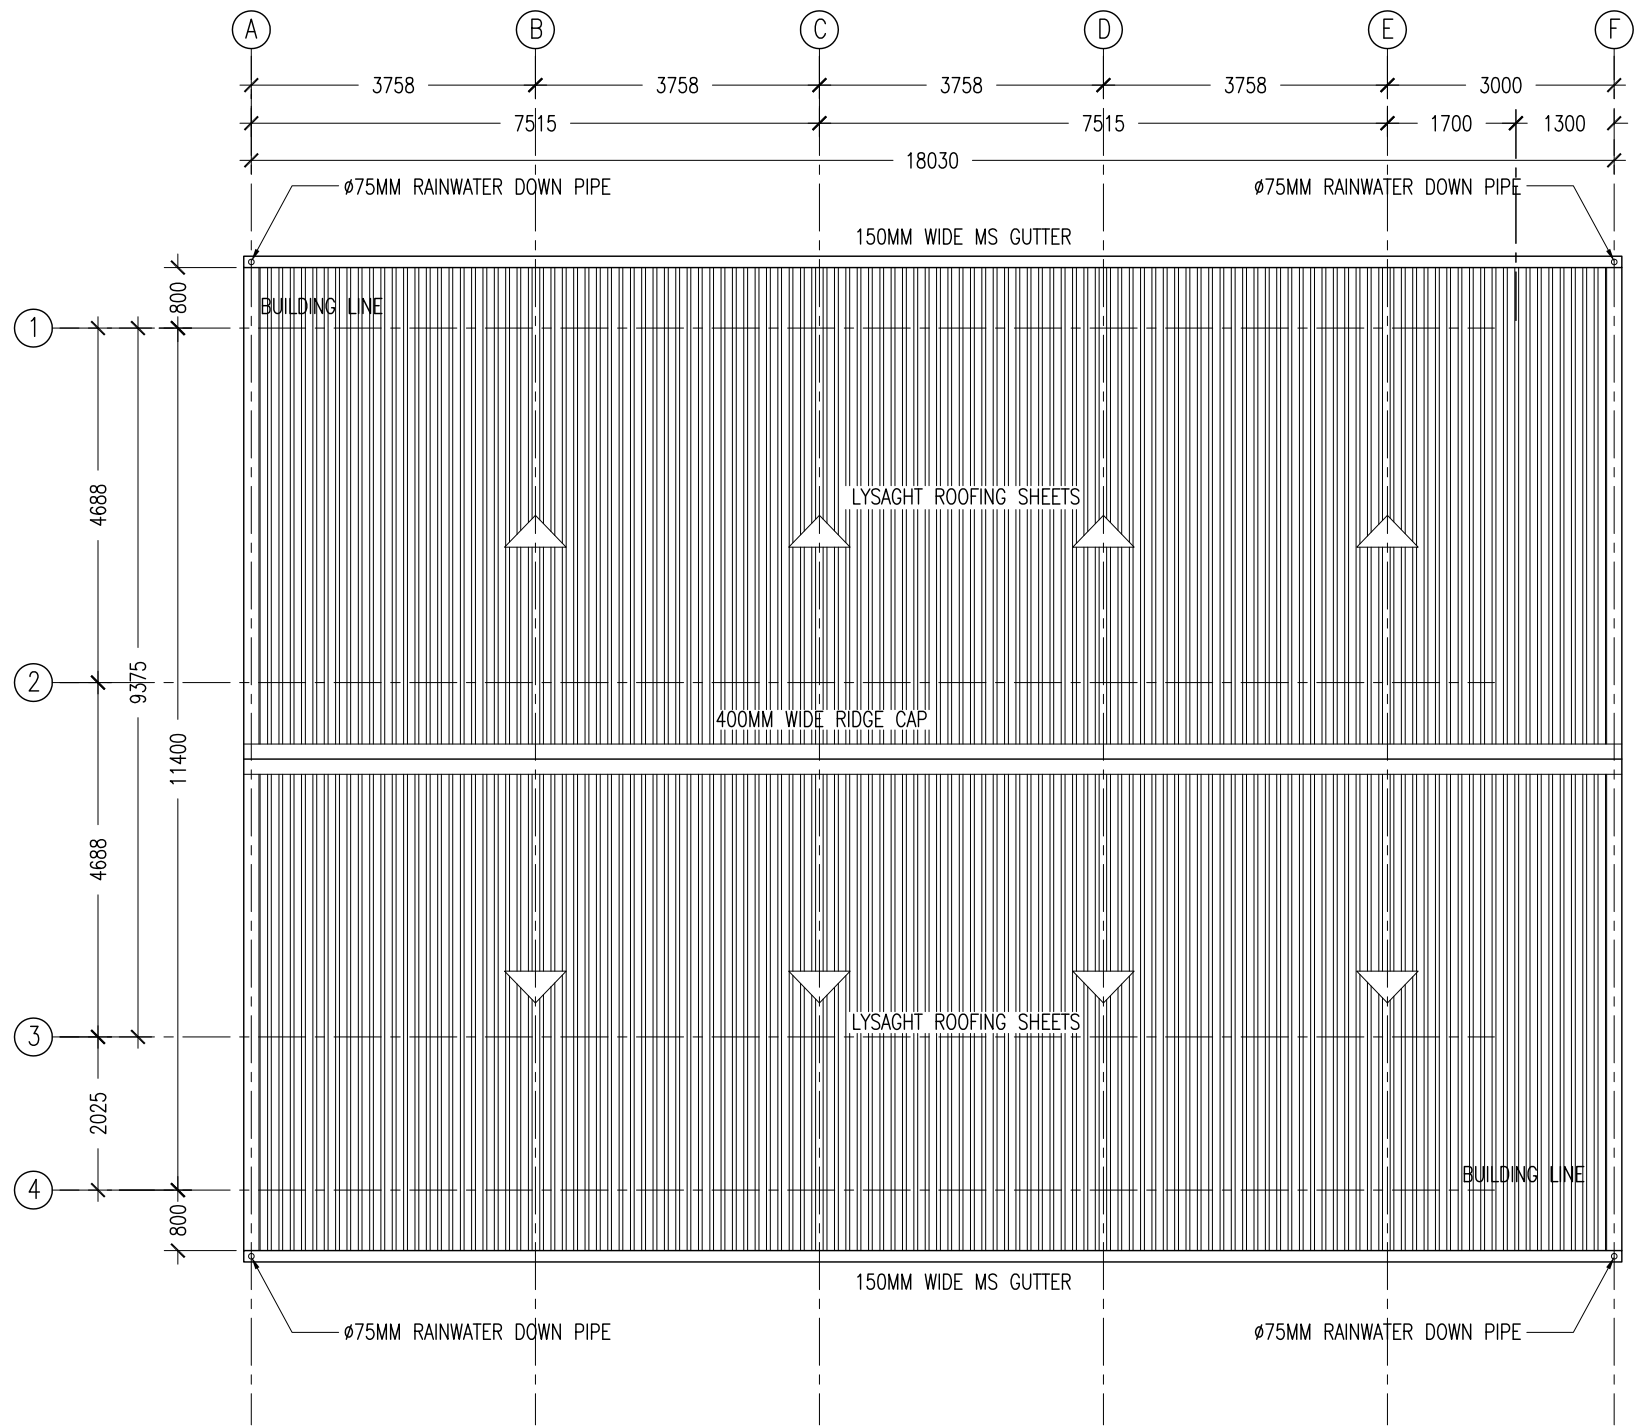
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DATE:	JANUARY 2016		

A-02
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ROOF LAYOUT PLAN
SCALE 1:100

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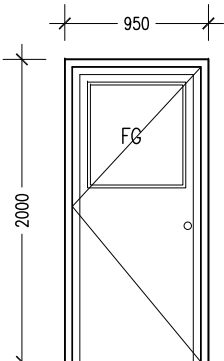
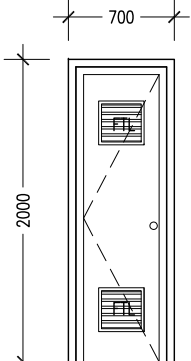
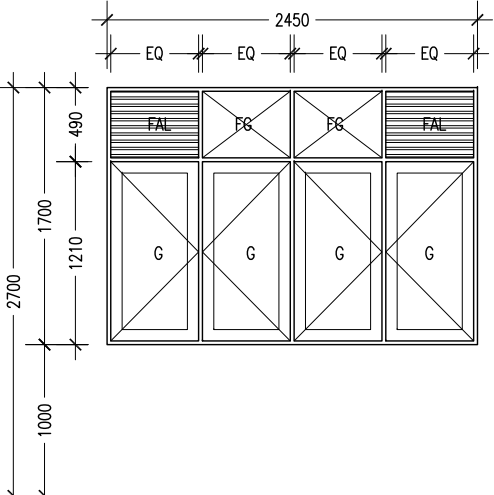
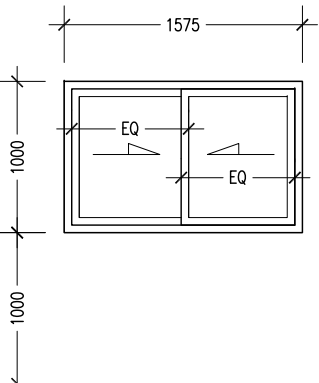
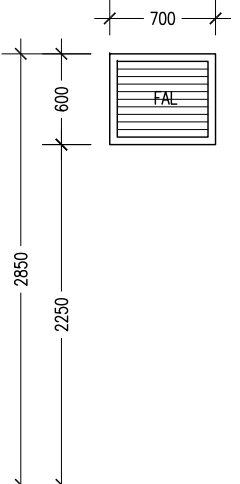
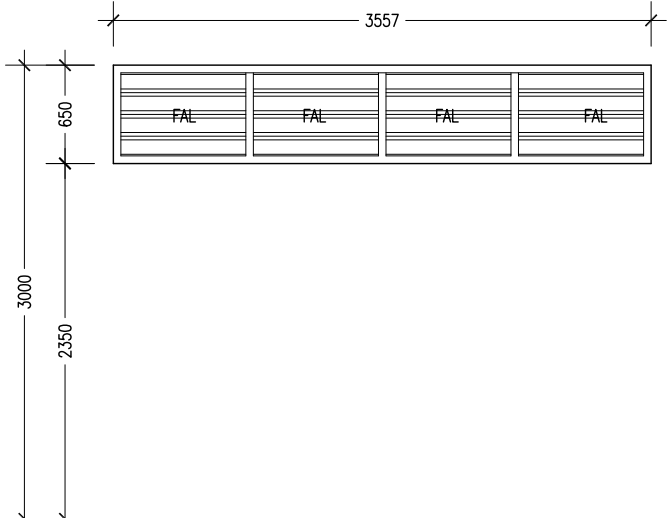
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A-04
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ELEVATIONS :						
	FINISH FLOOR LEVEL →					
DR / WD NO.	D1	D2	W1	W2	W3	SHADING DEVICE (SIDE) TYPE--2
DESCRIPTION :	40MM THICK OPENABLE SOLID TIMBER DOOR PANEL	40MM THICK OPENABLE SOLID TIMBER DOOR PANEL	ALUMINUM FRAMED WINDOW PANEL	ALUMINUM FRAMED SLIDING WINDOW PANEL	ALUMINUM FRAMED FIXED LOUVERS	
FRAME :	120MM TIMBER FRAME	120MM TIMBER FRAME	80 MICRON WHITE POWDER COATED ALUMINIUM FRAME	80 MICRON WHITE POWDER COATED ALUMINIUM FRAME	80 MICRON WHITE POWDER COATED ALUMINIUM FRAME	
HARDWARE :	DOOR CLOSER CYLINDRICAL LOCK BUTT HINGE STOPPER HOLDER	DOOR CLOSER CYLINDRICAL LOCK BUTT HINGE STOPPER HOLDER				(REFER ELEVATIONS FOR LOCATION)
GLAZING :	C-4MM ALL FIXED PANELS TO BE DOUBLE GLAZED	C-4MM ALL FIXED PANELS TO BE DOUBLE GLAZED	C-5MM THICK BLUE TINTED GLASS	C-5MM THICK BLUE TINTED GLASS ALL FIXED PANELS TO BE DOUBLE GLAZED		

GENERAL NOTES:

SHOP DRAWINGS FOR ALL DOORS AND
WINDOWS SHALL BE PROVIDED
SHOWING LOCATION AND TYPE OF IRONMONGERIES

G : GLASS
FG : FIXED GLASS
FAL : FIXED ALUMINUM LOUVERS

ALL DIMENSIONS TO BE CHECKED
ON SITE PRIOR TO FABRICATION

ALL TIMBER FOR WOODEN DOORS SHALL
BE TREATED FOR THE USE IN INDOORS.

DOOR / WINDOW SCHEDULE
SCALE 1:50

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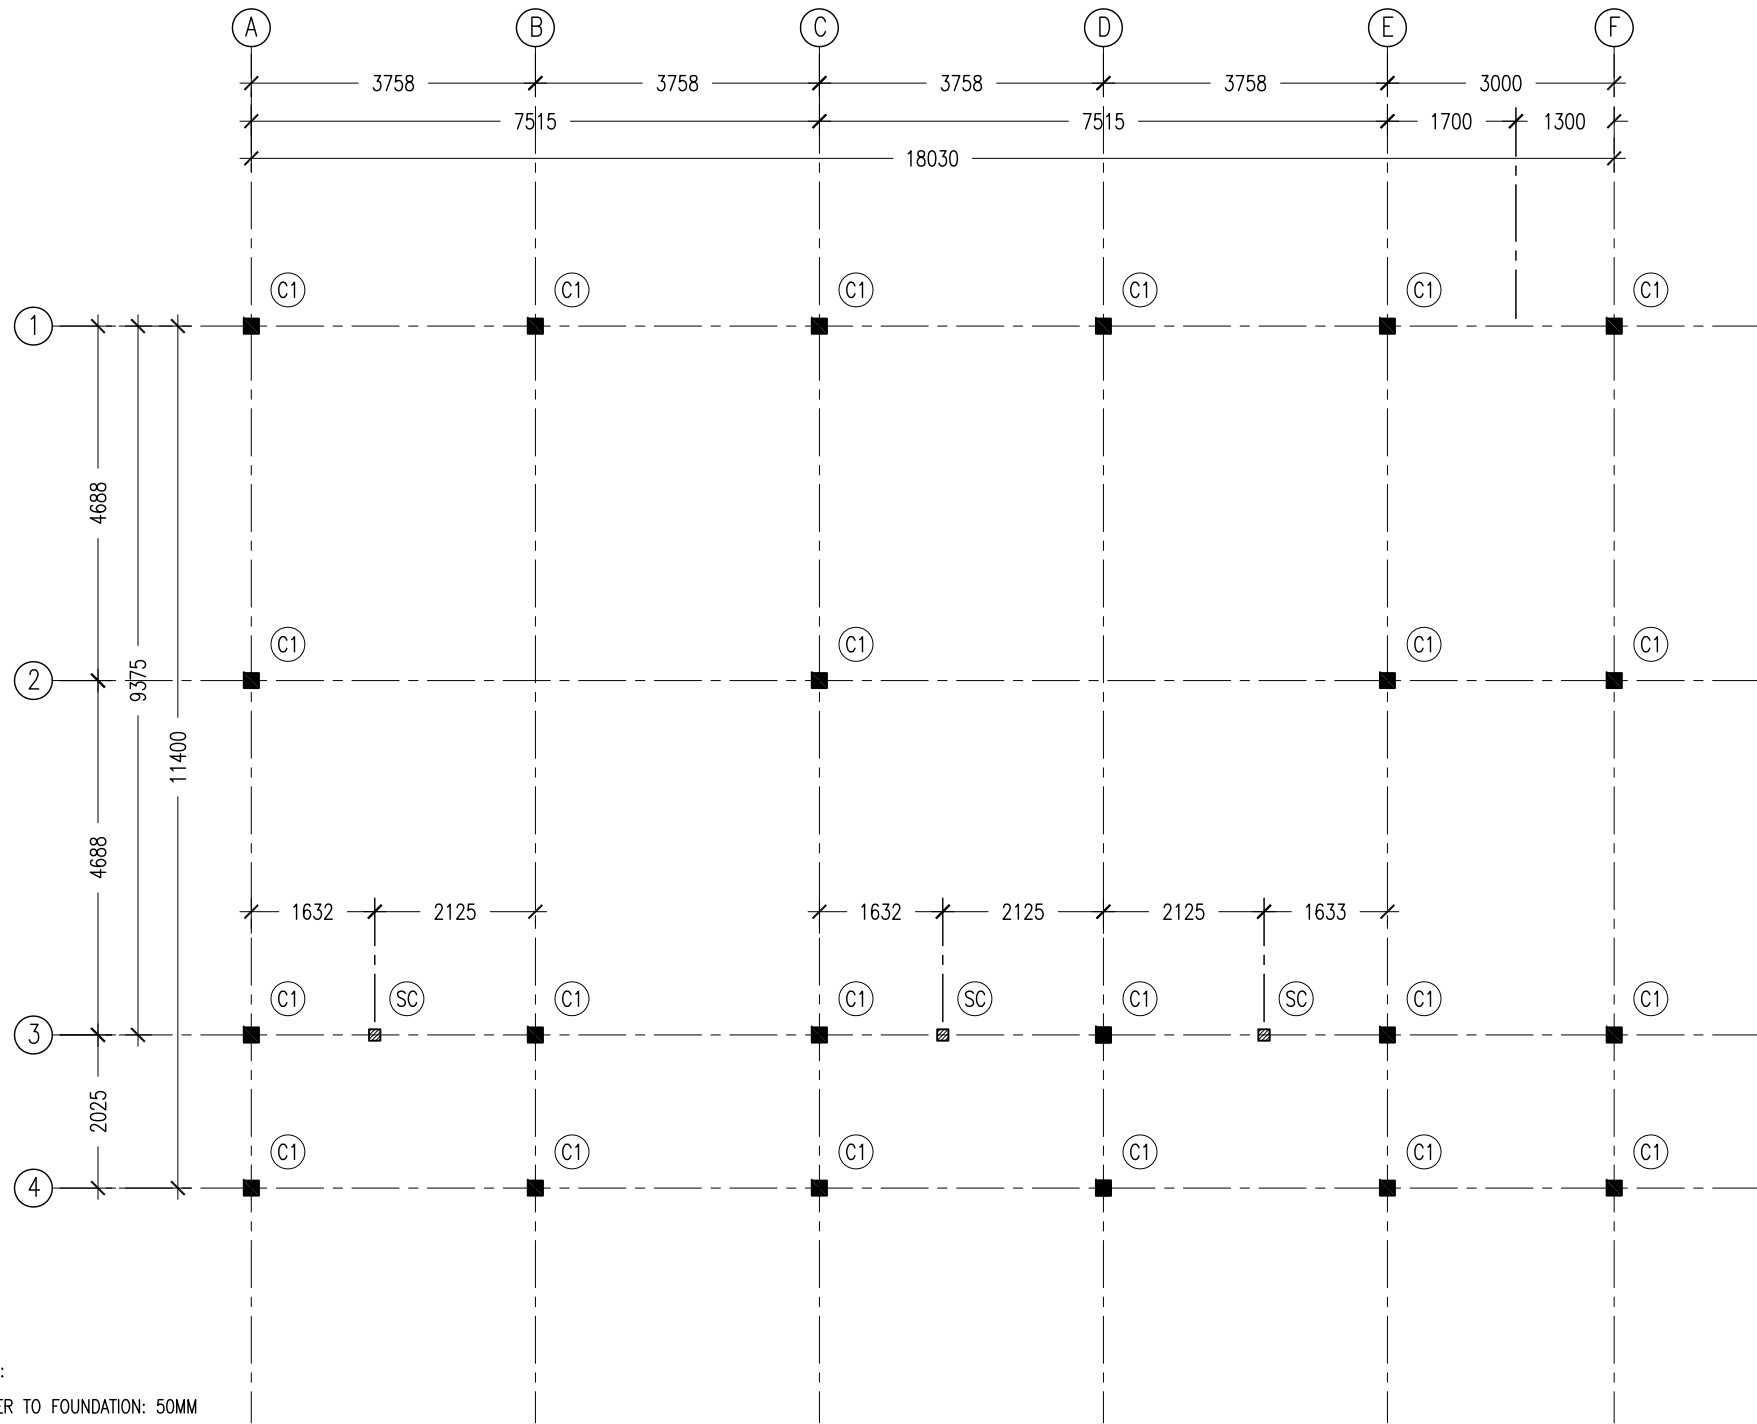
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A-05
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- NOTES :
- COVER TO FOUNDATION: 50MM
 - COVER TO BEAMS : 50MM
 - COVER TO COLUMNS : 40MM
 - CONCRETE MIX : 1:2:3
UNLESS STATED
 - ADD CONMIX MEGA FLOW P TO ALL SUPER STRUCTURE CONCRETE.
 - ADD CONMIX MEGA ADD WL3 TO ALL SUBSTRUCTURE CONCRETE.
 - APPY 2 COATS OF CONMIX MOYA SHIELD RBE TO ALL STRUCTURE CONCRETE
BELOW GROUND LEVEL.

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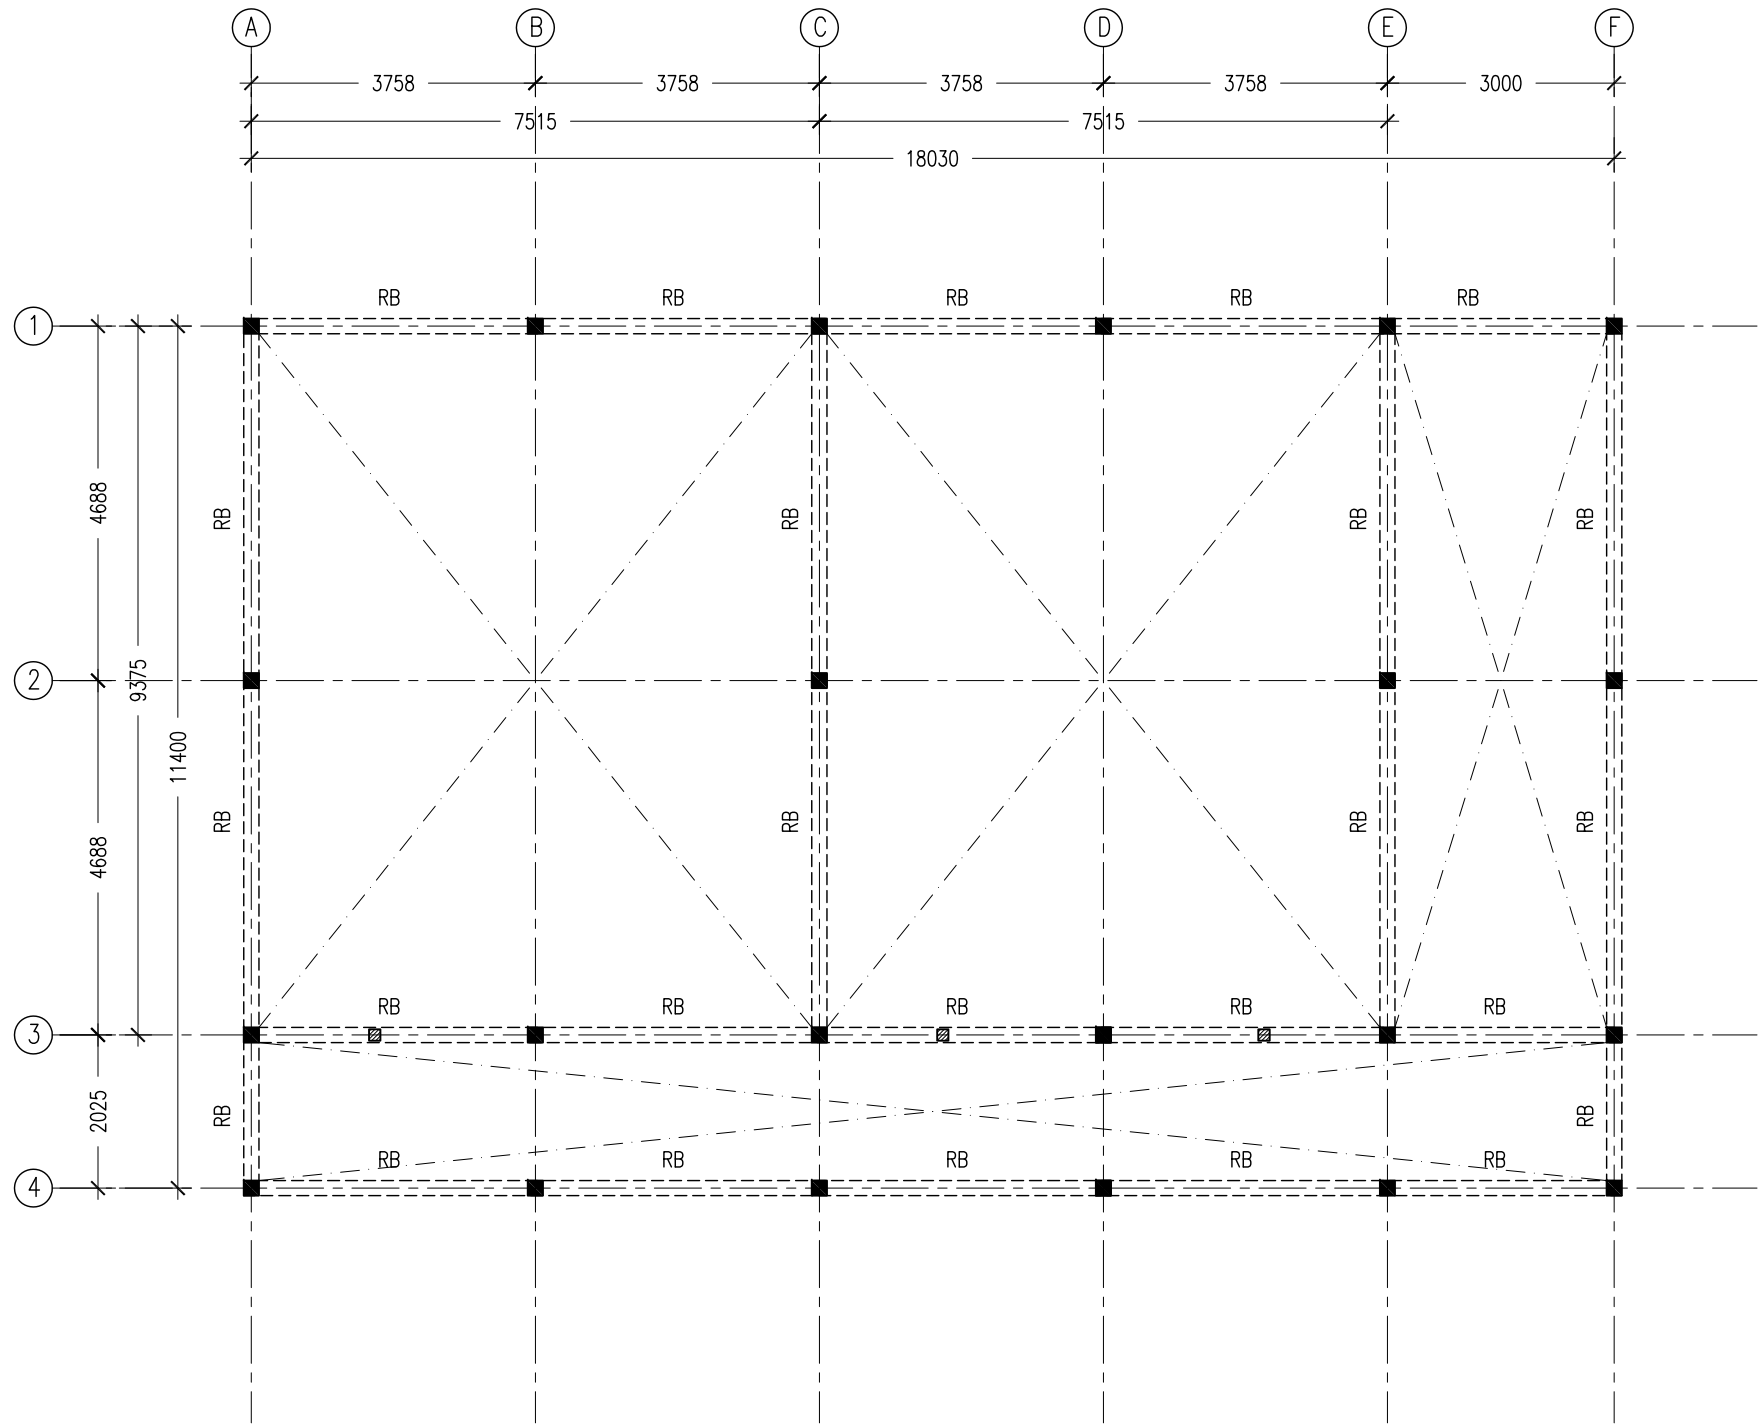
ARCHITECT:	MOHAMED HAMEEN
ENGINEER:	MOHAMED AHSAN
SERVICES ENG:	
ESTIMATOR:	
DRAWN BY:	ASFAN AHMED

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S-01
DWG NO
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NOTES :

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- COVER TO COLUMNS : 40MM
- CONCRETE MIX : 1:2:3
UNLESS STATED
- ADD CONMIX MEGA FLOW P TO ALL SUPER STRUCTURE CONCRETE.
- ADD CONMIX MEGA ADD WL3 TO ALL SUBSTRUCTURE CONCRETE.

ROOF BEAM PLAN
SCALE 1:100

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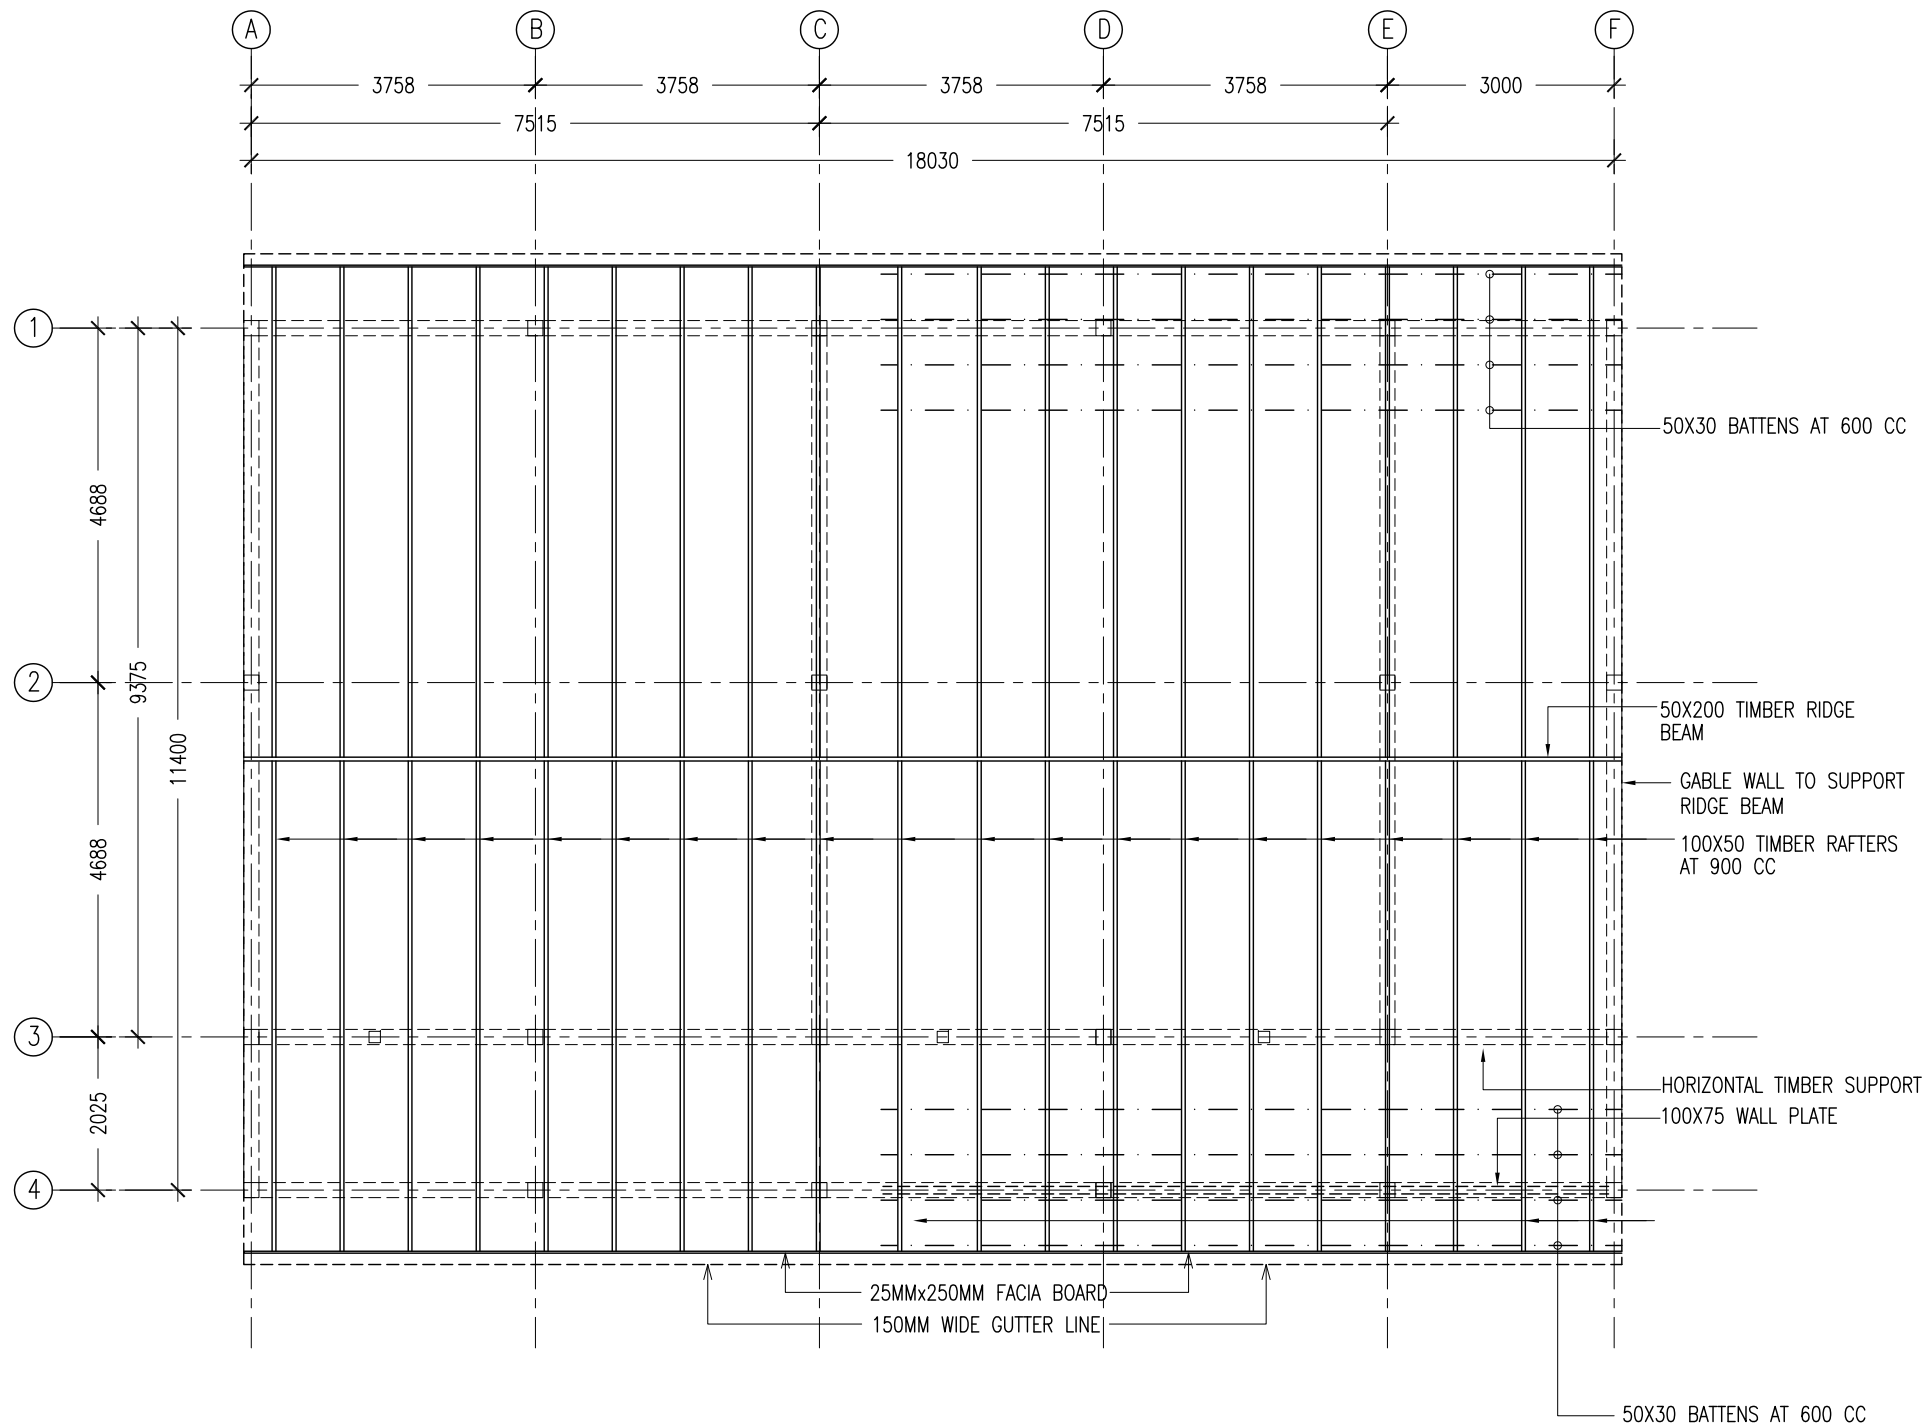


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SERVICES ENG:	
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S-03
DWG NO
PROJECT NO.: 16-008



NOTES :

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- COVER TO COLUMNS : 40MM
- CONCRETE MIX : 1:2:3
UNLESS STATED
- ADD CONMIX MEGA FLOW P TO ALL SUPER STRUCTURE CONCRETE.
- ADD CONMIX MEGA ADD WL3 TO ALL SUBSTRUCTURE CONCRETE.

ROOF STRUCTURE LAYOUT PLAN

SCALE 1:100

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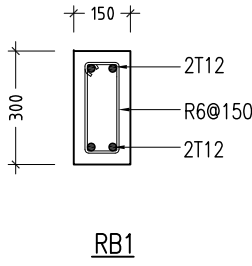
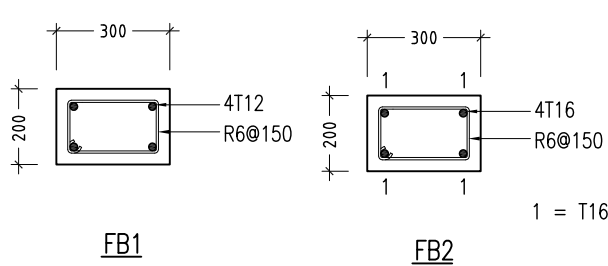
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REVISION:	ARCHITECT: MOHAMED HAMEEN	PROJECT: PROPOSED LEARNING CENTRE	S-04 DWG NO
	ENGINEER: MOHAMED AHSAN	LOCATION: N. KENDIKOLUDHOO	
	SERVICES ENG:	DRAWING TITLE: AS GIVEN	
	ESTIMATOR:	CLIENT: MALDIVES NATIONAL UNIVERSITY	
	DRAWN BY: ASFAN AHMED	SCALE: AS GIVEN	DIMENSION: MM
		DATE: JANUARY 2016	PROJECT NO.: 16-008

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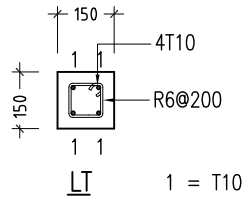
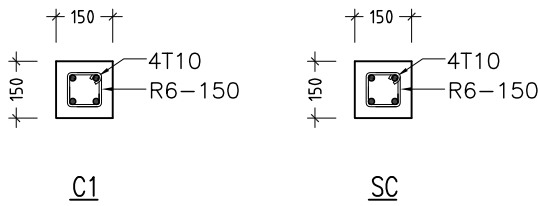
FOOTING	LENGTH/mm	WIDTH/mm	DEPTH/mm	REINFORCEMENT
F1	700	700	300	T10@150mm C/C BW BOTTOM

FOOTING DETAILS



FOUNDATION BEAM DETAILS
SCALE 1:20

ROOF BEAM DETAIL
SCALE 1:20



LINTELS OVER ALL DOORS, WINDOWS,
(THAT DO NOT RISE TO ROOF BEAM LEVEL)
STRUCTURAL OPENINGS IN WALLS

COLUMN DETAILS
SCALE 1:20

LINTEL/SILL BEAM DETAILS
SCALE 1:20

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SERVICES ENG:	
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S-05
DWG NO
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LEARNING CENTRE AT N.KENDIKOLHUDHOO

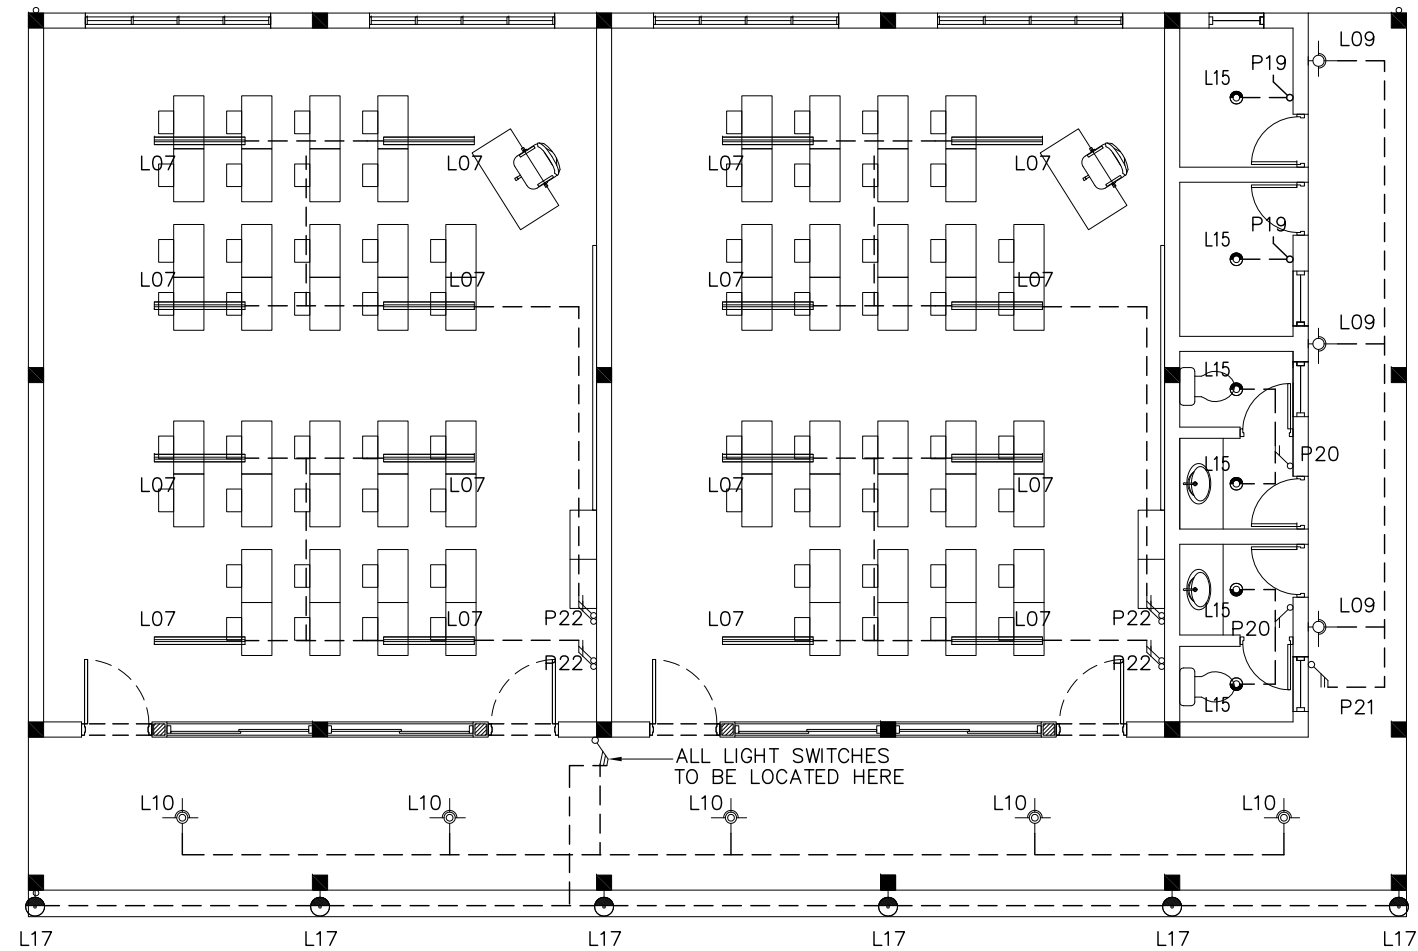
SERVICES DRAWINGS

MARCH 2016

CLIENT : MALDIVES NATIONAL UNIVERSITY

DESIGN BY

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LEGEND

SYMBOL	CODE	DESCRIPTION
	L07	2X36W FLUORESCENT LAMPS IN SURFACE MOUNT LUMINAIRE WITH DIFFUSER
	L09	WALL MOUNT ENERGY SAVING LIGHT
	L10	1X26W COMPACT FLUORESCENT LAMPS IN RECESSED DECORATIVE LUMINAIRE
	L15	1X60W INCANDESCENT LAMPS IN RECESSED DECORATIVE LUMINAIRE
	L17	1X60W INCANDESCENT LAMPS IN SURFACE MOUNT WEATHER PROOF LUMINAIRE
	P19	1GANG 1 WAY SWITCH
	P20	2GANG 1 WAY SWITCH
	P21	3GANG 1 WAY SWITCH
	P22	4GANG 1 WAY SWITCH

GROUND FLOOR LIGHTING LAYOUT PLAN

SCALE 1:100

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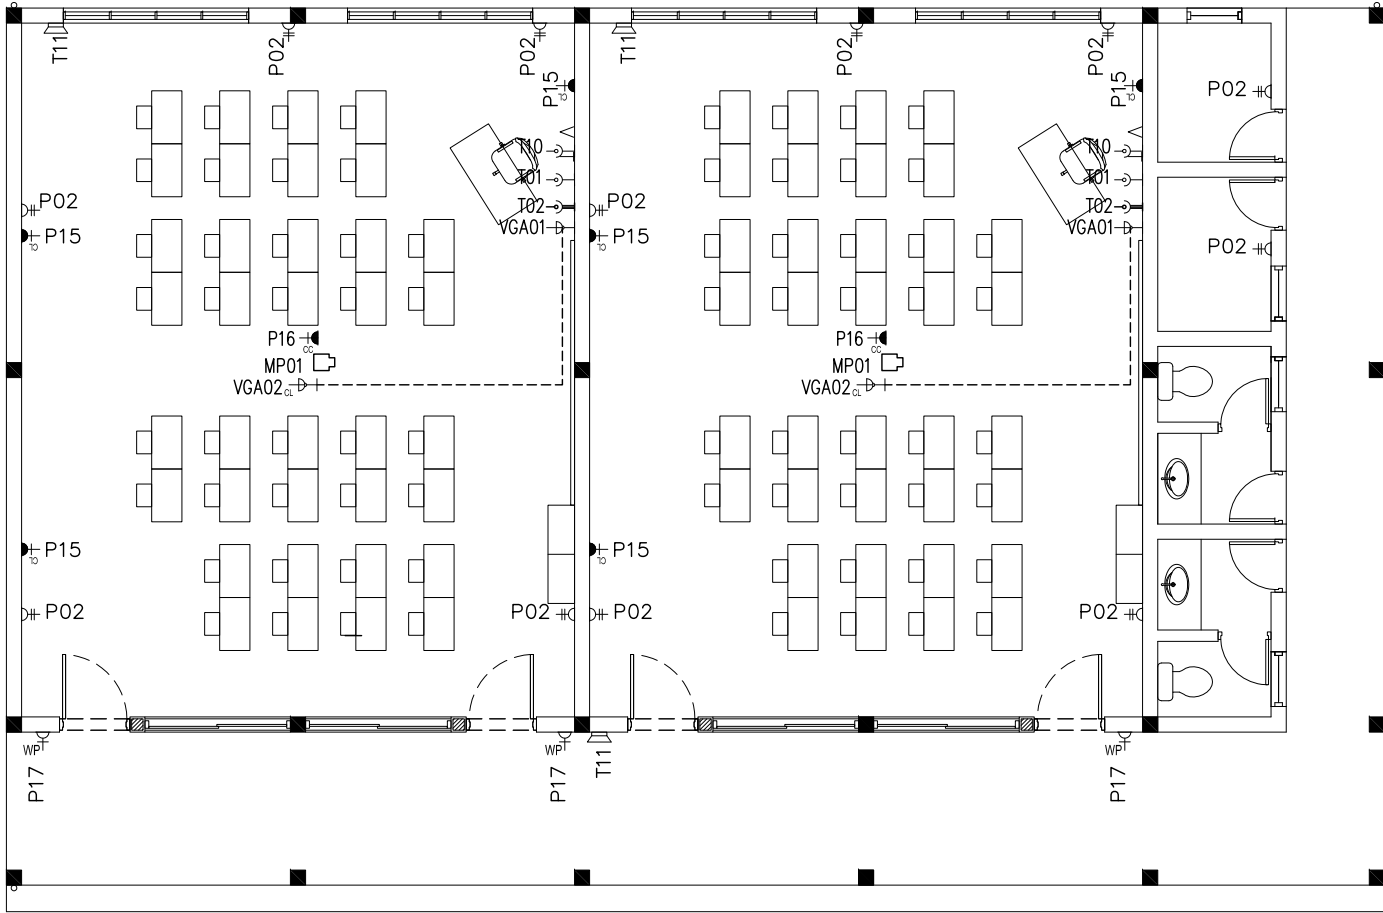
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E-01

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LEGEND

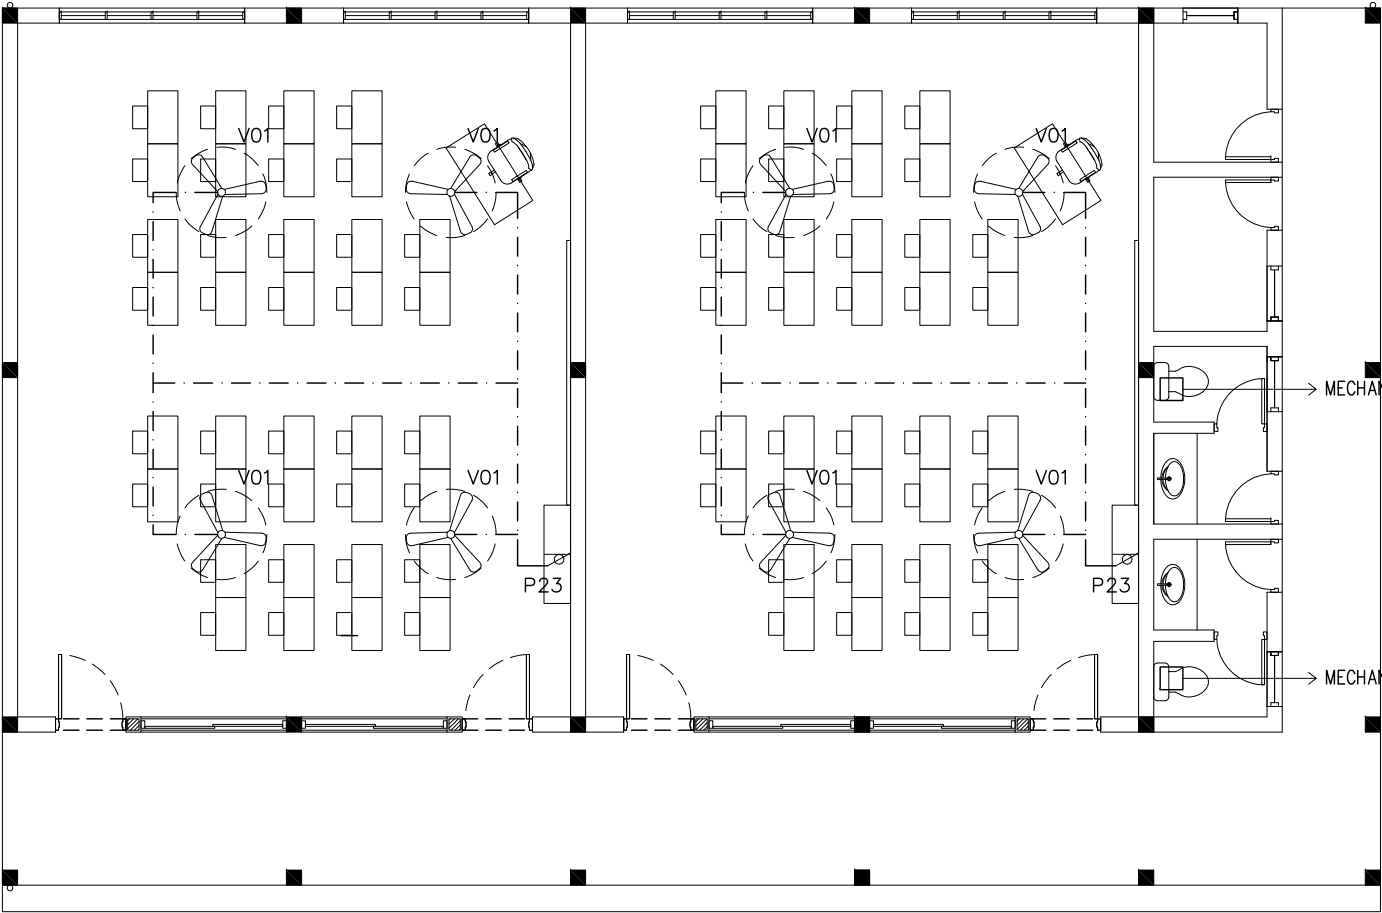
SYMBOL	CODE	DESCRIPTION
	P01	1 GANG13A SOCKET OUTLET AT 300mm ABOVE FINISHED FLOOR LEVEL
	P02	2 GANG13A SOCKET OUTLET AT 300mm ABOVE FINISHED FLOOR LEVEL
	P15	1 GANG15A SOCKET OUTLET AT CEILING LEVEL
	P16	1 GANG13A SOCKET OUTLET AT CEILING LEVEL
	P17	1 GANG13A SOCKET OUTLET AT 300mm ABOVE FINISHED FLOOR LEVEL (WEATHER PROOF)
	VGA01	VGA CABLE
	VGA02	VGA CABLE AT CEILING LEVEL
	T01	PLAIN TELEPHONE OUTLET
	T02	COMPUTER NETWORK OUTLET
	MP01	MULTIMEDIA PROJECTOR
	T10	T.V POINT
	T11	SPEAKER

GROUND FLOOR POWER SOCKET LAYOUT PLAN
SCALE 1:100

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REVISION:	ARCHITECT:	MOHAMED HAMEEN	PROJECT:	PROPOSED LEARNING CENTRE			<div>E-02</div>	
	ENGINEER:	MOHAMED AHSAN	LOCATION:	N. KENDIKOLUDHOO				
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LEGEND

	P23	FAN / LIGHT DIMMER SWITCH
	V01b	DIA. 1200 CEILING FAN

GROUND FLOOR FAN LAYOUT PLAN
SCALE 1:100

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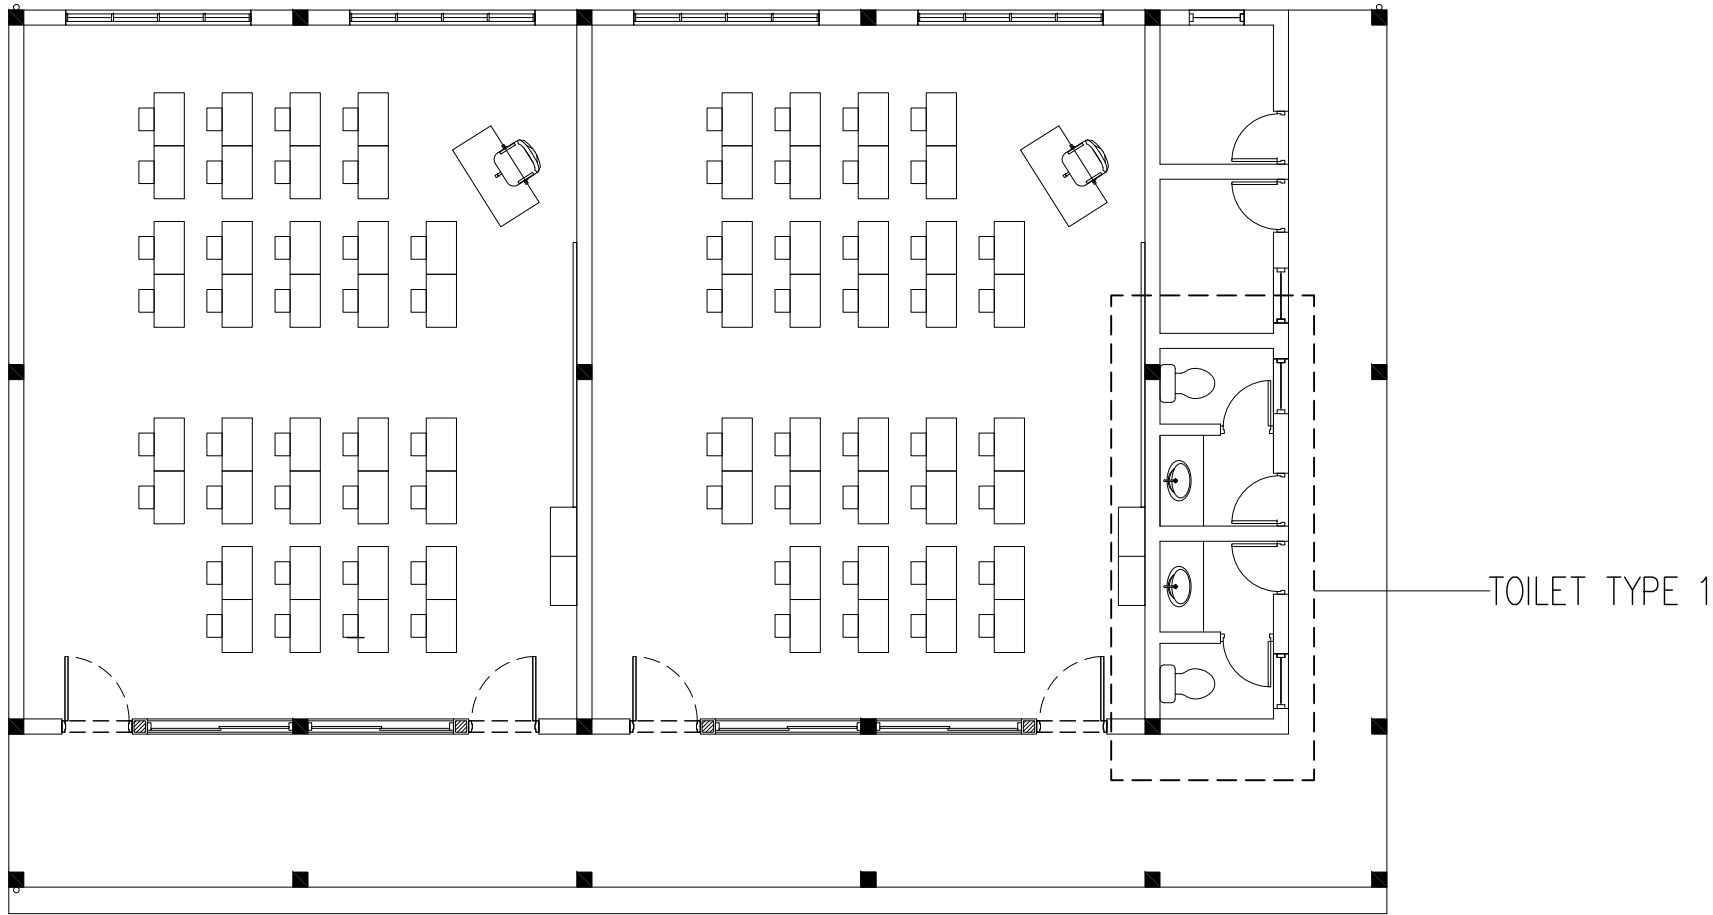
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E-03

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GROUND FLOOR PLUMBING KEY PLAN
SCALE 1:100

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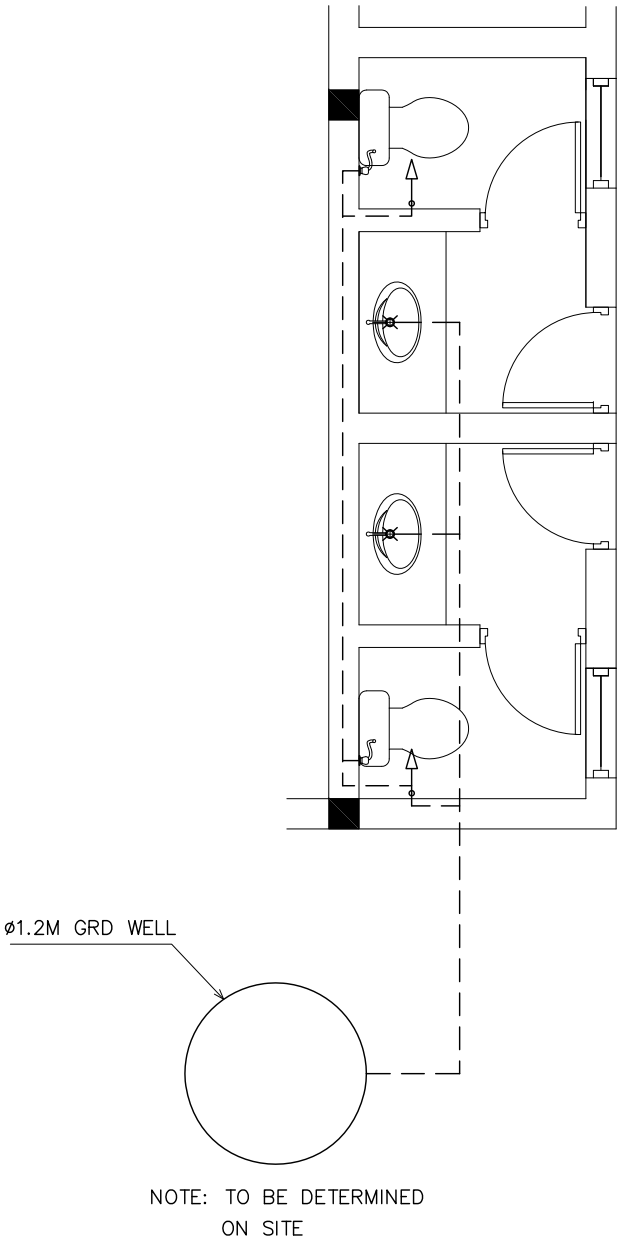
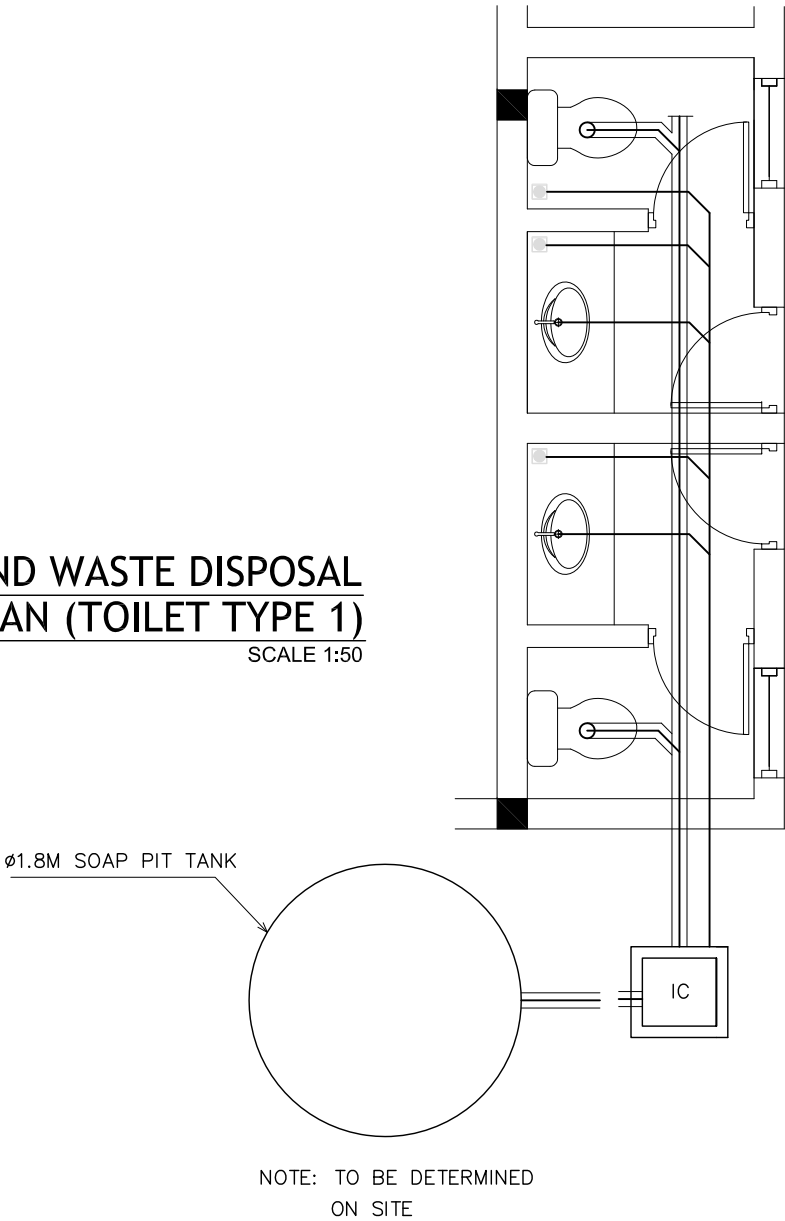
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SEWAGE AND WASTE DISPOSAL
PLAN (TOILET TYPE 1)
SCALE 1:50



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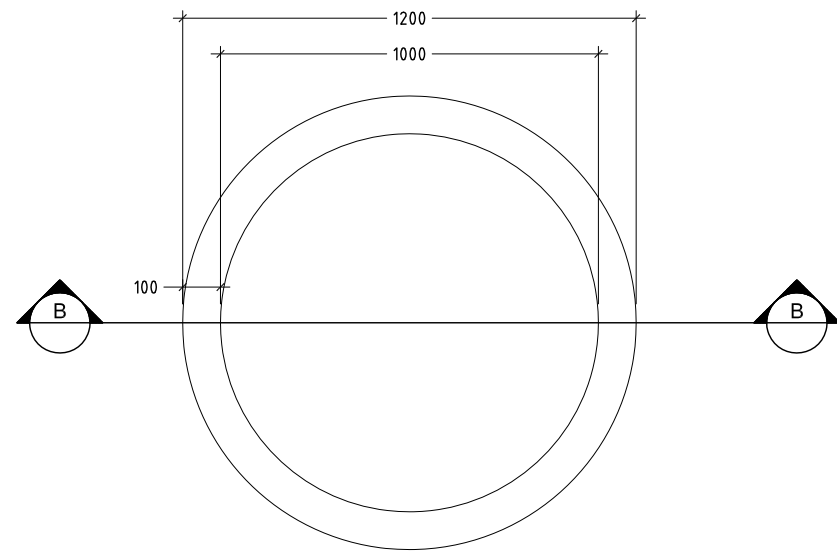
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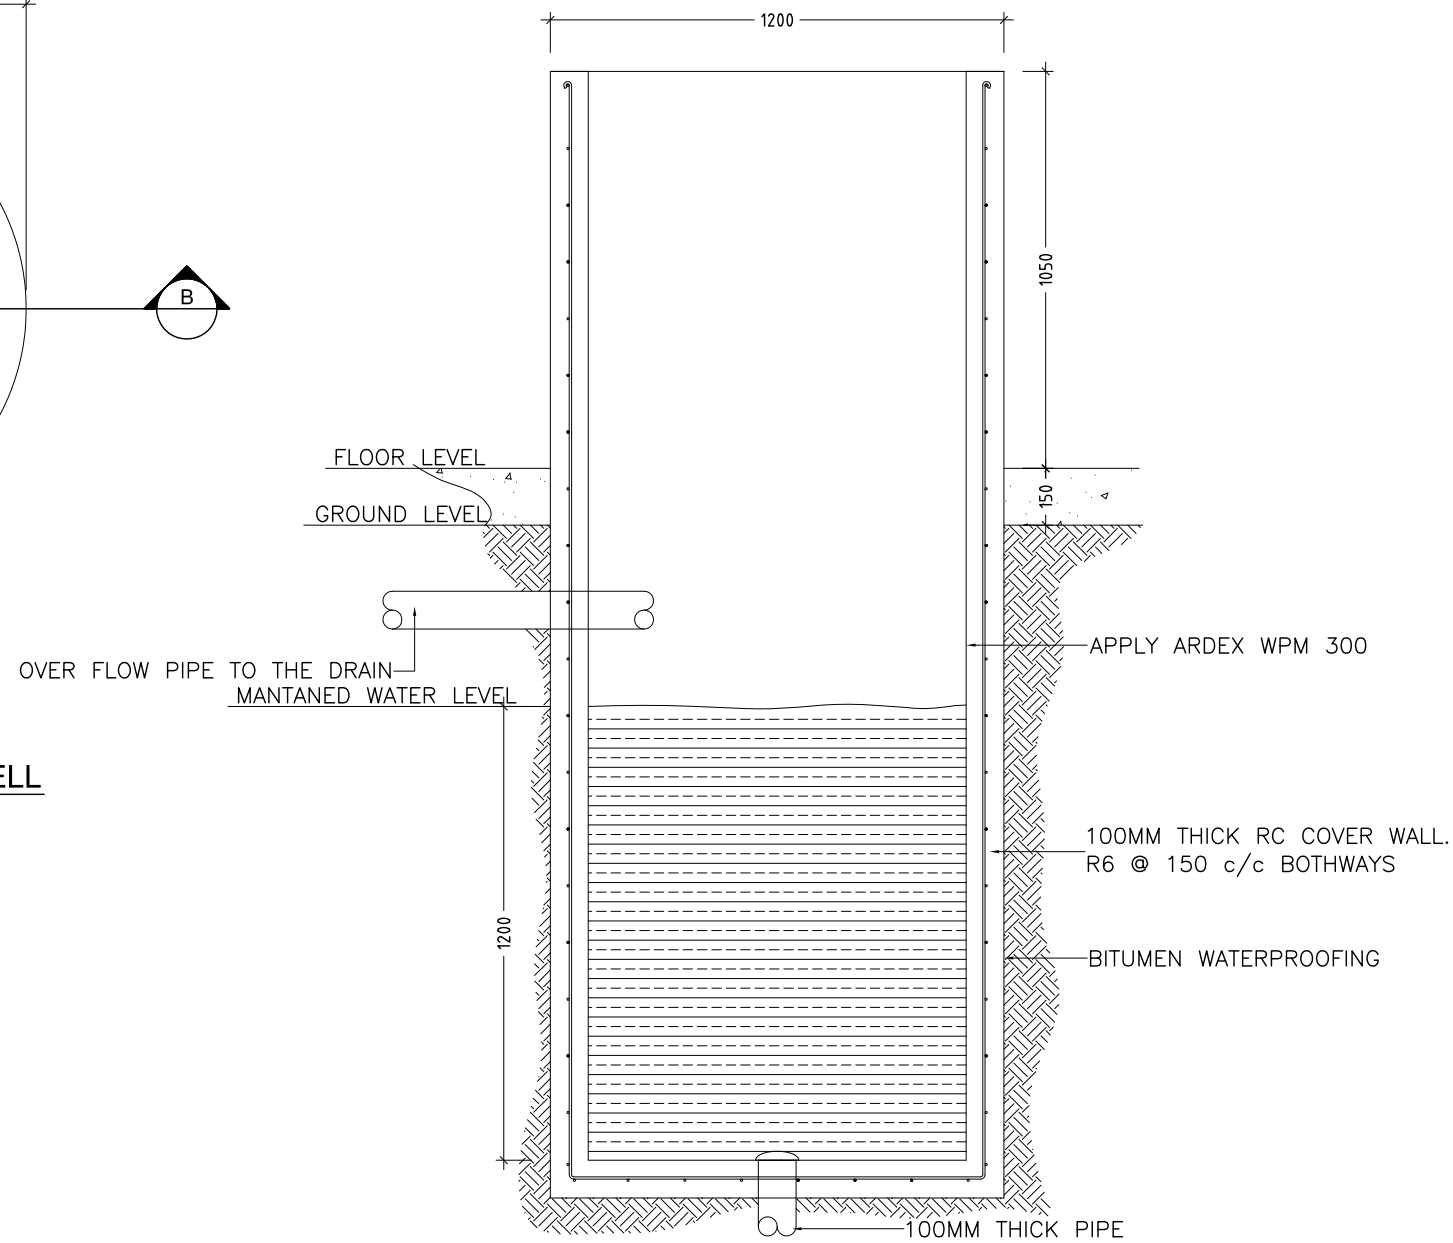
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P-02	DWG NO
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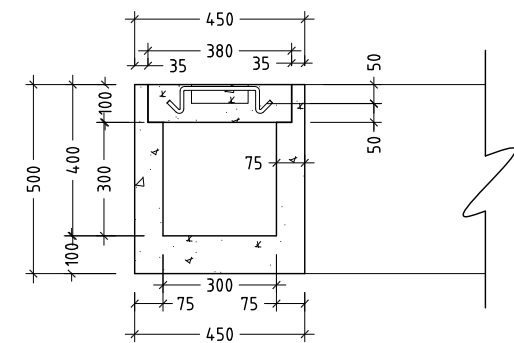
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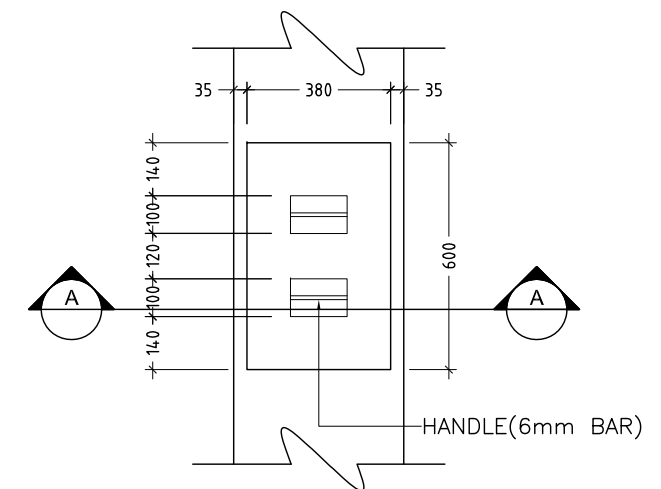
DETAIL B/ PLAN VIEW OF WELL
SCALE 1 : 20



DETAIL B/ SECTION A-A OF WELL
SCALE 1 : 20



DETAIL A/ SECTION A-A
SCALE 1 : 20



DETAIL A / PLAN VIEW OF INSPECTION POINT
SCALE 1 : 20

CONTRACTORS MUST
CHECK ALL
DIMENSIONS ON SITE
BEFORE STARTING
ANY WORK OR SHOP
DRAWINGS, FIGURED
DIMENSIONS TO TAKE
PRECEDENCE OVER
SCALE READINGS



REVISION:

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SERVICES ENG:

ESTIMATOR:

DRAWN BY: ASFAN AHMED

PROJECT: PROPOSED LEARNING CENTRE

LOCATION: N. KENDIKOLUDHOO

DRAWING TITLE: AS GIVEN

CLIENT: MALDIVES NATIONAL UNIVERSITY

SCALE: AS GIVEN

DIMENSION: MM

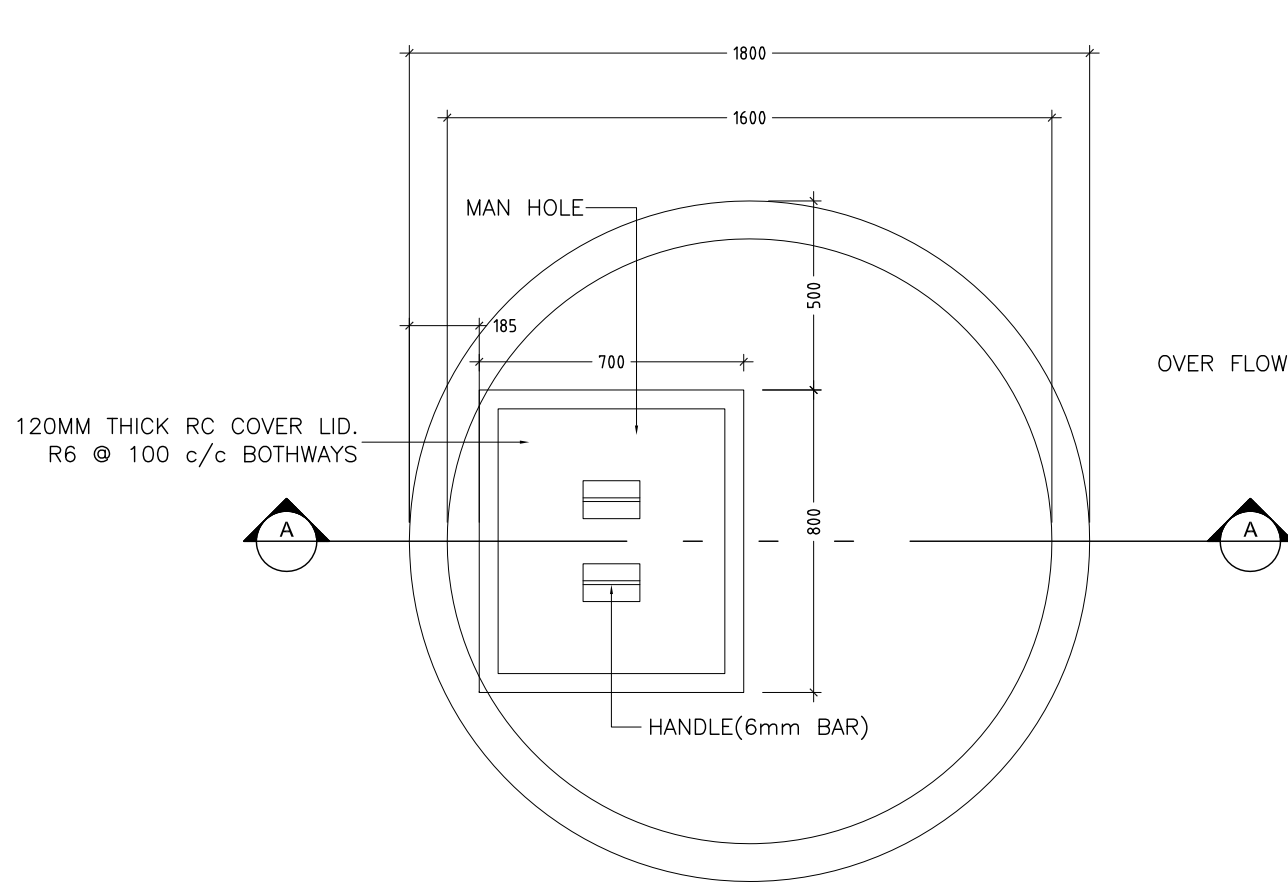
DATE: JANUARY 2016

P-03

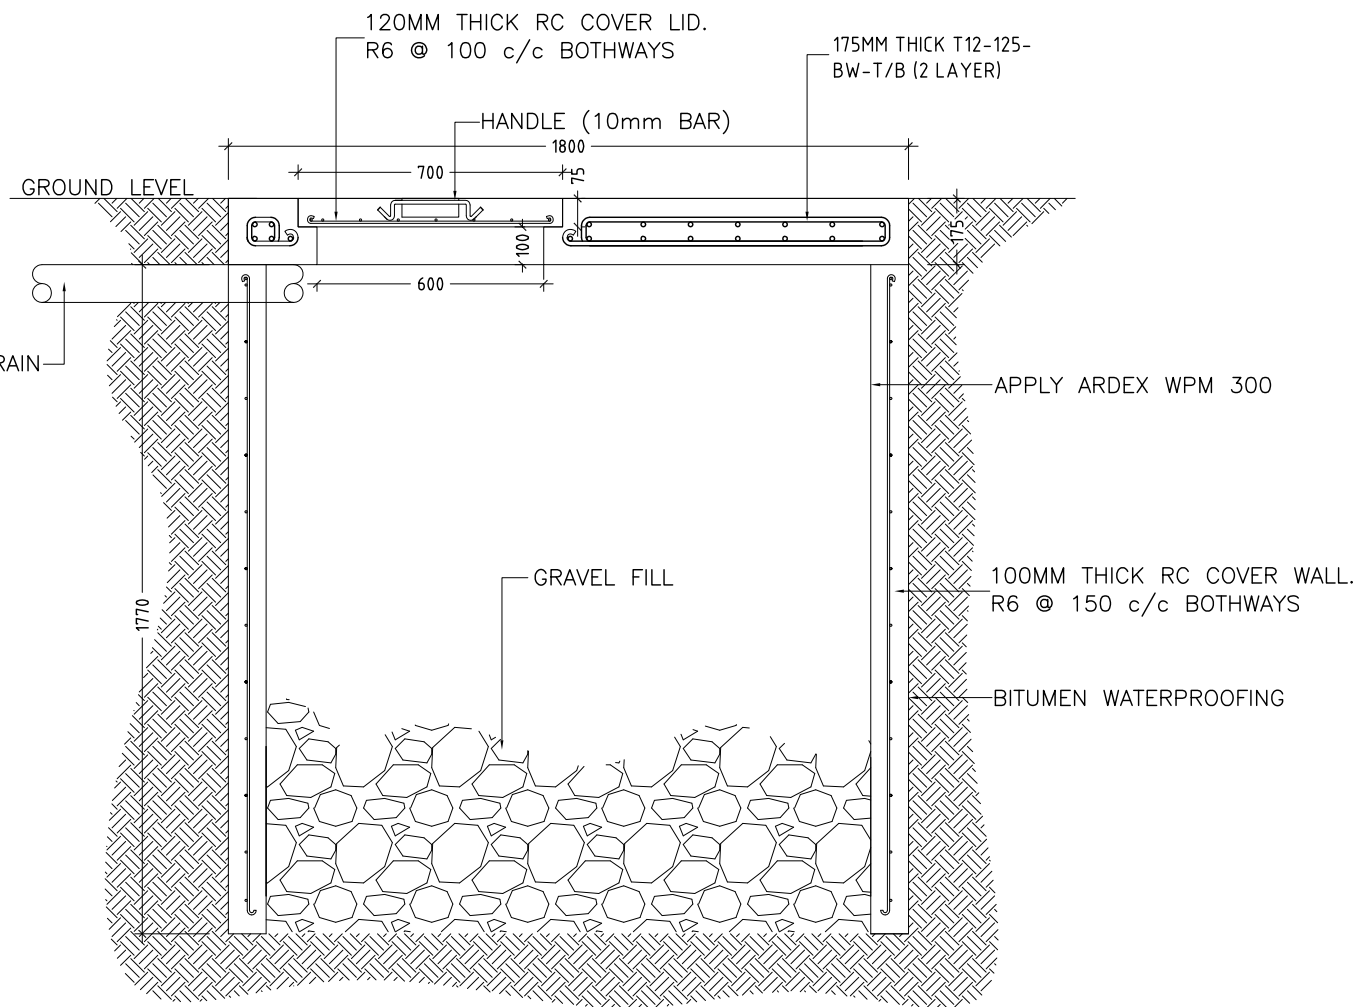
DWG NO

PROJECT NO.: 16-008

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DETAIL A/ PLAN VIEW OF SOAK PIT TANK
SCALE 1 : 20



DETAIL A/ SECTION A-A OF SOAK PIT TANK
SCALE 1 : 20

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PRECEDENCE OVER
SCALE READINGS

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PROJECT: PROPOSED LEARNING CENTRE
LOCATION: N. KENDIKOLUDHOO
DRAWING TITLE: AS GIVEN
CLIENT: MALDIVES NATIONAL UNIVERSITY
SCALE: AS GIVEN DIMENSION: MM DATE: JANUARY 2016

P-04

DWG NO

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