

Proposed 02 Classroom, Health Room & Science Lab at
Th.Omadhoo School
(02 Storey)

ARCHITECTURAL & STRUCTURAL DRAWINGS
Client: Ministry of Education



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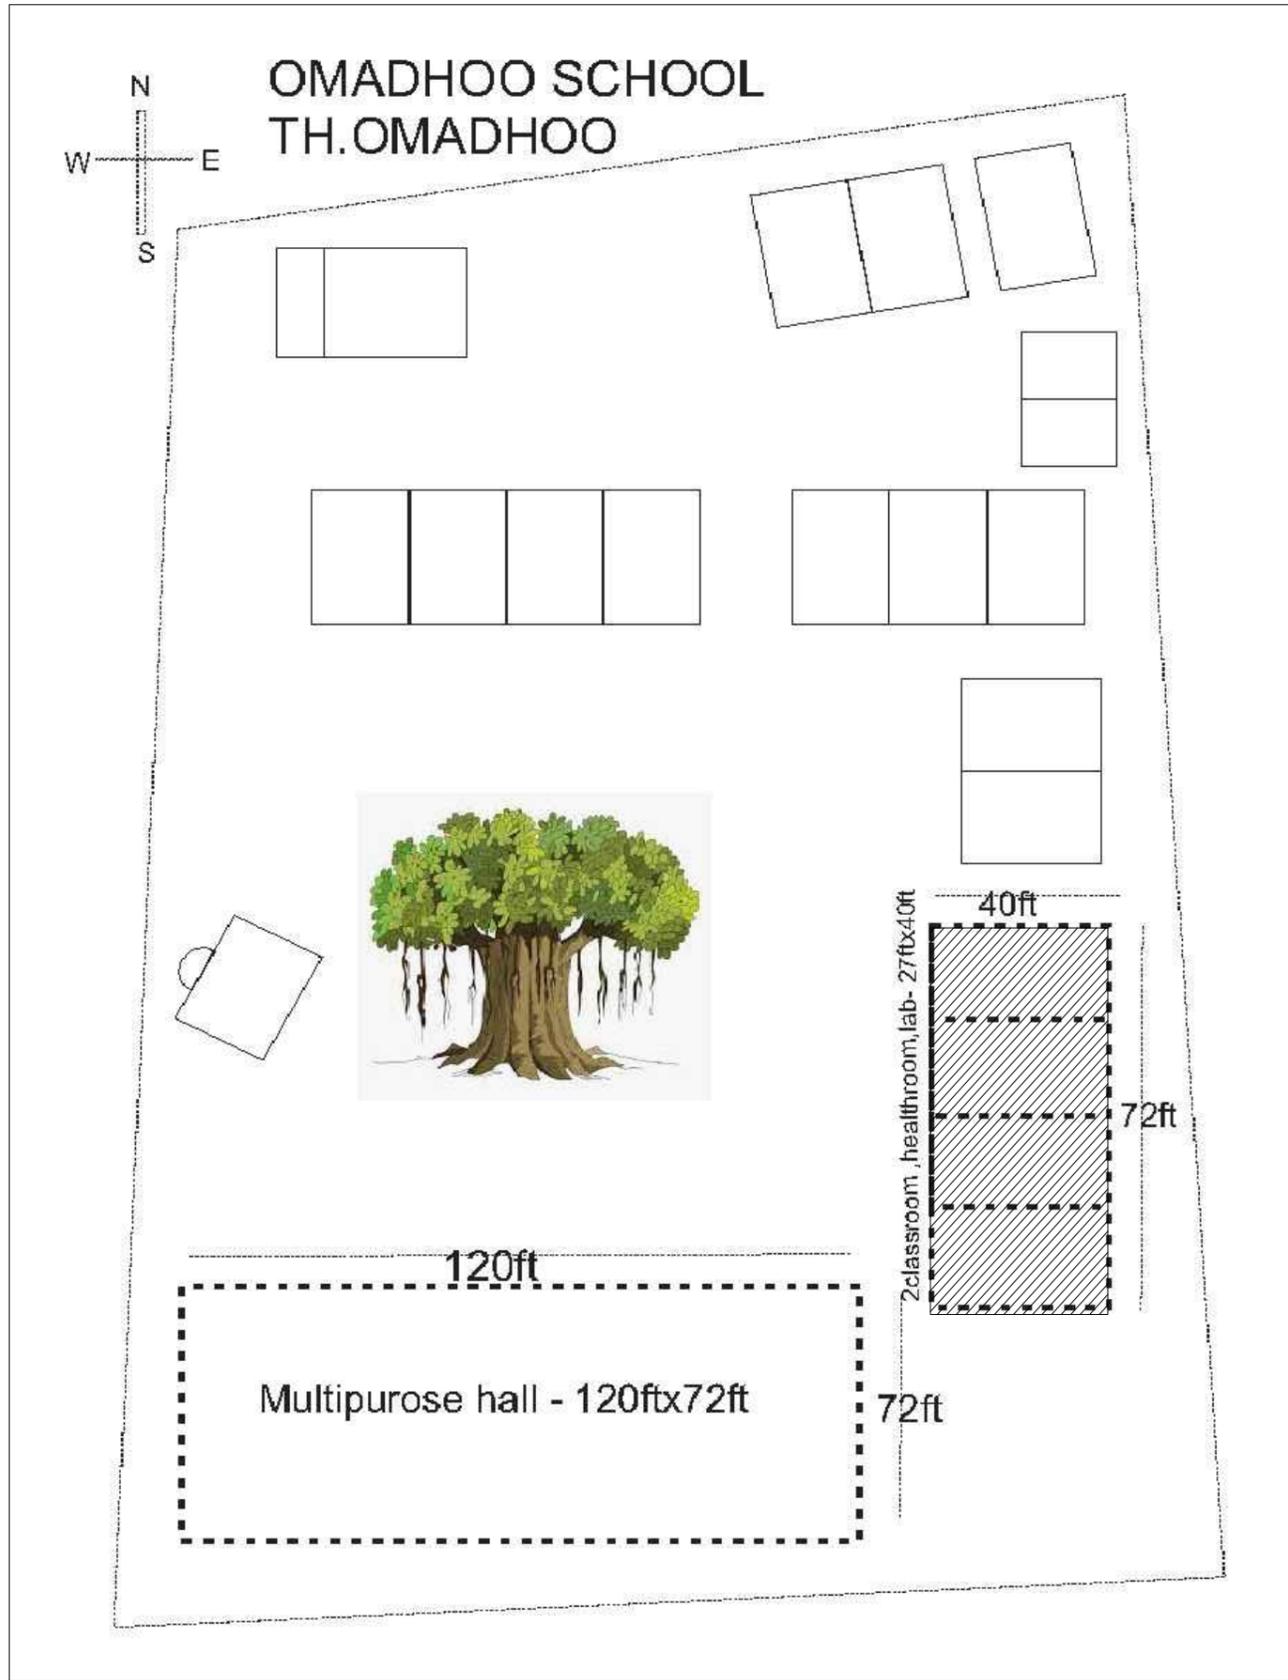
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3rd floor, H. Azum, Ameenemagu, Male'

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SITE PLAN
NTS



NOTE:
 PROPOSED BUILDING LOCATION
 PLAY AREA TO BE DEMOLISHED OR RELOCATED - TO BE CONFIRMED FROM THE SCHOOL


Th. Omadhoo School Health Room, Science Lab & 2 Classroom Block (2 story)
 Client: Ministry of Education

Project Number: RI/2020/006	Date
Date: April 2021	
Architect: Mariyam Irasha Shareef	
Engineer: Mohamed Muhtalib Waleed	
Drawn by: Mariyam Leevan Jaleel	
Services: Aishath Ahmed Interior	



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GROUND FLOOR PLAN

SCALE 1:100

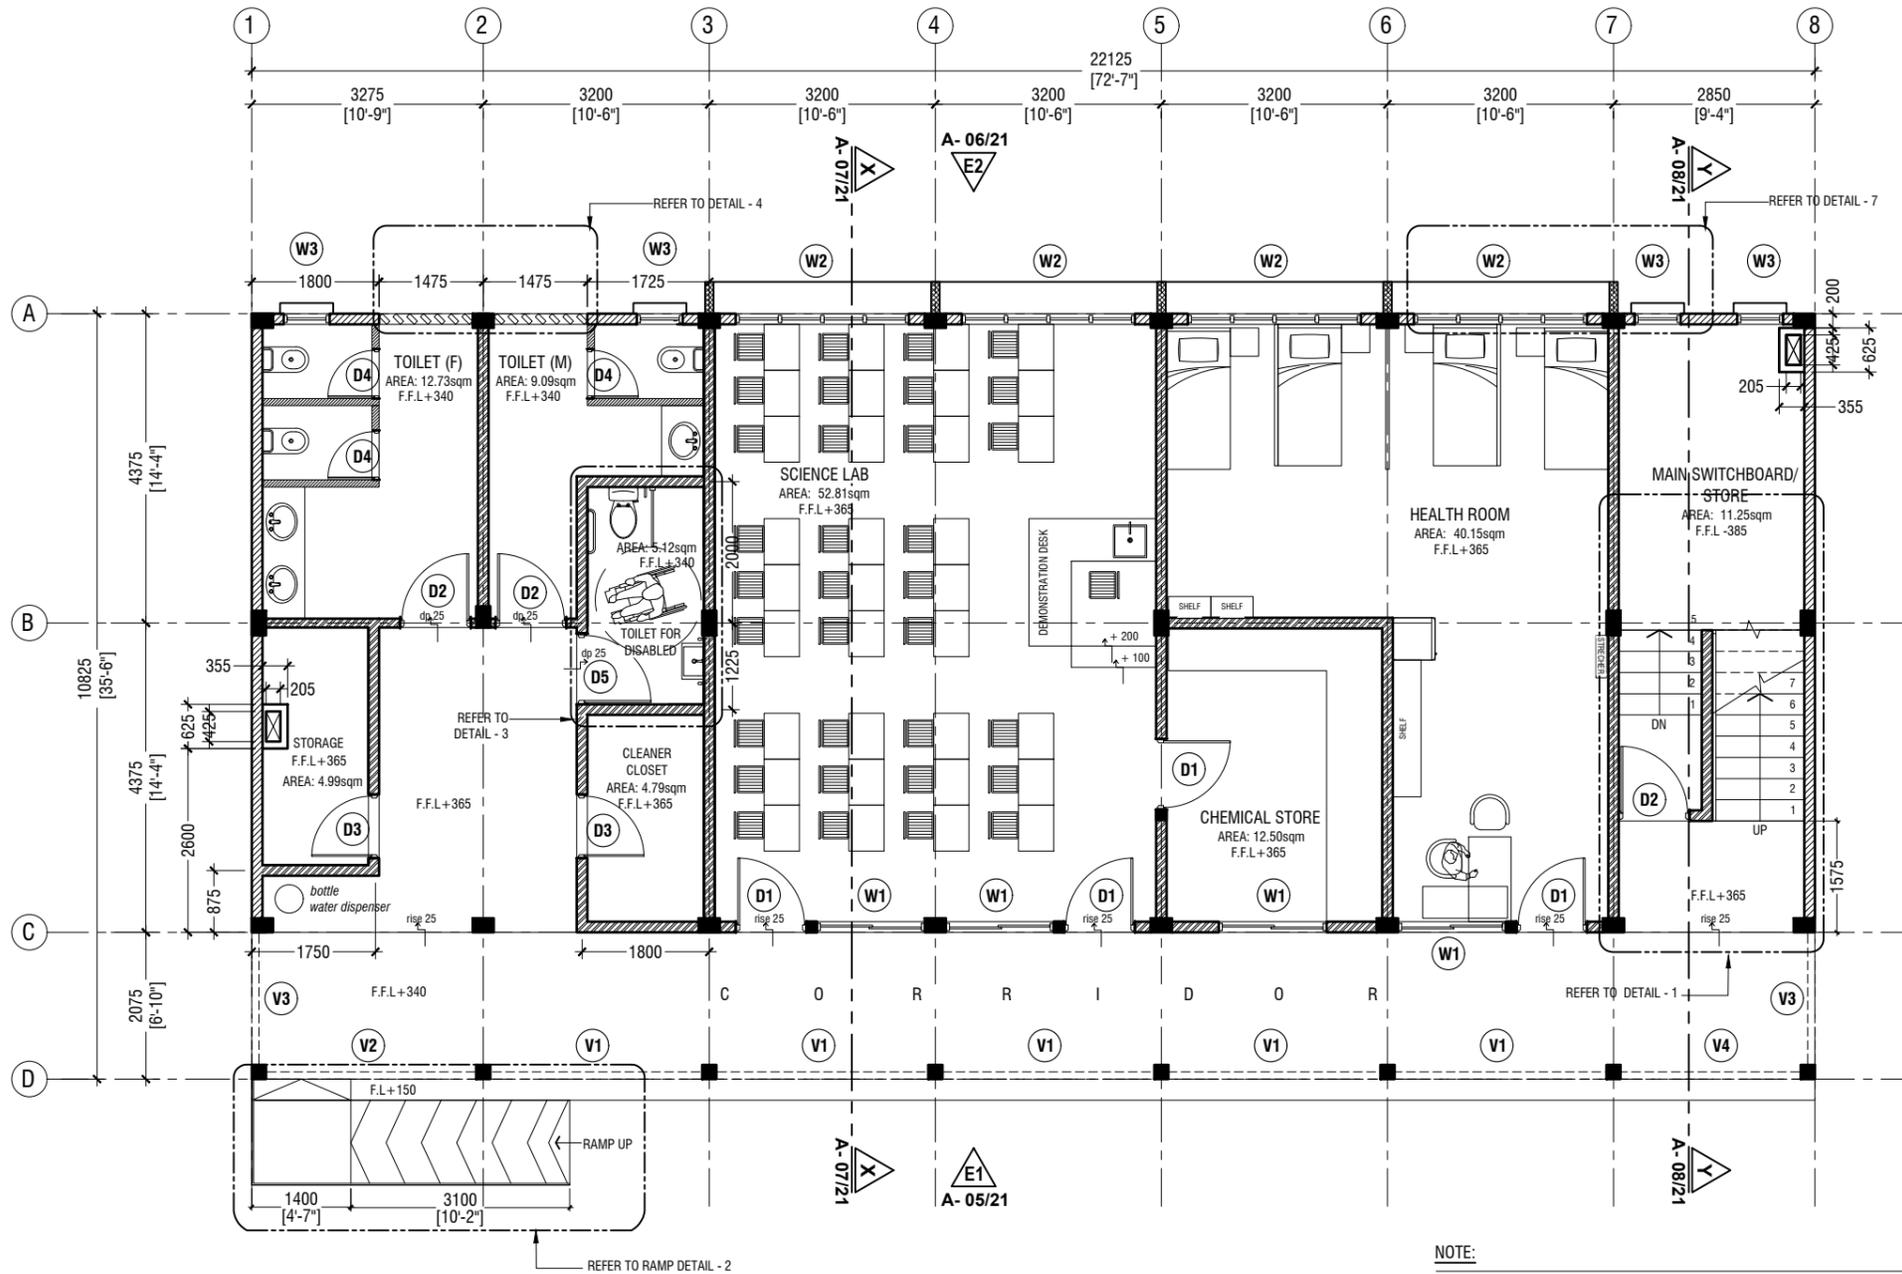

NOTE:

- PROPOSED 150mm THICK SOLID BLOCK - INTERIOR MASONRY WALL WITH 16mm PLASTERING, GROUND SMOOTH IN SELECTED PAINT FINISH
- PROPOSED 150mm THICK SOLID BLOCK - EXTERIOR MASONRY WALL WITH 20mm PLASTERING, GROUND SMOOTH IN SELECTED PAINT FINISH
- PROPOSED 100mm THICK SOLID BLOCK - INTERIOR MASONRY WALL WITH 16mm PLASTERING, GROUND SMOOTH IN SELECTED PAINT FINISH
- PROPOSED 120mm THICK RC WALL TO BE WATER PROOFED WITH WATER PROOFING AGENT
- PROPOSED 100mm THICK 2400mm HIGH SOLID BLOCK MASONRY WALL WITH 16mm PLASTERING, GROUND SMOOTH IN SELECTED PAINT FINISH

THE SCREEDING AND TILES ARE INCORPORATED IN THE FLOOR FINISH LEVELS

REFER TO ARCHITECT FOR FURTHER ASSISTANCE.

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Project Number: RI/2020/006

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Services: Aishath Ahmed Interior

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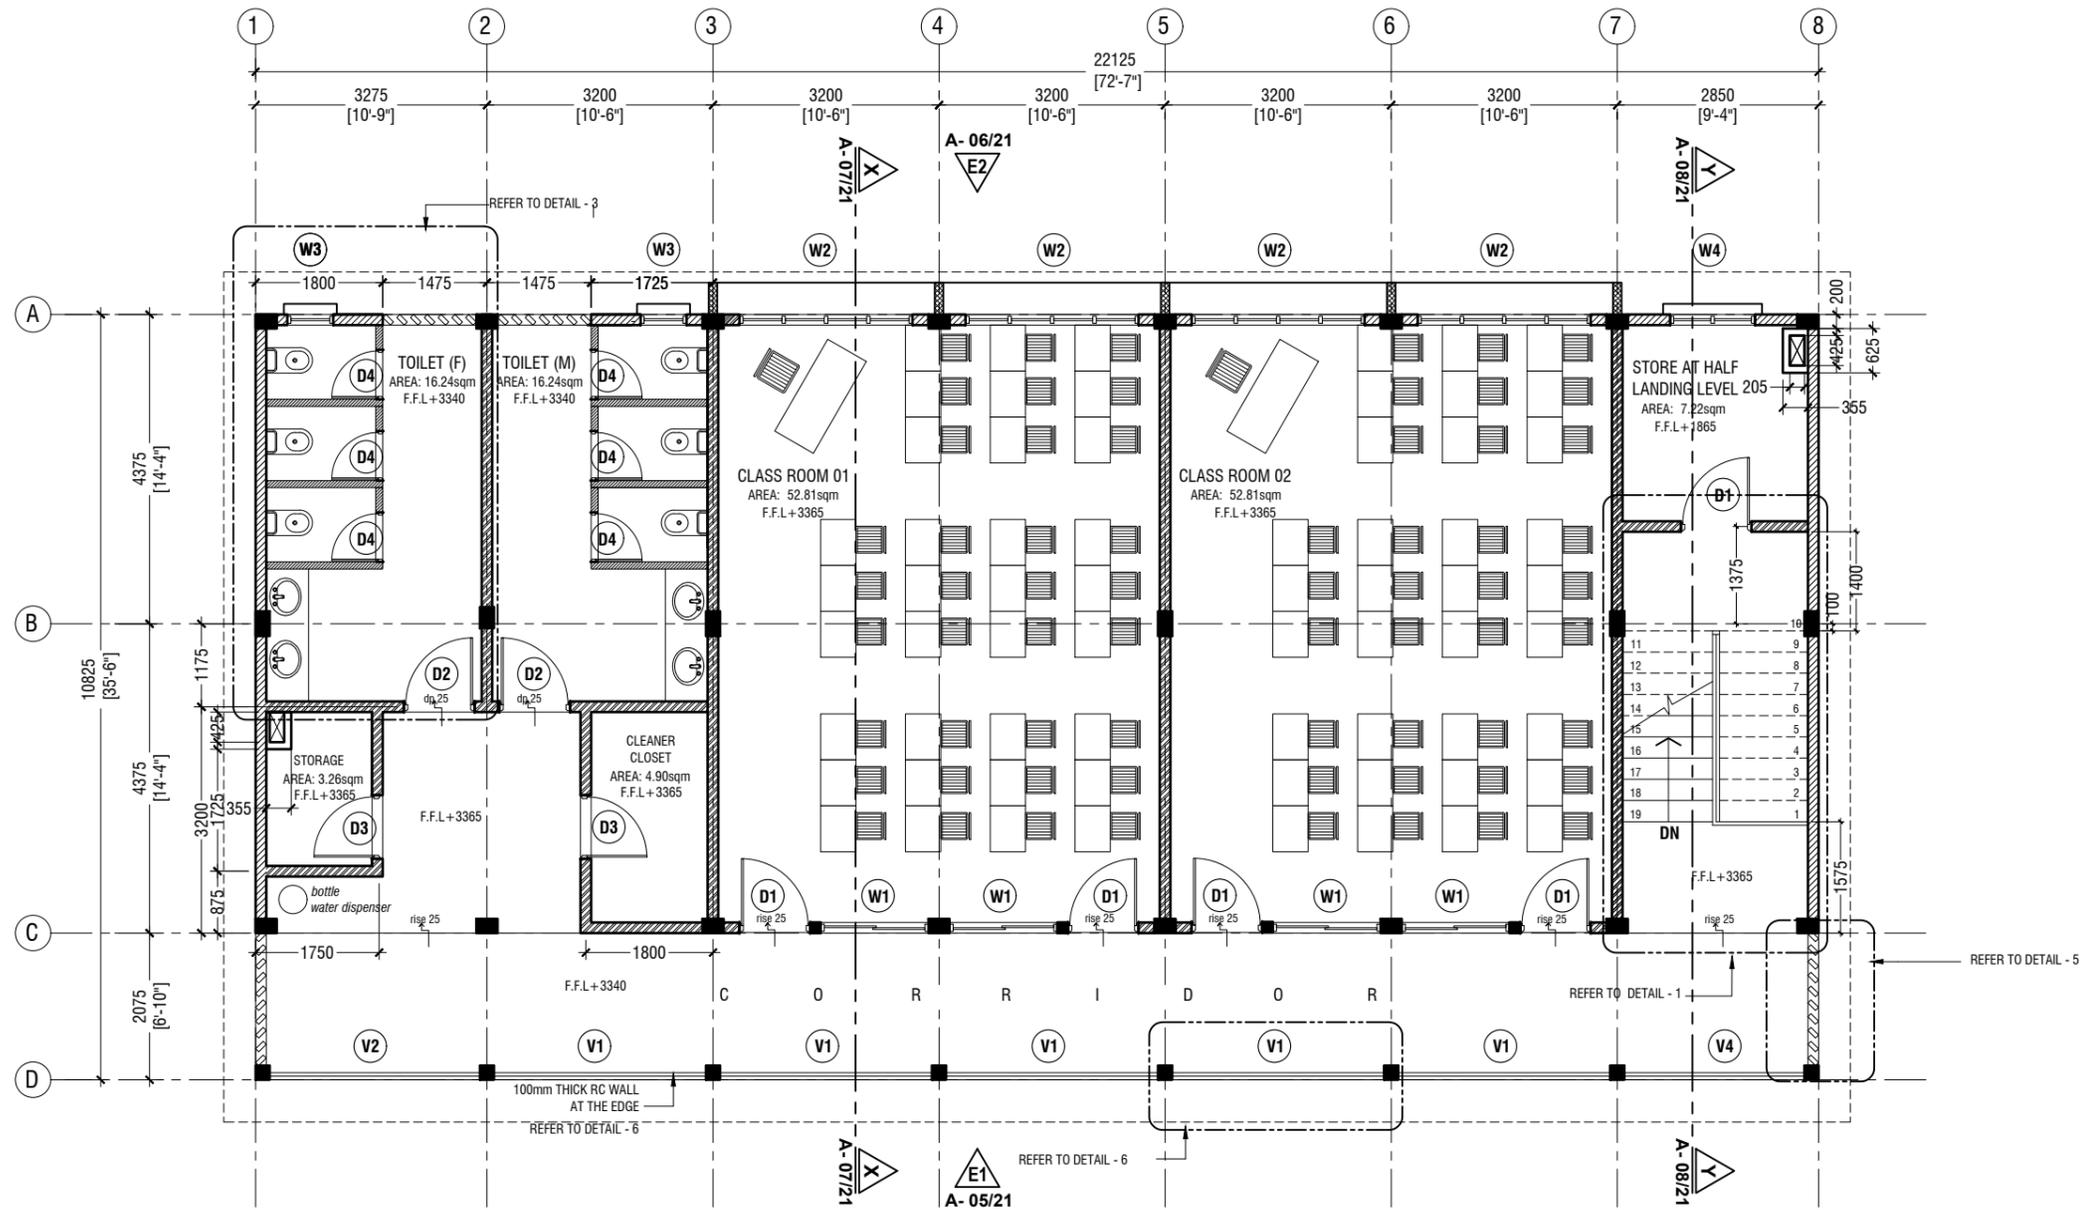
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Title: Ground Floor Plan

Page: A-02/21

FIRST FLOOR PLAN

SCALE 1:100



NOTE:

- PROPOSED 150mm THICK SOLID BLOCK - INTERIOR MASONRY WALL WITH 16mm PLASTERING, GROUND SMOOTH IN SELECTED PAINT FINISH
- PROPOSED 150mm THICK SOLID BLOCK - EXTERIOR MASONRY WALL WITH 20mm PLASTERING, GROUND SMOOTH IN SELECTED PAINT FINISH
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Services: Aishath Ahmed Interior

Rev no

Date



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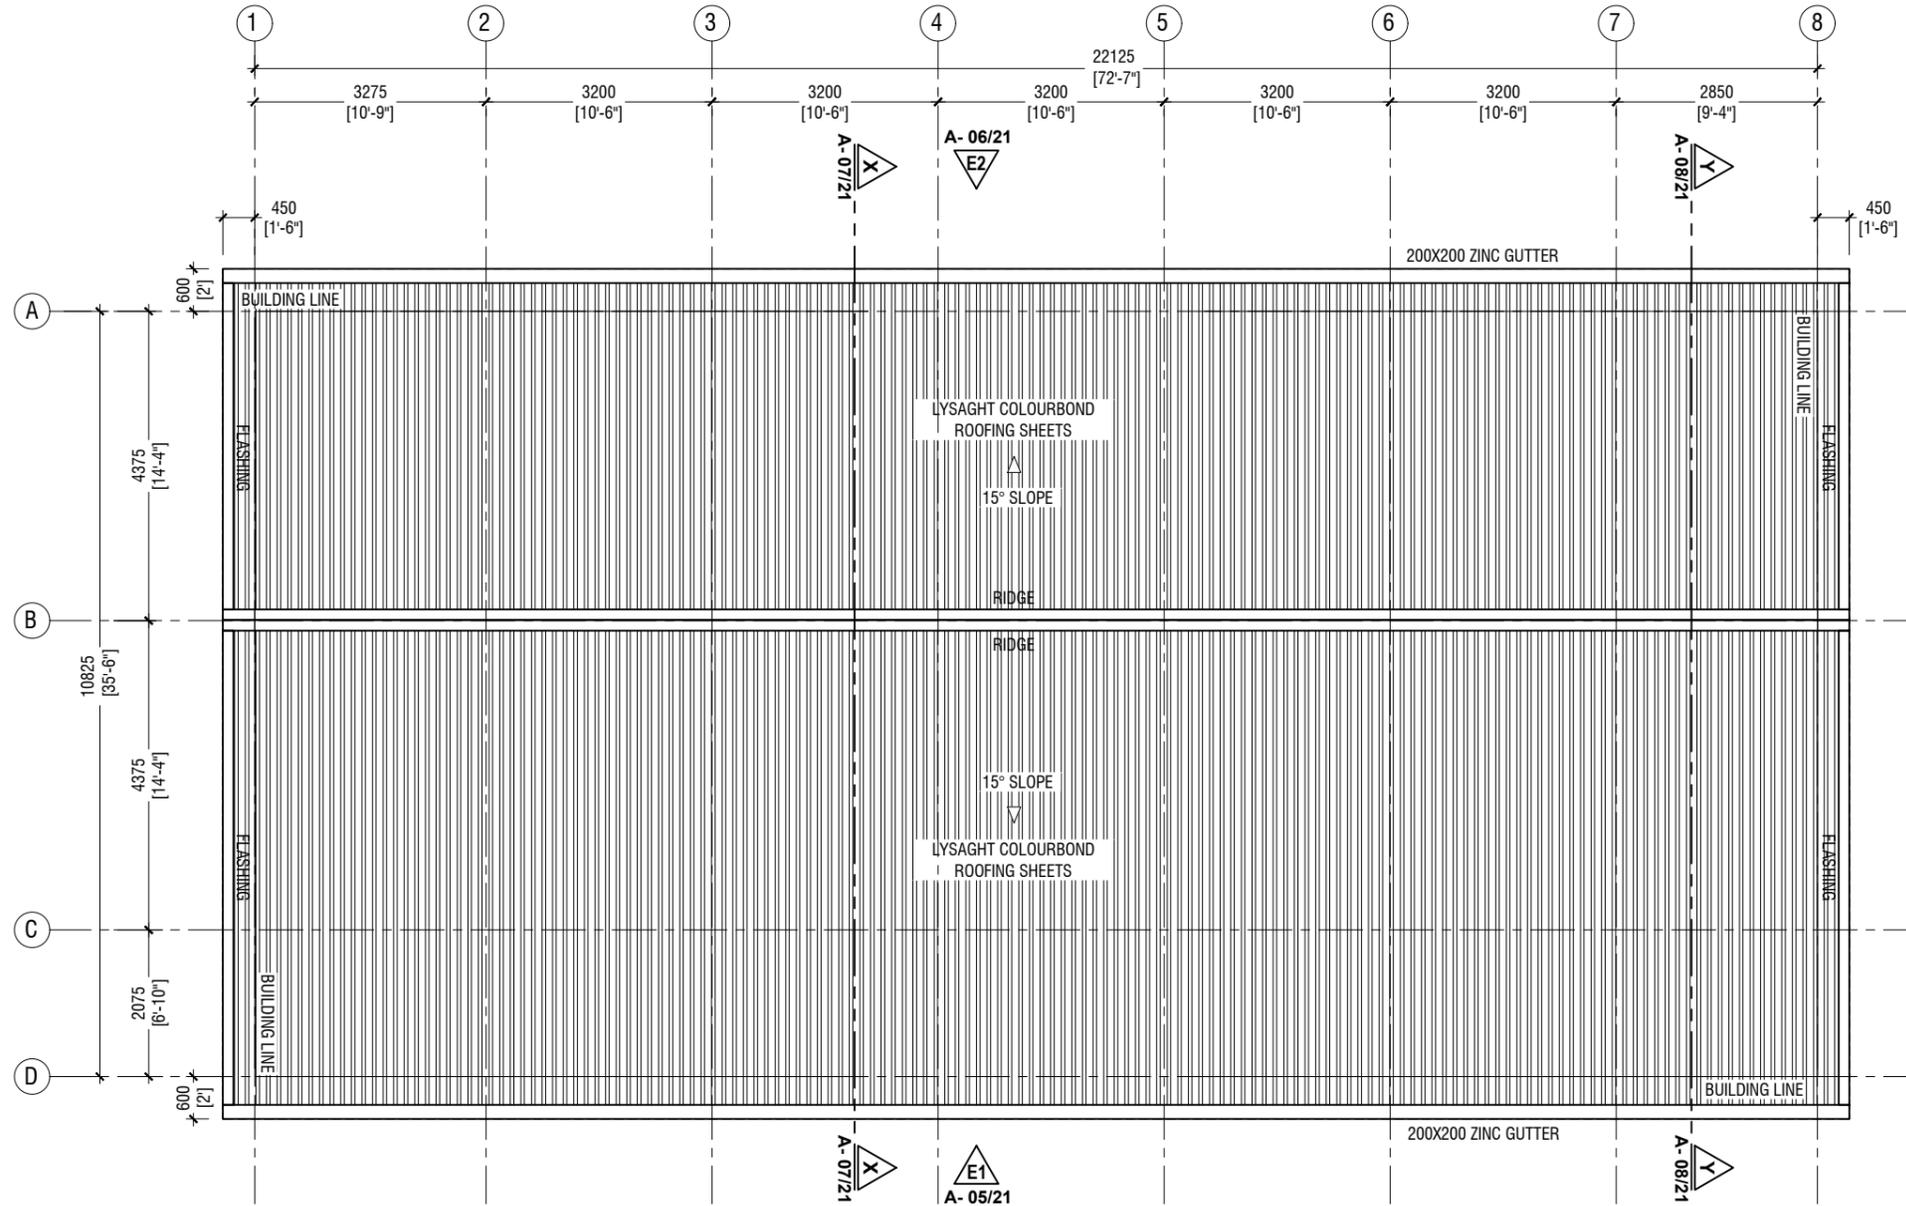
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Title: First Floor Plan

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ROOF PLAN

SCALE 1:100



NOTE:

ROOF SLOPE : 15° SLOPE

ROOF MATERIAL : LYSAGHT COLOURBOND ROOFING SHEETS

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Title: Roof Plan

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ELEVATION E1

SCALE 1:100



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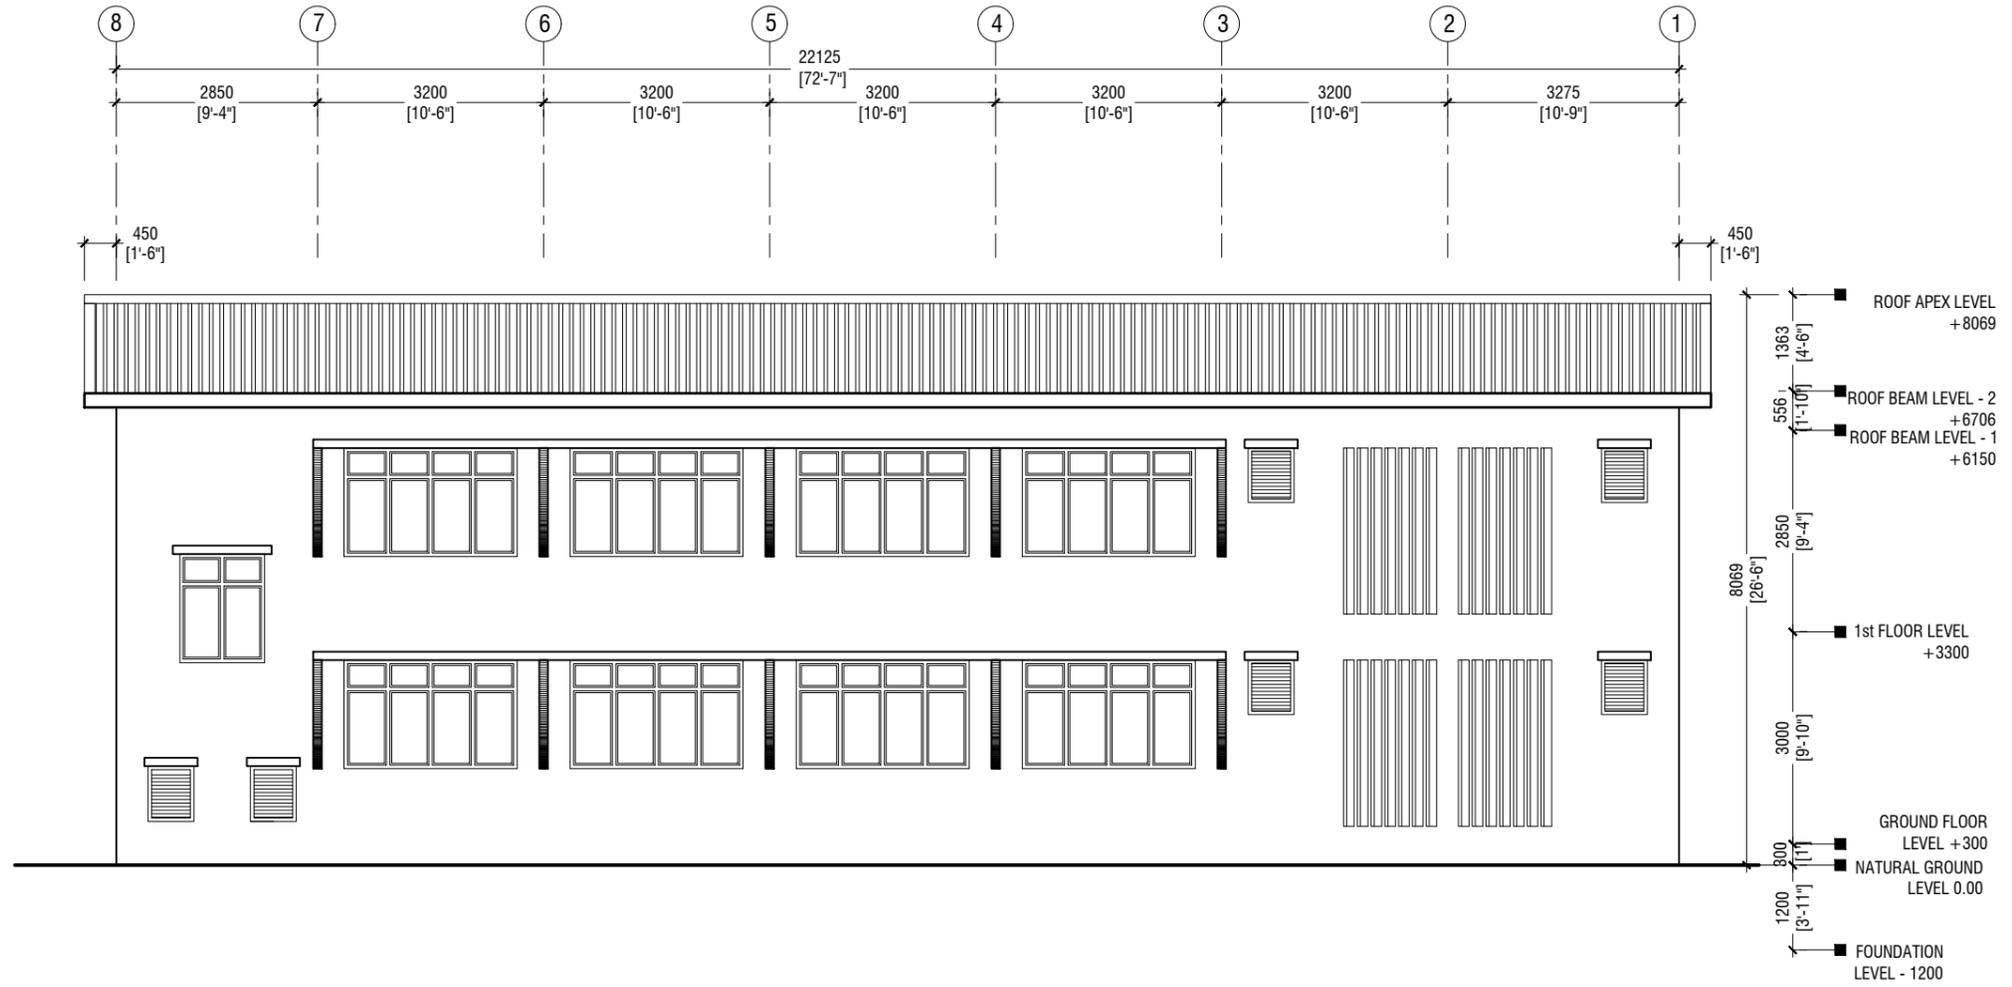


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Title: Elevation - E1

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ELEVATION E2

SCALE 1:100



Th.Omadhoo School Health Room, Science Lab & 2 Classroom Block (2 story)
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Project Number: RI/2020/006
 Date: April 2021
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 Services: Aishath Ahmed Interior



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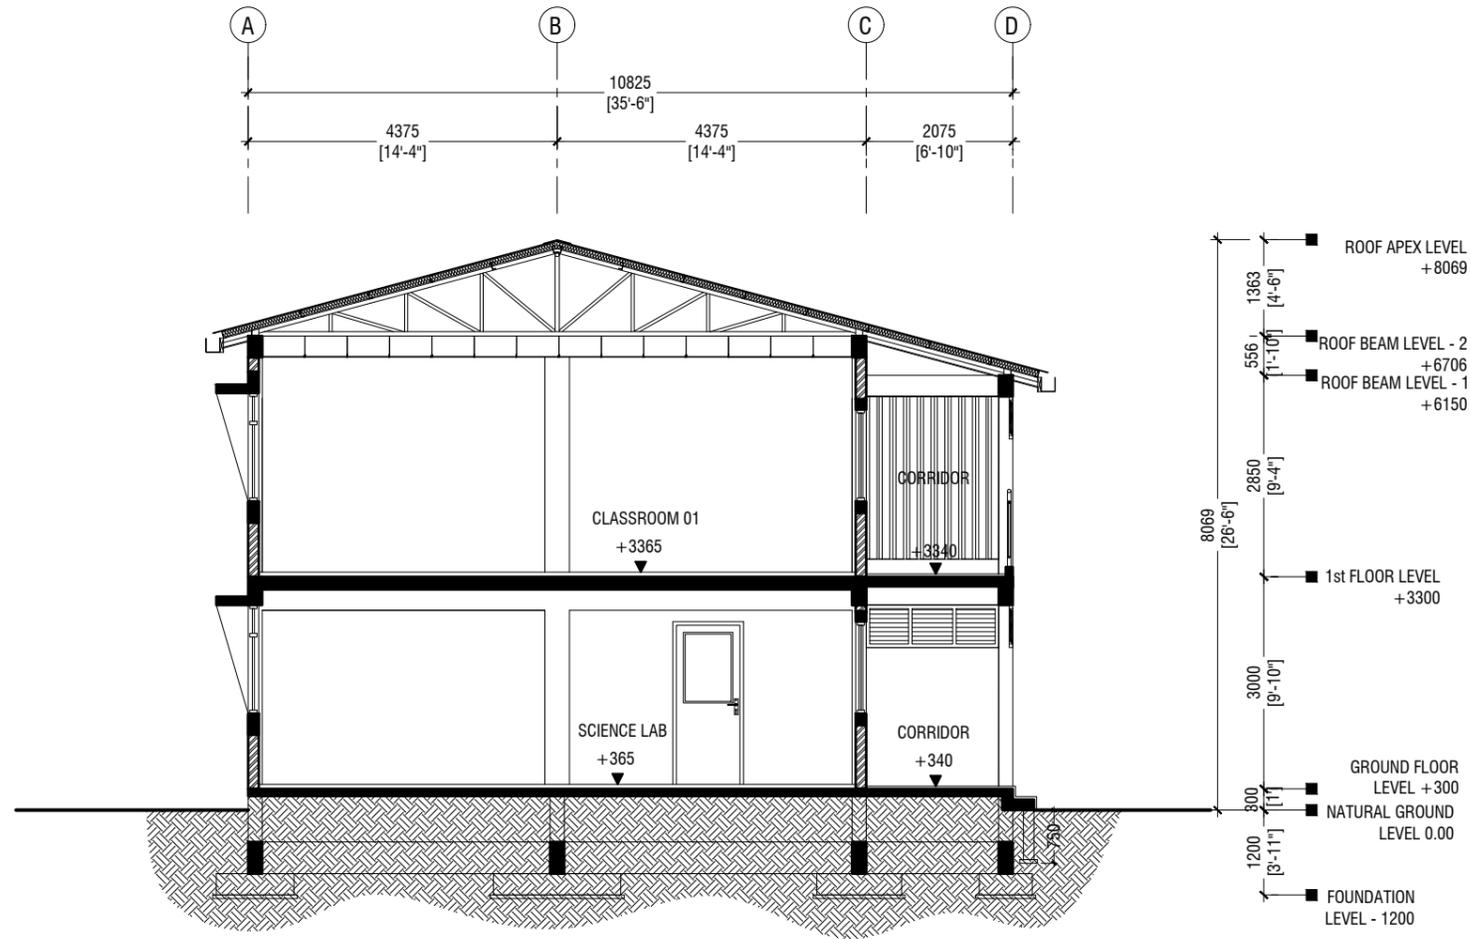
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SECTION X-X

SCALE 1:100



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 Engineer: Mohamed Muhtalib Waleed
 Drawn by: Mariyam Leevan Jaleel
 Services: Aishath Ahmed Interior

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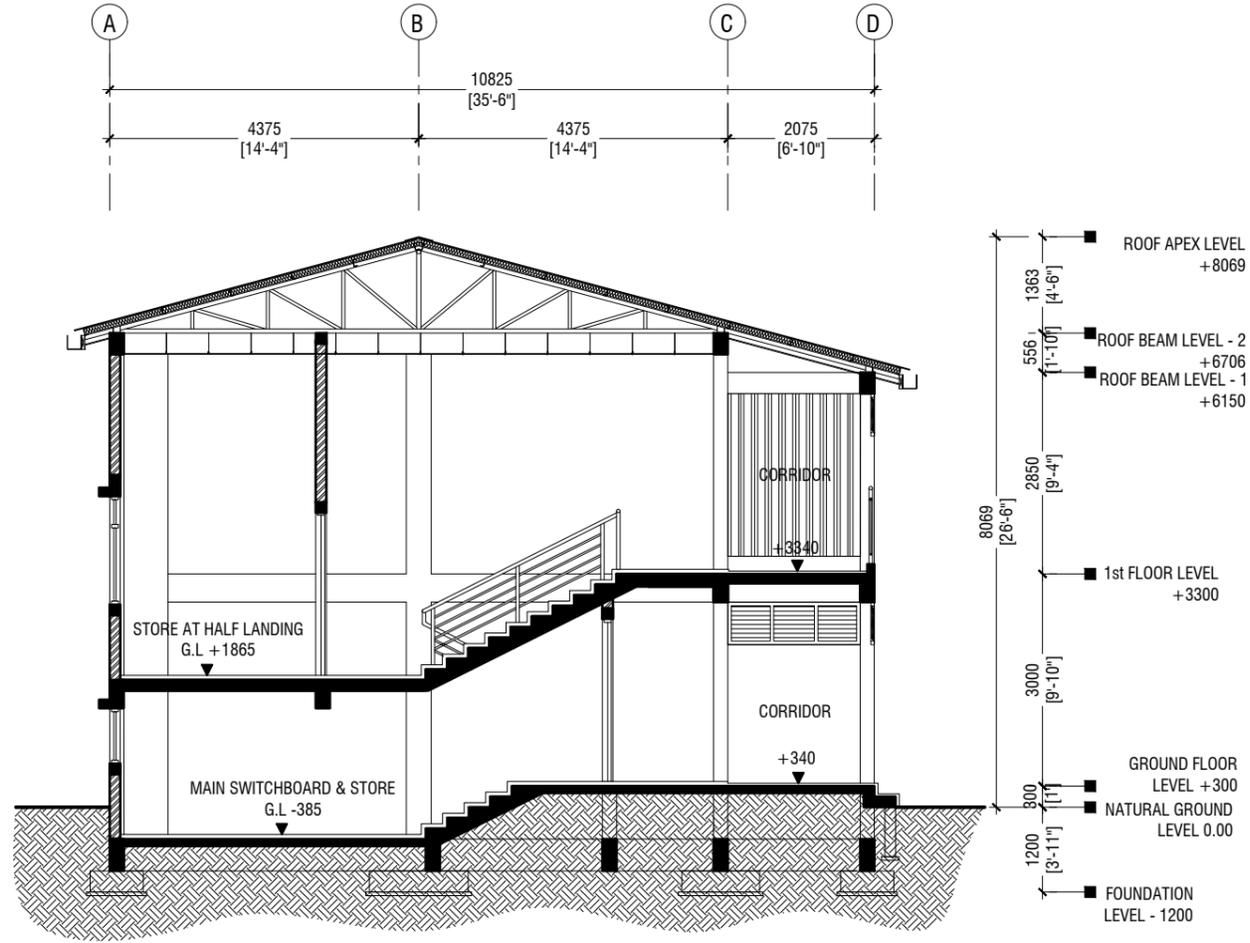
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SECTION Y-Y

SCALE 1:100



Th.Omadhoo School Health Room, Science Lab & 2 Classroom Block (2 story)
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 Services: Aishath Ahmed Interior

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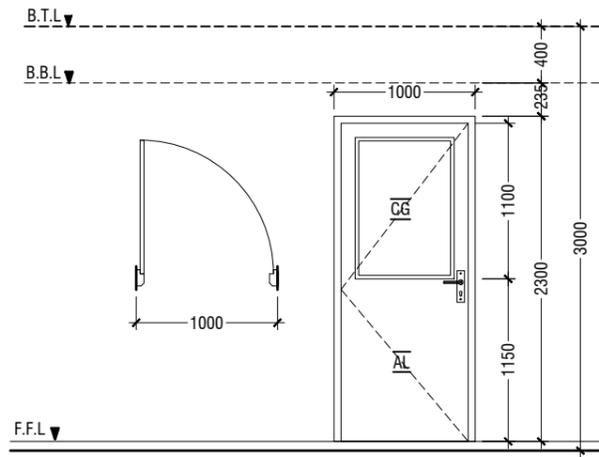
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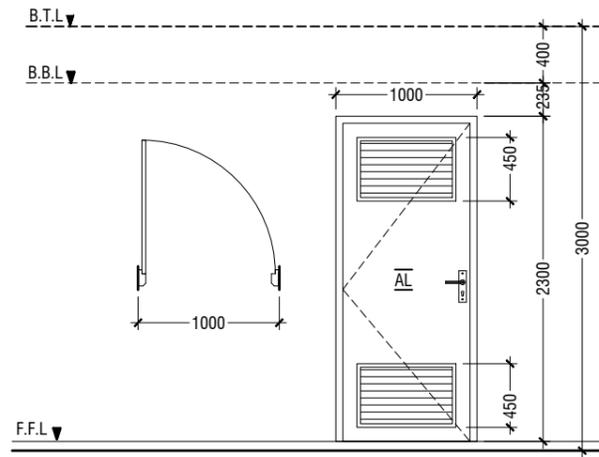
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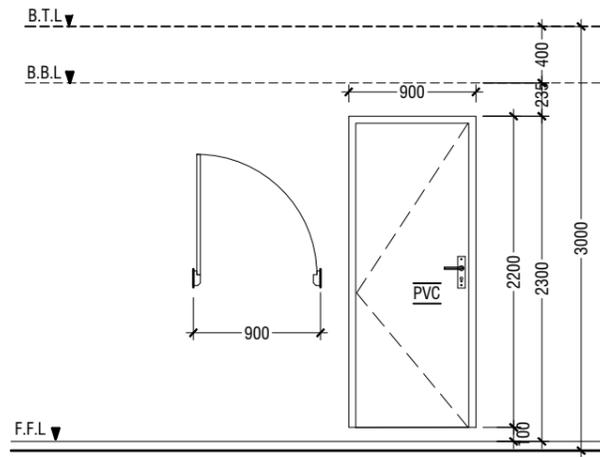
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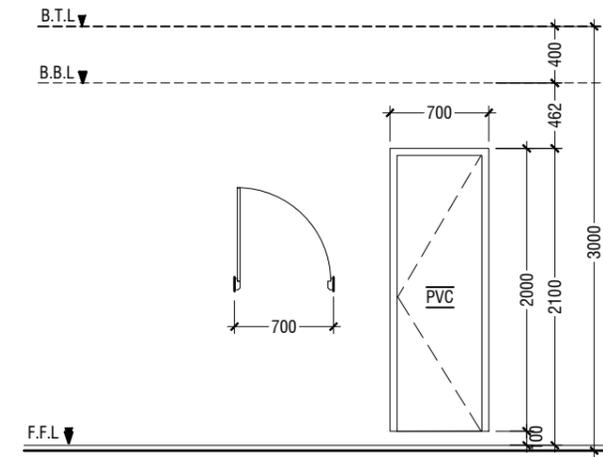
D1	SWING DOOR
REMARKS	50mm THICK WHITE POWDER COATED (60 MICRONS) ALUMINUM FRAMED WITH ALUMINIUM PANEL AND 6mm THICK CLEAR GLASS
LOCATION	CLASSROOMS & HALF LANDING STORE ROOM
QUANTITY	09 NOS
OPEN AREA	2.03 sqm








D2	SWING DOOR WITH ALUMINIUM LOUVERS
REMARKS	50mm THICK WHITE POWDER COATED (60 MICRONS) ALUMINUM FRAMED WITH ALUMINIUM PANEL AND ALUMINIUM LOUVERS
LOCATION	TOILETS & MAIN SWITCH BOARD STORE
QUANTITY	05 NOS
OPEN AREA	2.03 sqm




D3	PVC SWING DOOR
REMARKS	PVC WHITE FRAME AND PANEL
LOCATION	STORE & CLEANER CLOSET
QUANTITY	04 NOS
OPEN AREA	1.72 SQM




D4	PVC SWING DOOR
REMARKS	PVC WHITE FRAME AND PANEL
LOCATION	TOILETS STALLS
QUANTITY	09 NOS
OPEN AREA	1.17 SQM

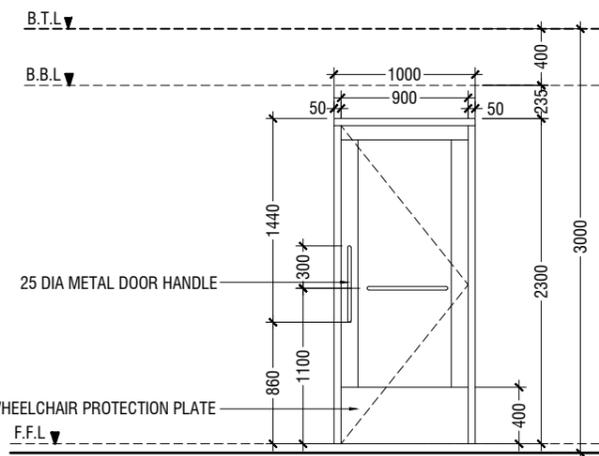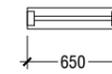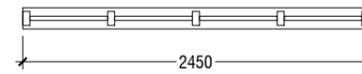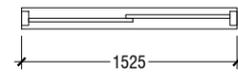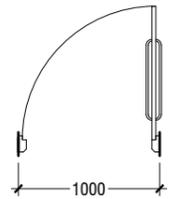


D5	SWING DOOR
REMARKS	50mm THICK WHITE POWDER COATED (60 MICRONS) ALUMINUM FRAMED WITH ALUMINIUM PANEL
LOCATION	DISABLED TOILET
QUANTITY	01 NOS
OPEN AREA	2.03 sqm

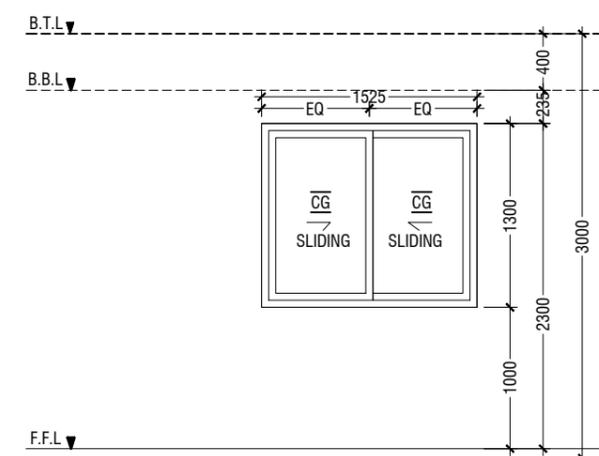

W1	SLIDING WINDOW
REMARKS	50mm THICK WHITE POWDER COATED (60 MICRONS) ALUMINUM FRAMED WITH ALUMINIUM PANEL AND 6mm THICK CLEAR GLASS
LOCATION	CLASSROOMS
QUANTITY	08 NOS
OPEN AREA	0.83 sqm

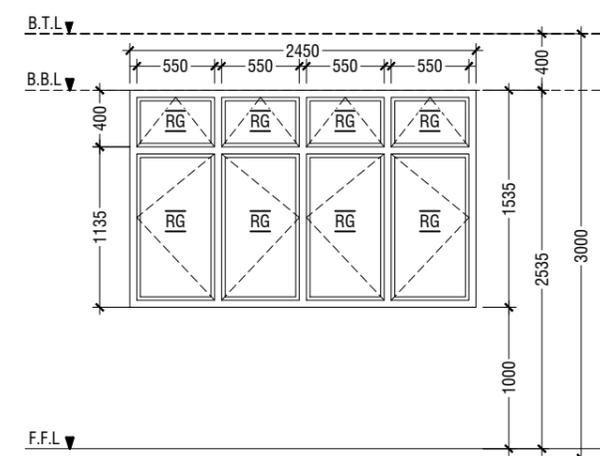

W2	SWING WINDOW
REMARKS	50mm THICK WHITE POWDER COATED (60 MICRONS) ALUMINUM FRAMED WINDOW WITH 6mm THICK REFLECTIVE GLASS
LOCATION	CLASSROOMS
QUANTITY	08 NOS
OPEN AREA	3.04 sqm

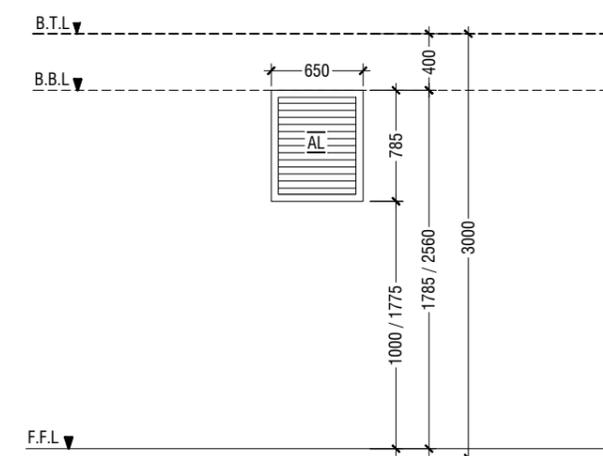

W3	WINDOW WITH ALUMINIUM LOUVERS
REMARKS	50mm THICK WHITE POWDER COATED (60 MICRONS) ALUMINUM FRAMED WITH ALUMINIUM LOUVERS
LOCATION	TOILETS & MAIN SWITCH BOARD STORE
QUANTITY	06 NOS
OPEN AREA	0.38 SQM

NOTE:-

1. FLOOR TO FLOOR HEIGHT VARIES AND WILL BE SUBJECTED TO CHANGES
2. MAINTAIN FLOOR TO WINDOW SILL STANDARD HEIGHT REGULATION OF 1M.
3. REFER TO ARCHITECT FOR FURTHER ASSISTANCE.
4. ALL DOORS & WINDOWS TO BE CHECKED ON SITE BEFORE FABRICATION.
5. ALL DOOR & WINDOWS VIEWED FROM EXTERIOR, FOR DOOR SWING, REFER TO FLOOR PLANS.
6. THE DOORS / WINDOWS WHICH DO NOT TOUCH THE BEAM SHALL HAVE A LINTEL BEAM (LB) ABOVE THE DOOR / WINDOW.
7. FOR ALL THE WINDOWS PUT A SILL BEAM BELOW THE WINDOW
8. FOR SAFETY PURPOSES REFER TO TECHNICAL SPECIFICATIONS FOR GLASS THICKNESS.

LEGEND:

- CG - CLEAR GLASS
- RG - REFLECTED GLASS
- AL - ALUMINIUM
- PVC - POLYVINYL CHLORIDE

DOOR & WINDOW SCHEDULE - 1

SCALE 1:50








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Project Number: RI/2020/006	Date
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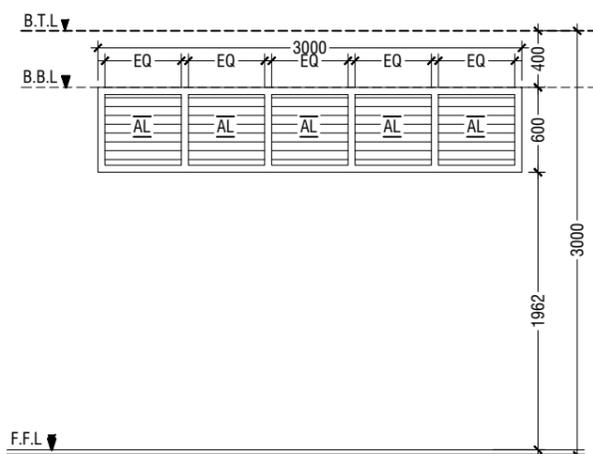


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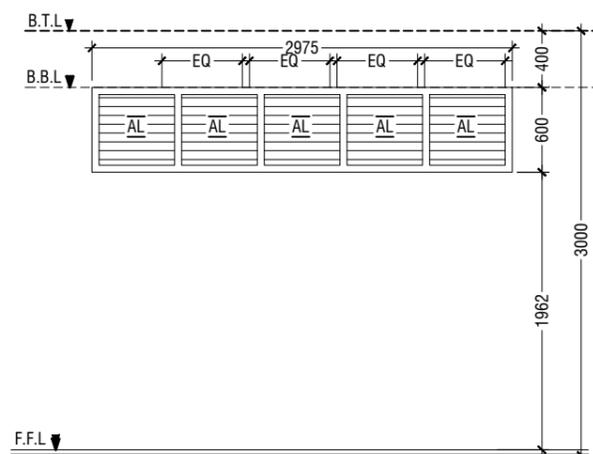
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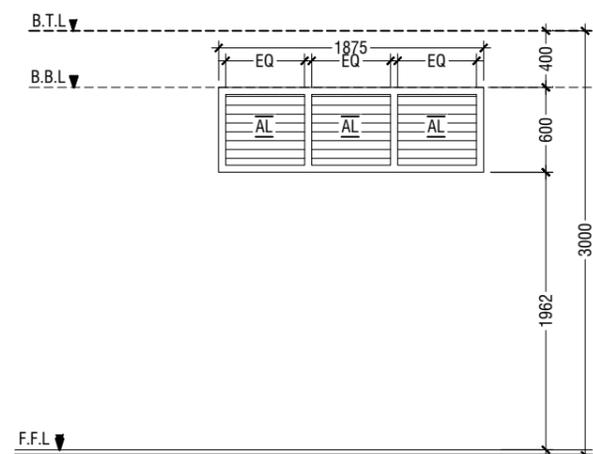
W4	SWING WINDOW
REMARKS	50mm THICK WHITE POWDER COATED (60 MICRONS) ALUMINUM FRAMED WINDOW WITH 6mm THICK REFLECTIVE GLASS
LOCATION	HALF LANDING STORE ROOM
QUANTITY	01 NOS
OPEN AREA	1.43 sqm





V1	SUNSHADING
REMARKS	50mm THICK WHITE POWDER COATED (60 MICRONS) ALUMINUM FRAMED WITH ALUMINUM LOUVERS
LOCATION	CORRIDOR
QUANTITY	10 NOS
OPEN AREA	1.35 SQM

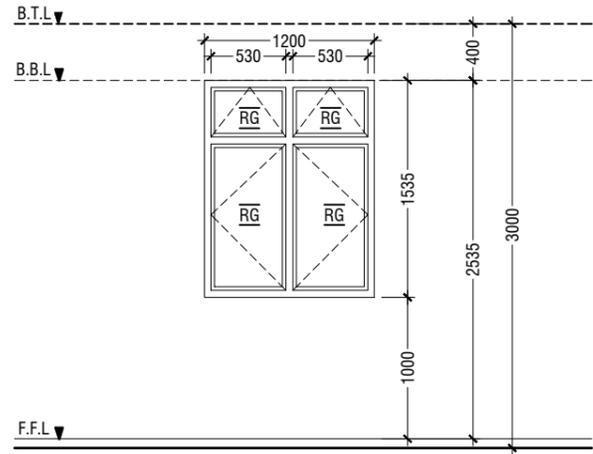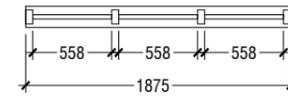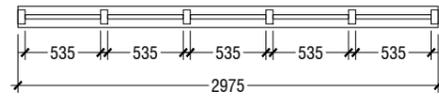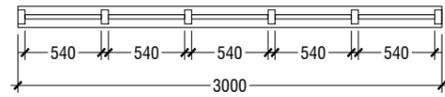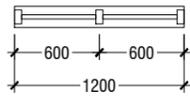

V2	SUNSHADING
REMARKS	50mm THICK WHITE POWDER COATED (60 MICRONS) ALUMINUM FRAMED WITH ALUMINUM LOUVERS
LOCATION	CORRIDOR
QUANTITY	02 NOS
OPEN AREA	1.35 SQM



V3	SUNSHADING
REMARKS	50mm THICK WHITE POWDER COATED (60 MICRONS) ALUMINUM FRAMED WITH ALUMINUM LOUVERS
LOCATION	CORRIDOR
QUANTITY	02 NOS
OPEN AREA	0.84 SQM

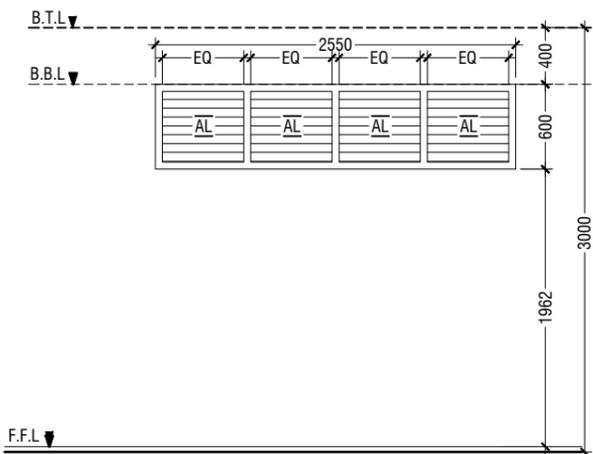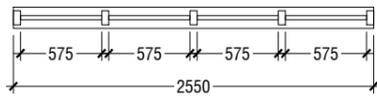


V4	SUNSHADING
REMARKS	50mm THICK WHITE POWDER COATED (60 MICRONS) ALUMINUM FRAMED WITH ALUMINUM LOUVERS
LOCATION	CORRIDOR
QUANTITY	02 NOS
OPEN AREA	1.15 SQM

LEGEND:
 CG - CLEAR GLASS
 RG - REFLECTED GLASS
 AL - ALUMINIUM
 PVC - POLYVINYL CHLORIDE

NOTE:-
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DOOR & WINDOW SCHEDULE - 2

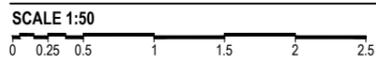

SCHEDULE OF VENTILATION FOR TH.OMADHOO SCHOOL

Room name/ Number	Room Areas (sqm) (Specify centre to centre or clear)	Window (opening) number	Required opening areas (sqm)	Designed opening areas (sqm)	Open %
Ground Floor					
1 Science Lab	52.81	2W1, 2W2 & 2D1	5.28	11.66	22.08%
2 Chemical store room	12.50		Mechanical Ventilation		
3 Health room	40.15	W1, 2W2 & D1	4.02	8.80	21.92%
4 Toilet (F)	12.73		W3 & RC FINS		
5 Toilet (M)	9.09		W3 & RC FINS		
6 Toilet for disabled	5.12		Mechanical Ventilation		
7 Main switchboard /store	11.25		Mechanical Ventilation		
First Floor					
1 Classroom 1	52.81	2W1, 2W2 & 2D1	5.28	11.66	22.08%
2 Classroom 2	52.81	2W1, 2W2 & 2D1	5.28	11.66	22.08%
3 Toilet (F)	16.24		W3 & RC FINS		
4 Toilet (M)	16.24		W3 & RC FINS		
5 Store at half landing level	7.22	W4	0.72	1.43	19.81%

VENTILATION SCHEDULE

NTS

Th.Omadhoo School Health Room, Science Lab & 2 Classroom Block (2 story)
 Client: Ministry of Education


Project Number: RI/2020/006
 Date: April 2021
 Architect: Mariyam Irasha Shareef
 Engineer: Mohamed Muhtalib Waleed
 Drawn by: Mariyam Leevan Jaleel
 Services: Aishath Ahmed Interior



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Title: Door/Window Schedule
 2 & Ventilation Schedule
 Page: A-10/21

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**GROUND FLOOR
FLOOR FINISHES PLAN**

SCALE 1:100
0 0.5 1 2 3 4 5

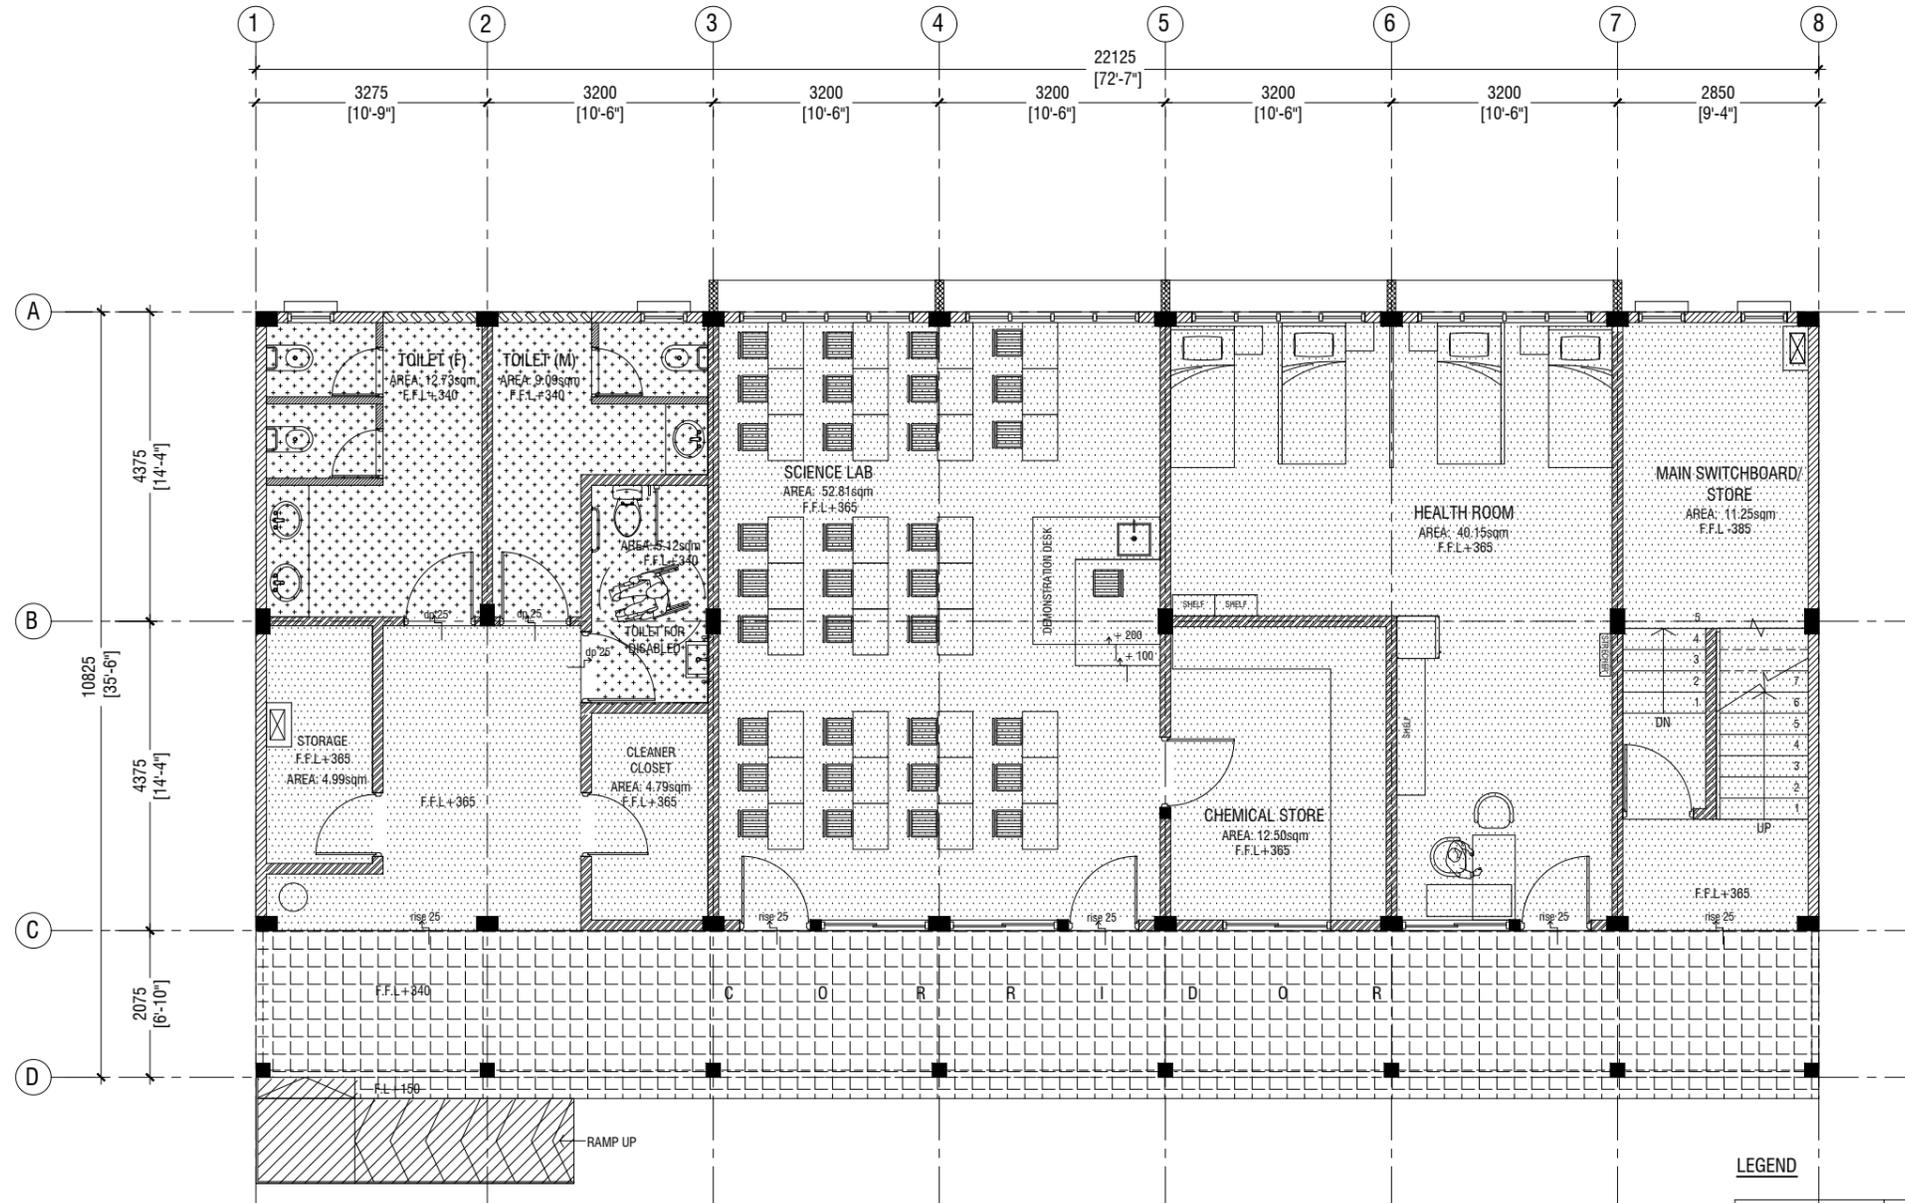LEGEND

CODE	DESCRIPTION
	600X600mm HOMOGENOUS NON-SLIP TILES OVER 50mm SCREEDING
	2.5mm SELF LEVELING CEMENT WITH EPOXY FLOOR PAINT (2 COATS OF EPOXY)
	300X300mm HOMOGENOUS NON-SLIP TILES OVER 25mm SCREEDING
	600X600mm HOMOGENOUS NON-SLIP TILES OVER 25mm SCREEDING (CEMENTITIOUS WATERPROOFING: MASTERPEL 588 OR EQUIVALENT ON TOP OF THE SLAB)

Th.Omadhoo School Health Room, Science Lab & 2 Classroom Block (2 story)
Client: Ministry of Education

Project Number: RI/2020/006
Date: April 2021
Architect: Mariyam Irasha Shareef
Engineer: Mohamed Muththailib Waleed
Drawn by: Mariyam Leevan Jaleel
Services: Aishath Ahmed
Interior: -




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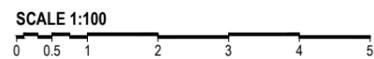
Title: Ground Floor
Floor Finish Plan

Page: A-11/21

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**FIRST FLOOR
FLOOR FINISHES PLAN**

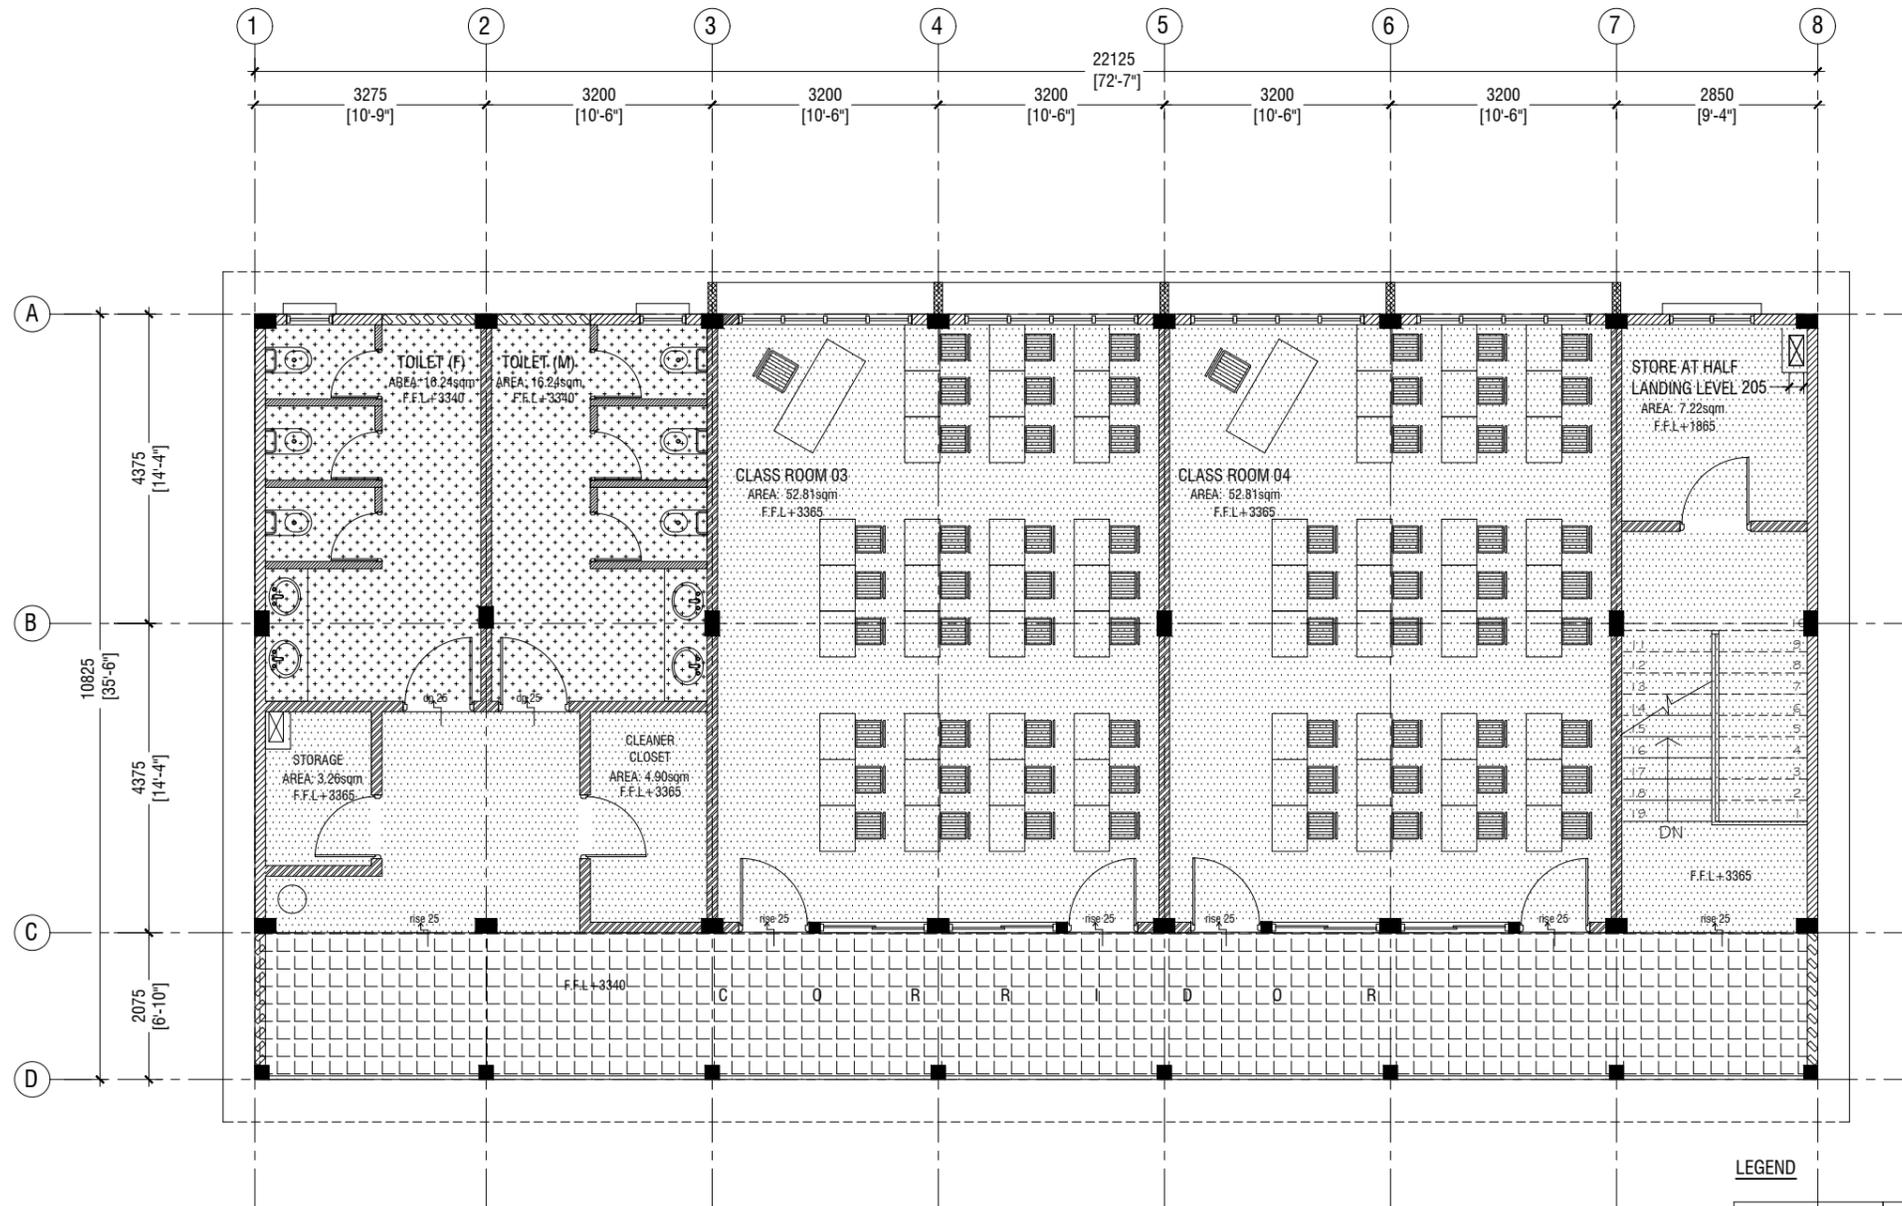

LEGEND

CODE	DESCRIPTION
	600X600mm HOMOGENOUS NON-SLIP TILES OVER 50mm SCREEDING
	300X300mm HOMOGENOUS NON-SLIP TILES OVER 25mm SCREEDING
	600X600mm HOMOGENOUS NON-SLIP TILES OVER 25mm SCREEDING (CEMENTITIOUS WATERPROOFING: MASTERPEL 588 OR EQUIVALENT ON TOP OF THE SLAB)

Th.Omadhoo School Health Room, Science Lab & 2 Classroom Block (2 story)
Client: Ministry of Education

Project Number: RI/2020/006
Date: April 2021
Architect: Mariyam Irasha Shareef
Engineer: Mohamed Muththalib Waleed
Drawn by: Mariyam Leevan Jaleel
Services: Aishath Ahmed
Interior: -

Rev no	Date
-	-
-	-
-	-




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Title: First Floor
Floor Finish Plan

Page: A-12/21



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**GROUND FLOOR
REFLECTED CEILING PLAN**

SCALE 1:100
0 0.5 1 2 3 4 5

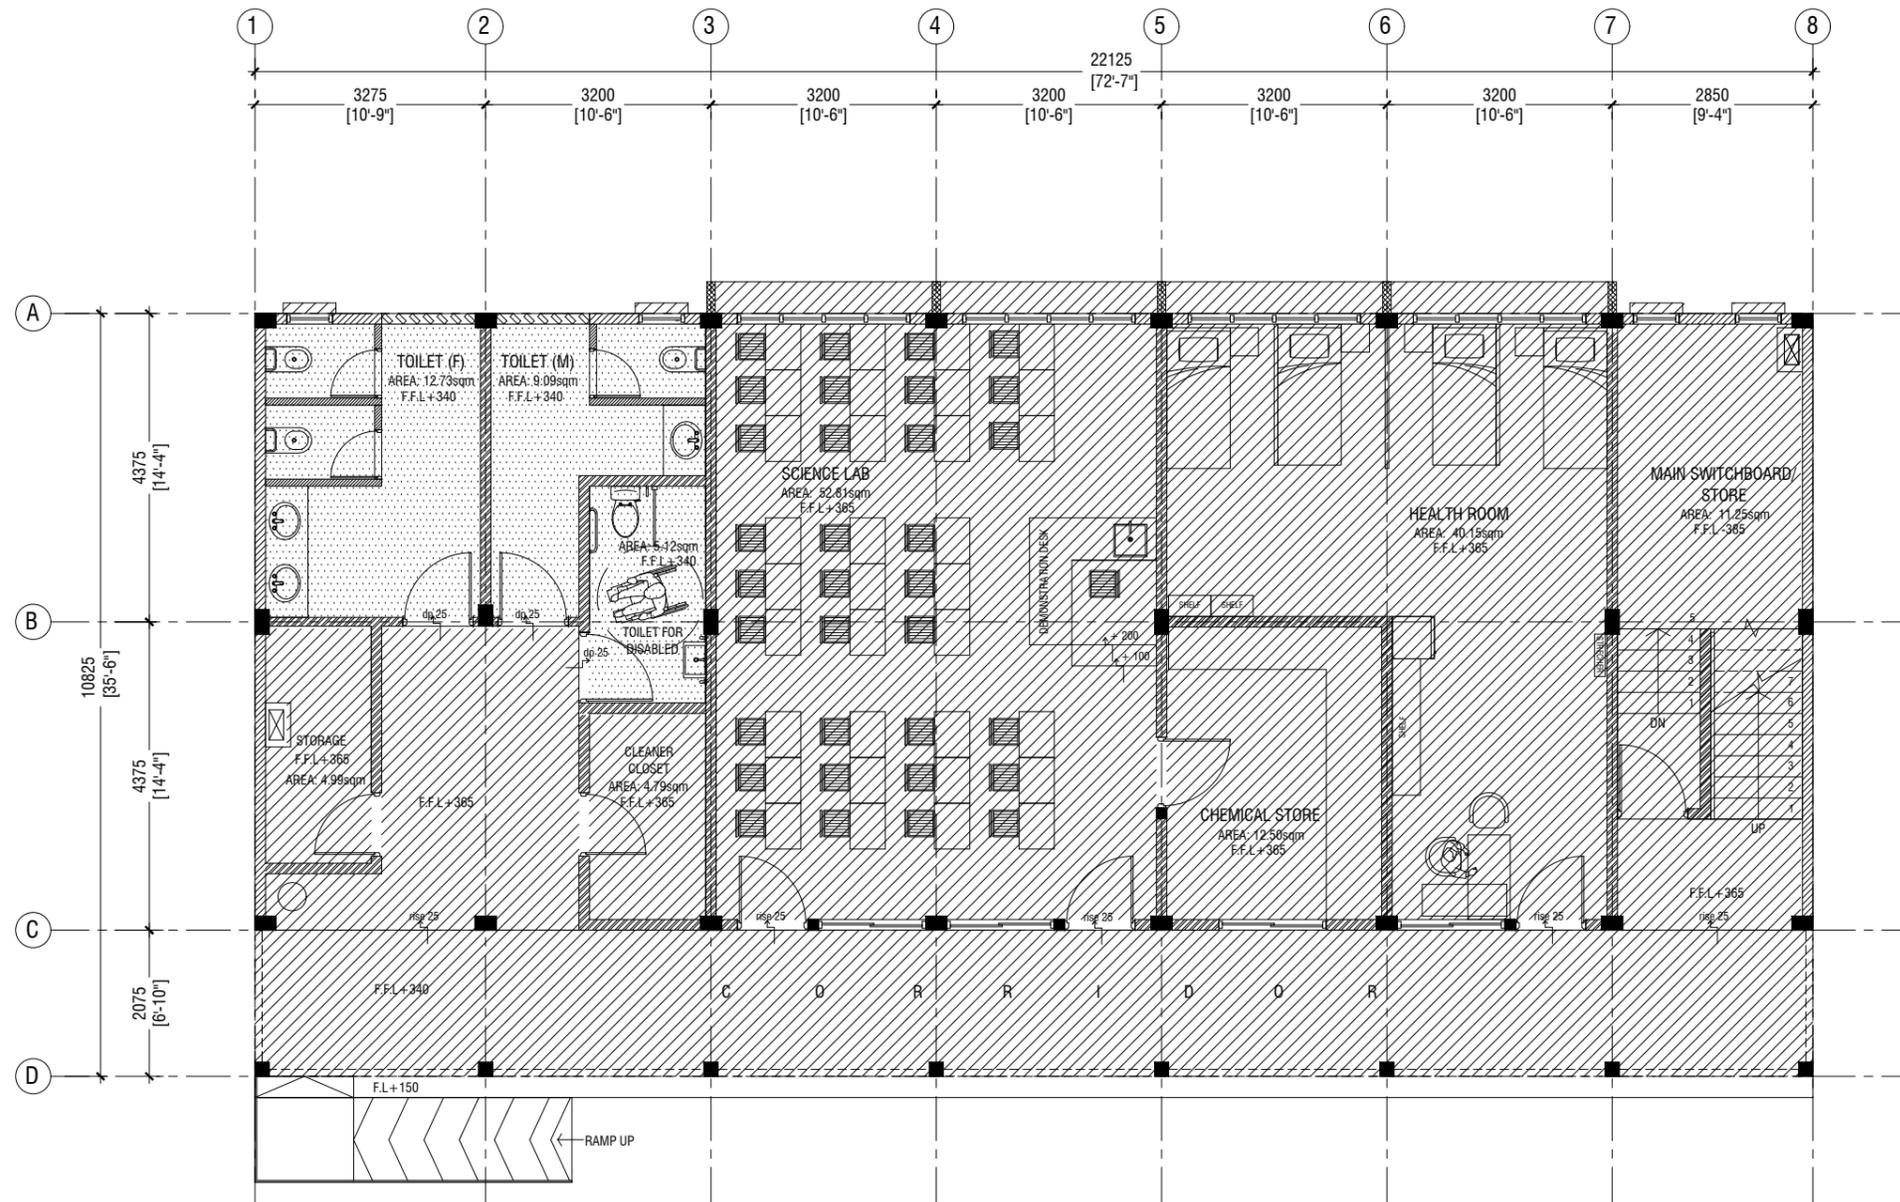LEGEND

CODE	DESCRIPTION
	EXPOSED SLAB SOFFIT TO BE GROUND SMOOTH IN SELECT PAINT FINISH (ONE COAT OF PUTTY FOLLOWED BY SEALER AND 2 COATS OF PAINT)
	6mm THICK CEMENT BOARD ON ROOF EAVE/GABLE CEILING (ONE COAT OF PUTTY FOLLOWED BY SEALER AND 2 COATS OF PAINT)

Th.Omadhoo School Health Room, Science Lab & 2 Classroom Block (2 story)
Client: Ministry of Education

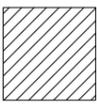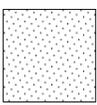Project Number: RI/2020/006
Date: April 2021
Architect: Mariyam Irasha Shareef
Engineer: Mohamed Muhtalib Waleed
Drawn by: Mariyam Leevan Jaleel
Services: Aishath Ahmed
Interior: -

Rev no	Date
1	
2	
3	
4	
5	
6	
7	
8	




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Title: Ground Floor Reflected Ceiling Plan

Page: A-13/21

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**FIRST FLOOR
REFLECTED CEILING PLAN**

SCALE 1:100
0 0.5 1 2 3 4 5

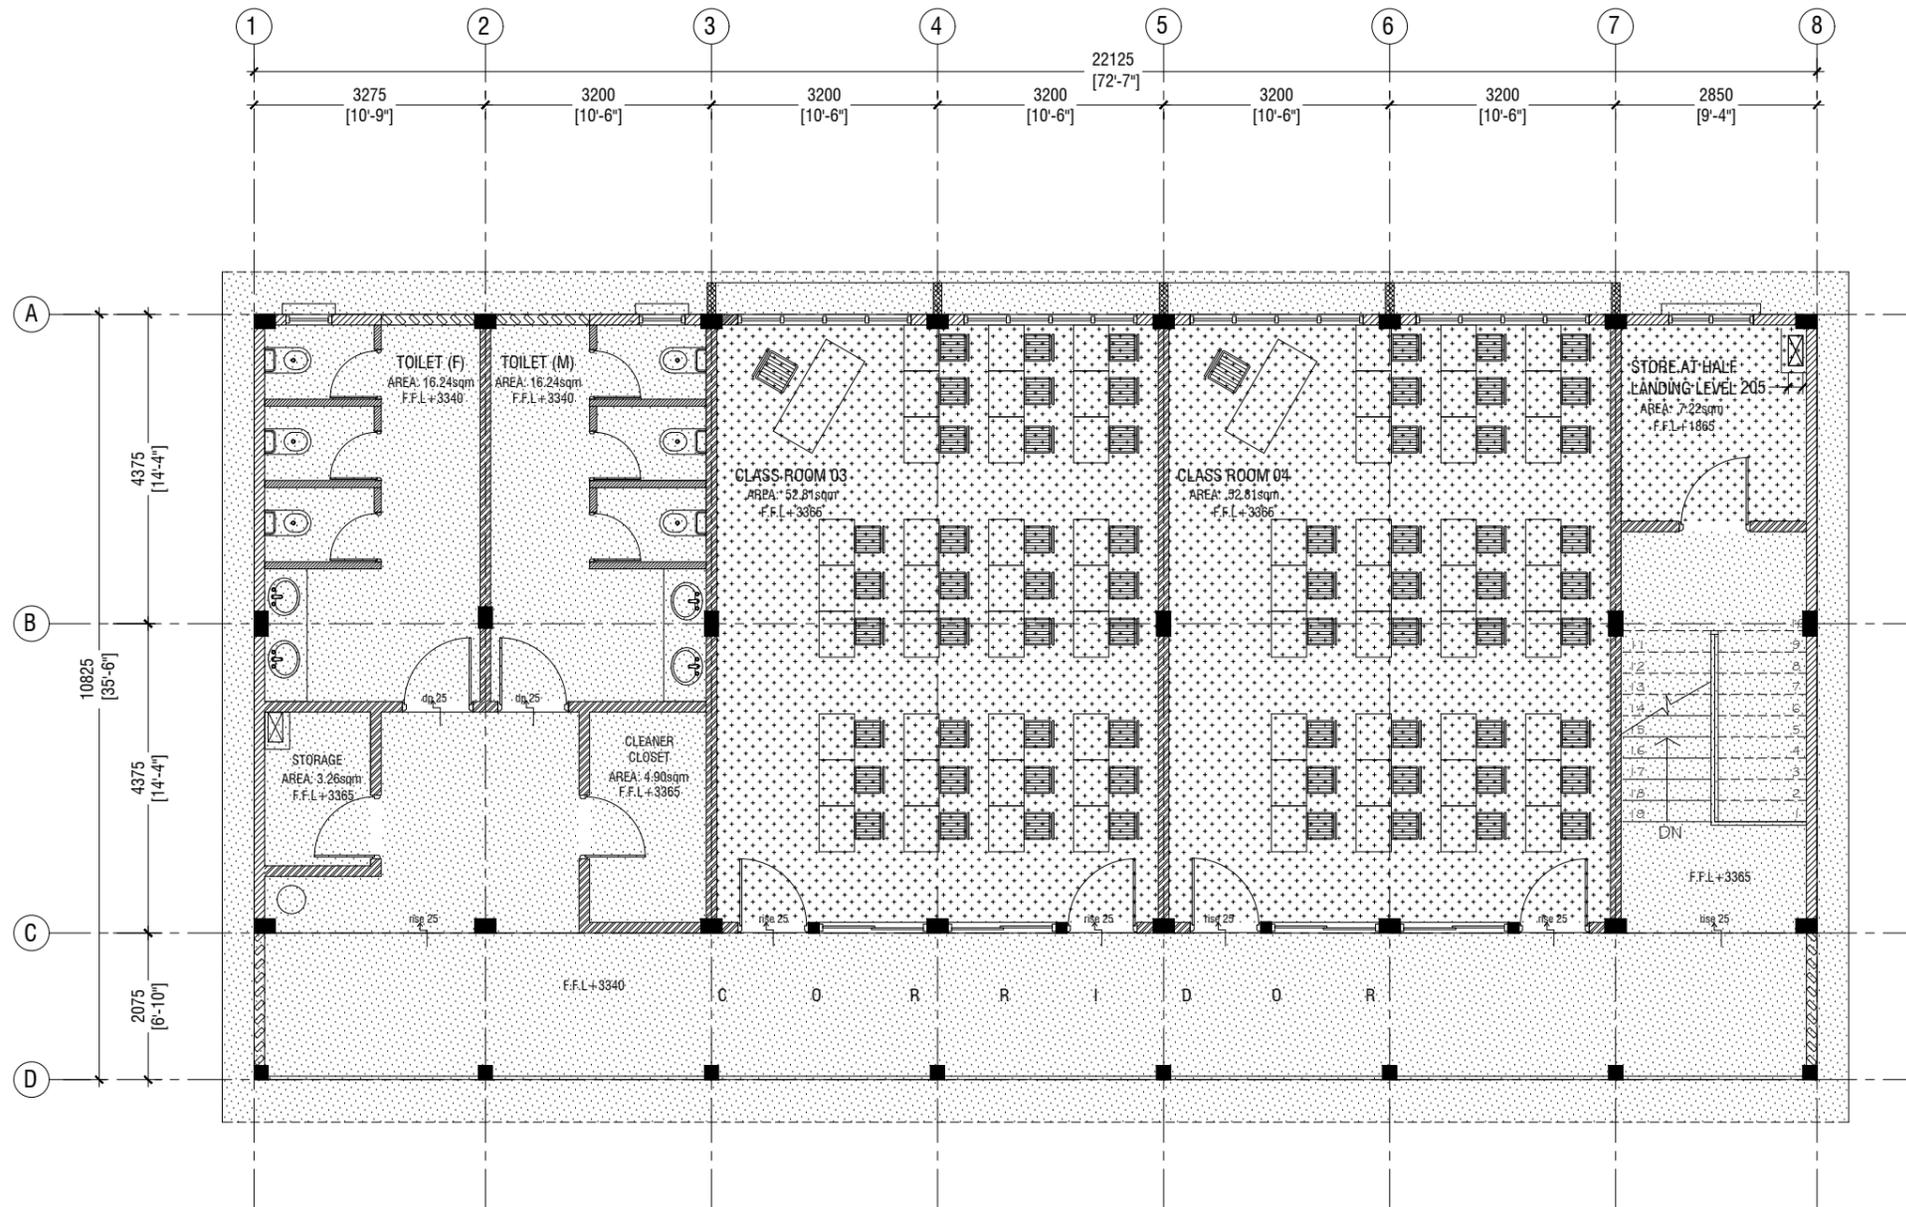LEGEND

CODE	DESCRIPTION
	9mm THICK FIXED CEILING 'BORAL' OR EQUIVALENT PLASTERBOARD CEILING SYSTEM WITH TIMBER FRAMES, APPLIED WITH GROUND SMOOTH FINISH IN SELECTED PAINT
	6mm THICK CEMENT BOARD ON ROOF EAVE/GABLE CEILING (ONE COAT OF PUTTY FOLLOWED BY SEALER AND 2 COATS OF PAINT)

Th.Omadhoo School Health Room, Science Lab & 2 Classroom Block (2 story)
Client: Ministry of Education

Project Number: RI/2020/006
Date: April 2021
Architect: Mariyam Irasha Shareef
Engineer: Mohamed Muhtalib Waleed
Drawn by: Mariyam Leevan Jaleel
Services: Alshath Ahmed Interior

Rev no	Date
..	..
..	..
..	..




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Title: First Floor Reflected Ceiling Plan

Page: A-14/21

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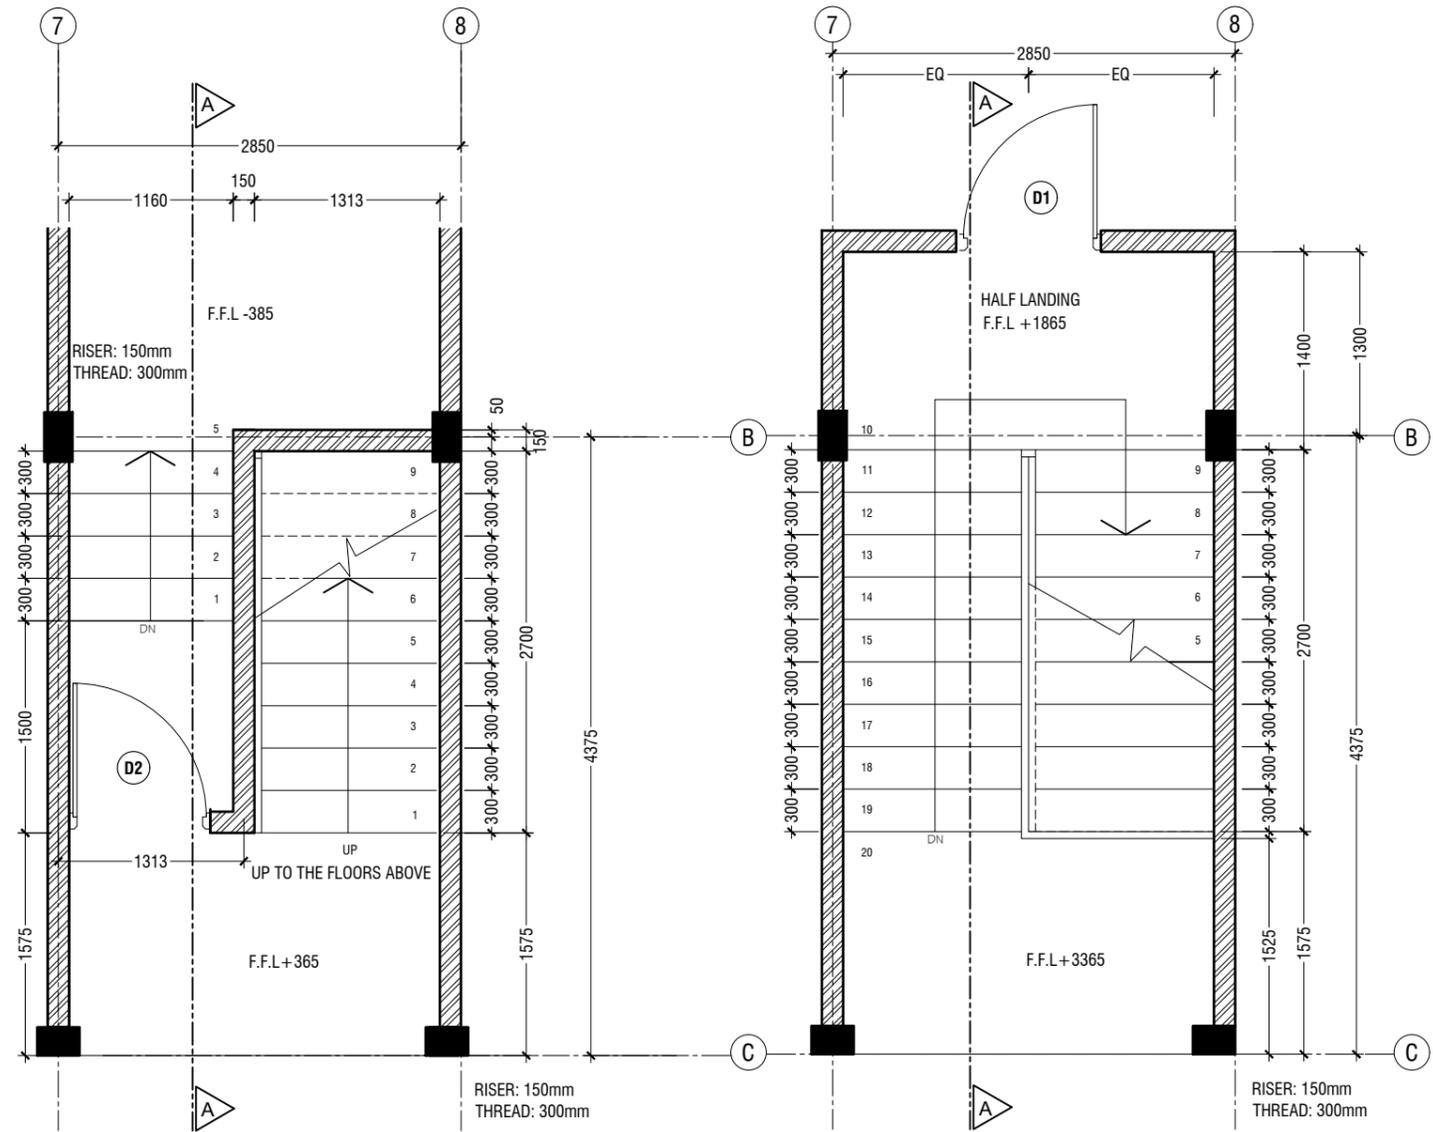


SECTION A-A

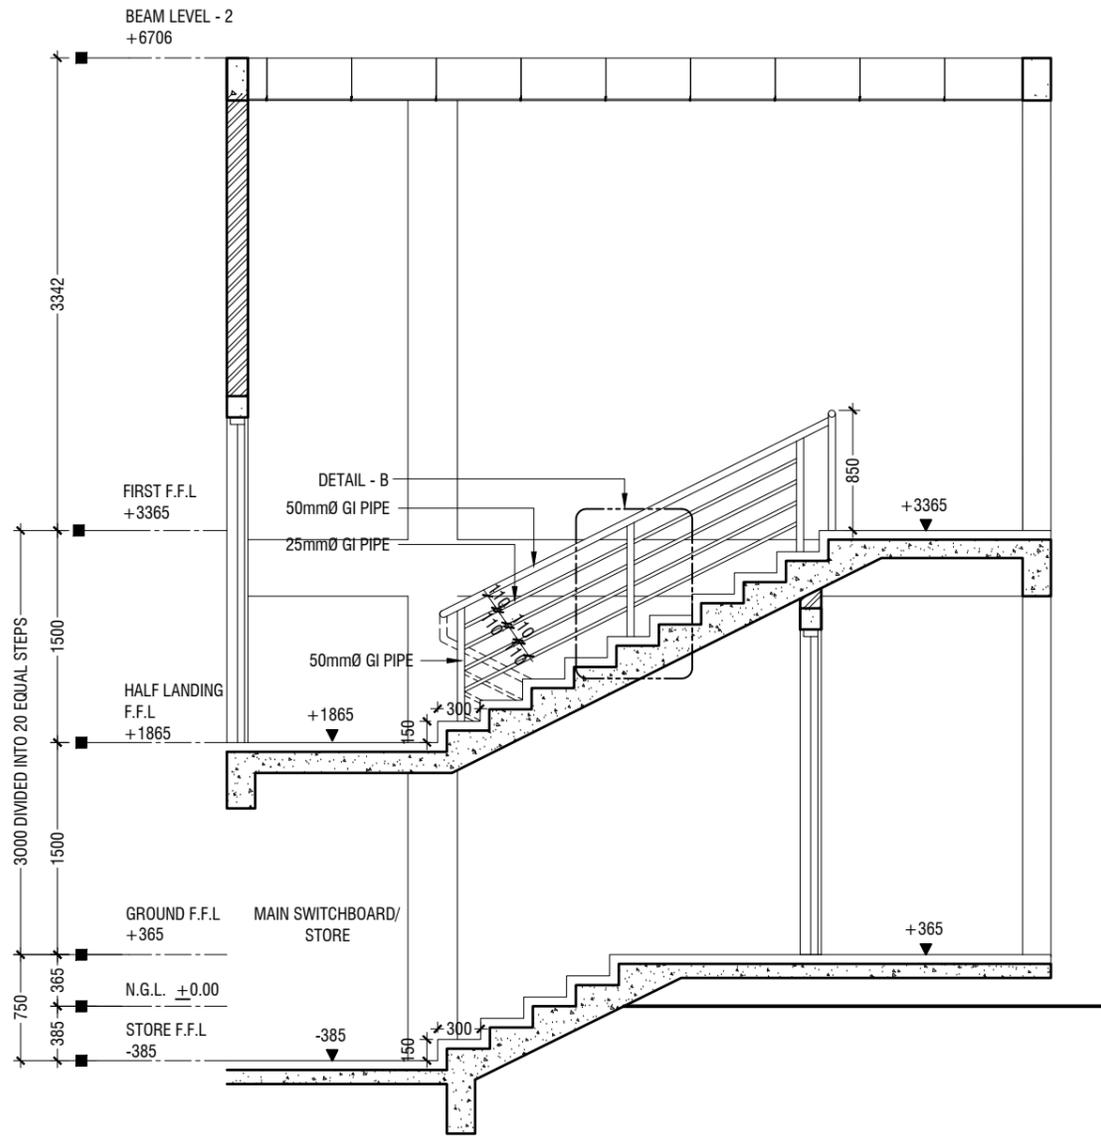SCALE 1:50

**DETAIL - 1
STAIRCASE DETAILS**

SCALE 1:20




GROUND FLOOR STAIRCASE PLAN

SCALE 1:50

TYPICAL STAIRCASE PLAN

SCALE 1:50

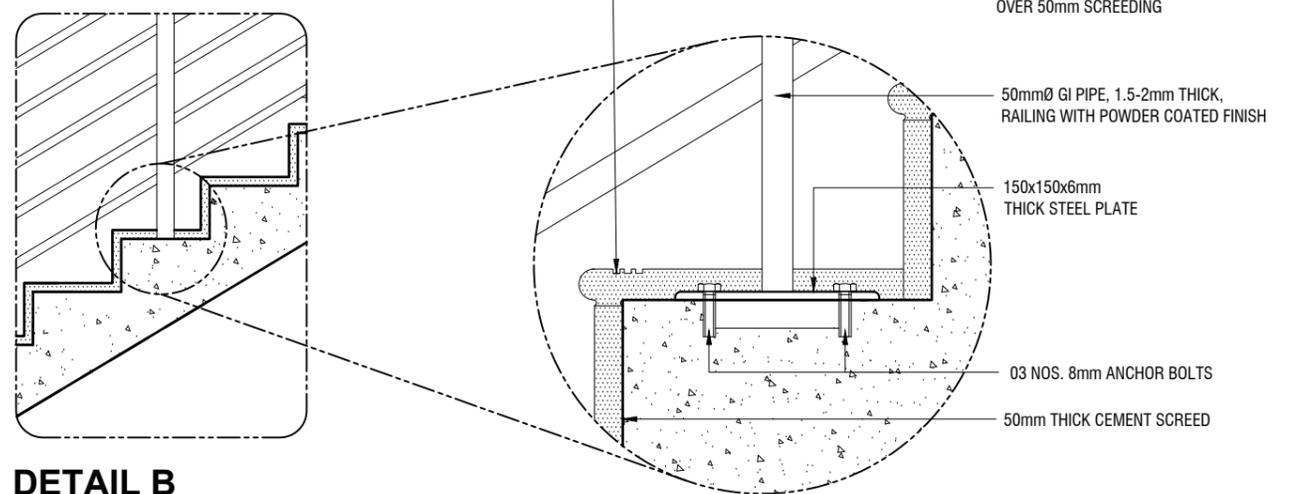

DETAIL B

SCALE 1:20

Th.Omadhoo School Health Room, Science Lab & 2 Classroom Block (2 story)
Client: Ministry of Education

Rev no	Date
1
2
3
4

Project Number: RI/2020/006
Date: April 2021
Architect: Maryam Irasha Shareef
Engineer: Mohamed Muhtalib Waleed
Drawn by: Maryam, Leevan, Jaleel
Services: Aishath Ahmed Interior





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Title: Staircase Details


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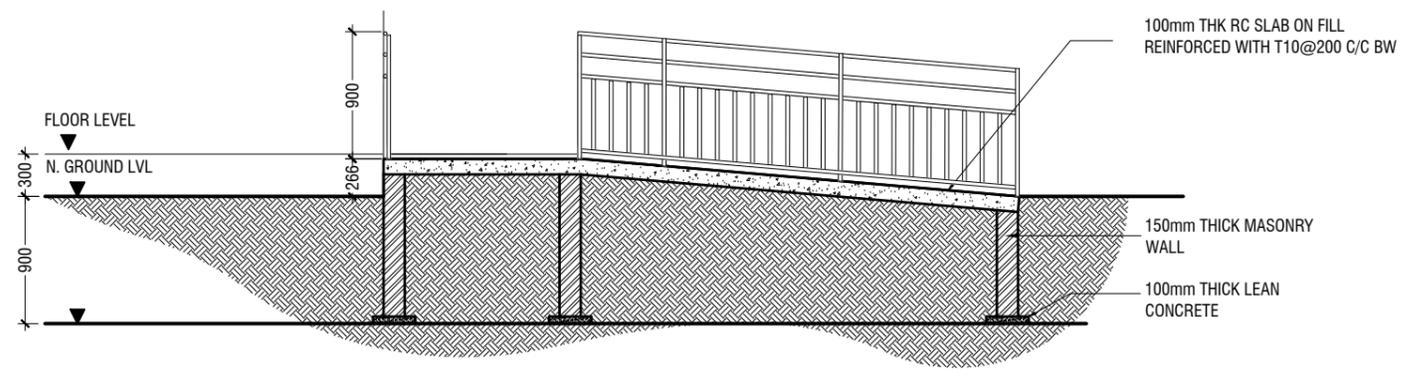


ELEVATION C

Ø50mm SS (304) 1.5-2mm THICK, HOLLOW PIPE
 4 NOS. 12mm ANCHOR BOLTS FIXED TO THE RC FLOOR WITH SS PLATE AND COVERED BY PLASTERING
 100mm THICK RC CONCRETE SLAB

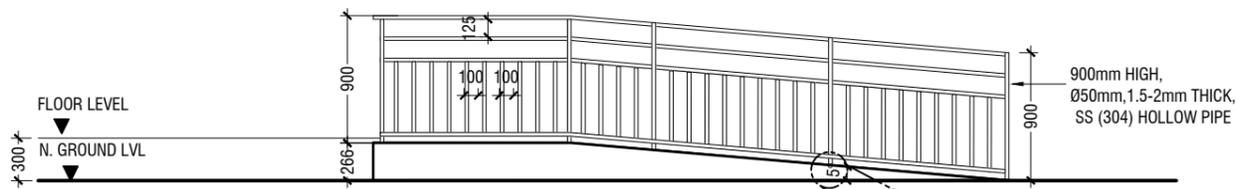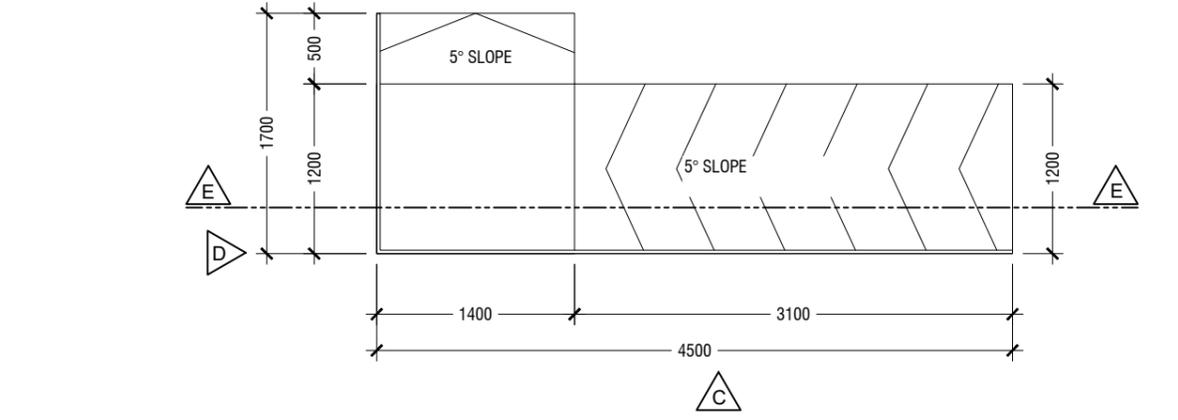

ELEVATION D

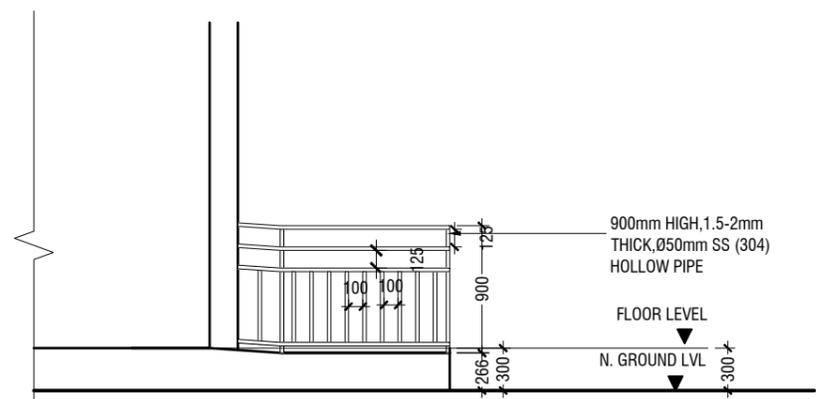

SECTION E-E

**DETAIL - 2
 MAIN ENTRANCE RAMP DETAILS**

SCALE 1:50
 0 0.25 0.5 1 1.5 2 2.5

Th.Omadhoo School Health Room, Science Lab & 2 Classroom Block (2 story)
 Client: Ministry of Education

Rev no	Date
01	04/04/2021
02	04/04/2021
03	04/04/2021
04	04/04/2021
05	04/04/2021

Project Number: RI/2020/006
 Date: April 2021
 Architect: Mariyam Irasha Shareef
 Engineer: Mohamed Muhtalib Waleed
 Drawn by: Mariyam Leevan Jaleel
 Services: Alshath Ahmed Interior




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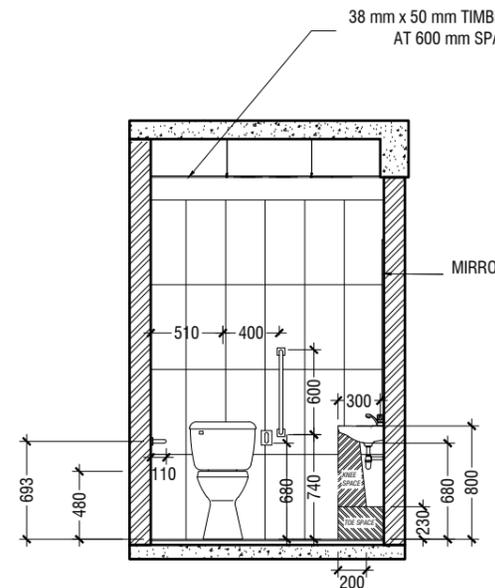
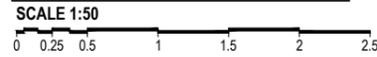
Title: Ramp Details

Page: A-16/21


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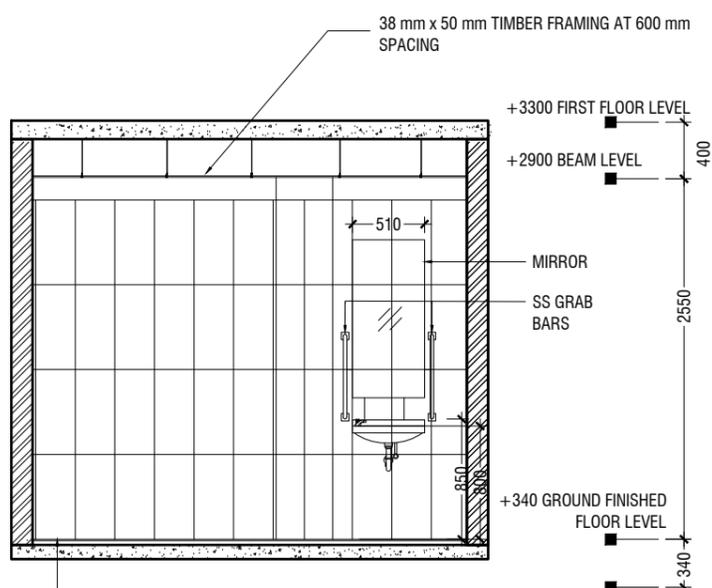
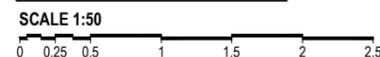
TOILET FOR PERSONS WITH DISABILITIES PLAN
SCALE 1:50

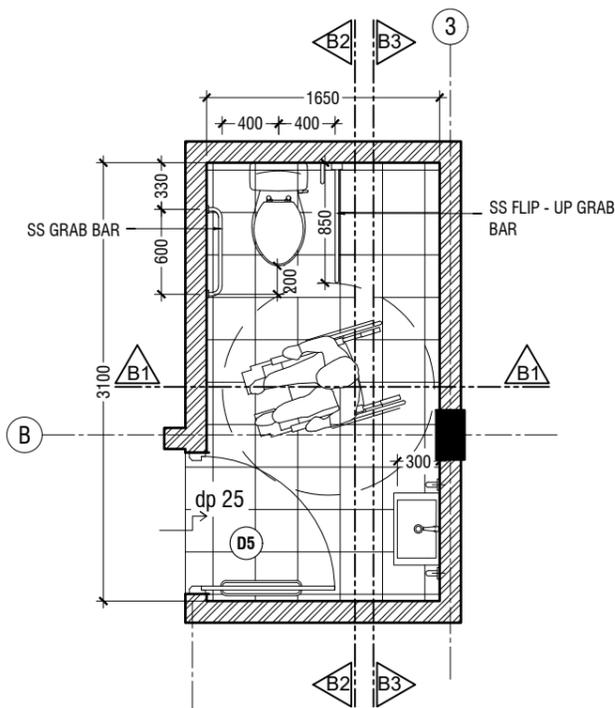



SECTION B1-B1
SCALE 1:50





SECTION B2-B2
SCALE 1:50

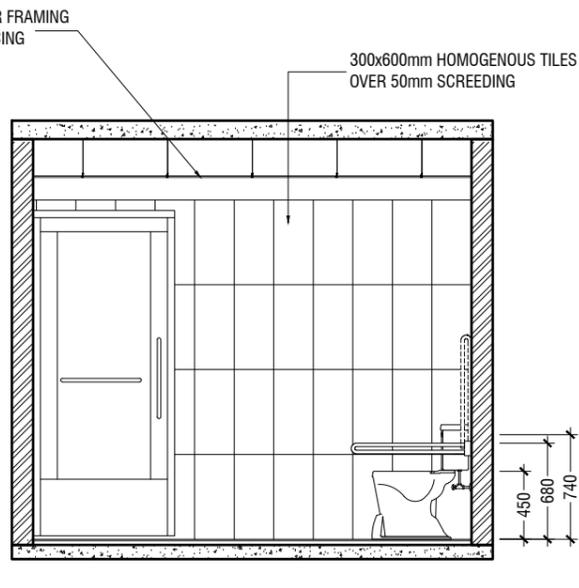



SECTION B3-B3
SCALE 1:50

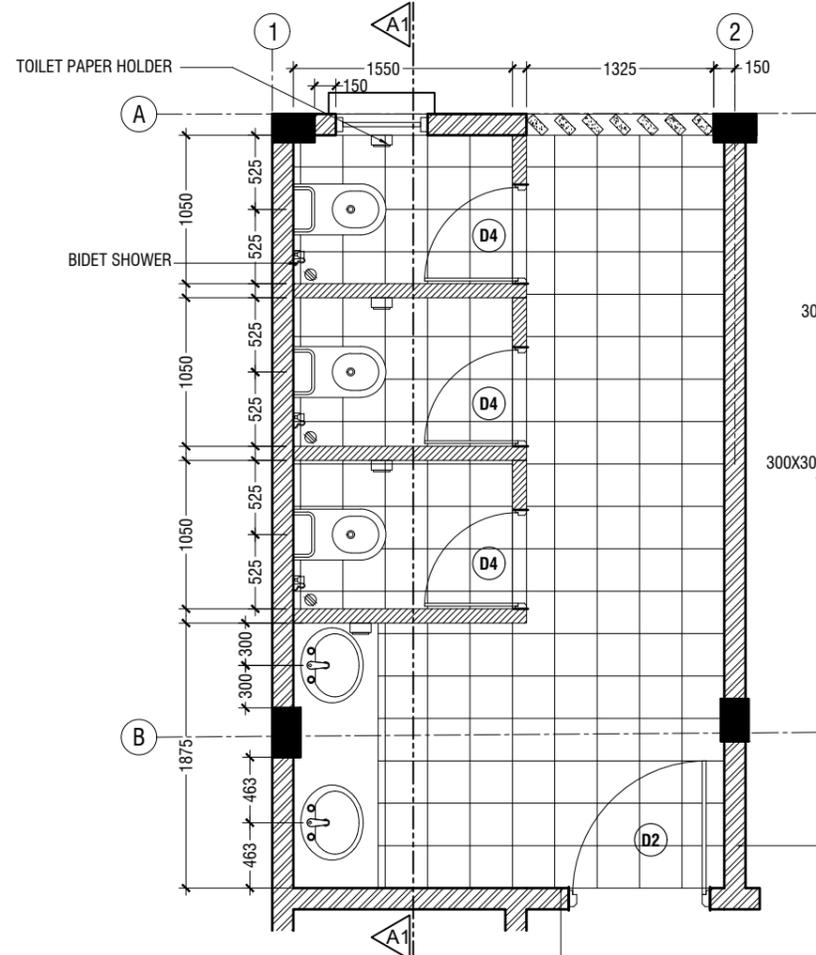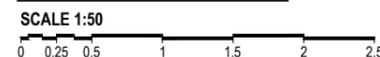


TYPICAL TOILET PLAN
SCALE 1:50

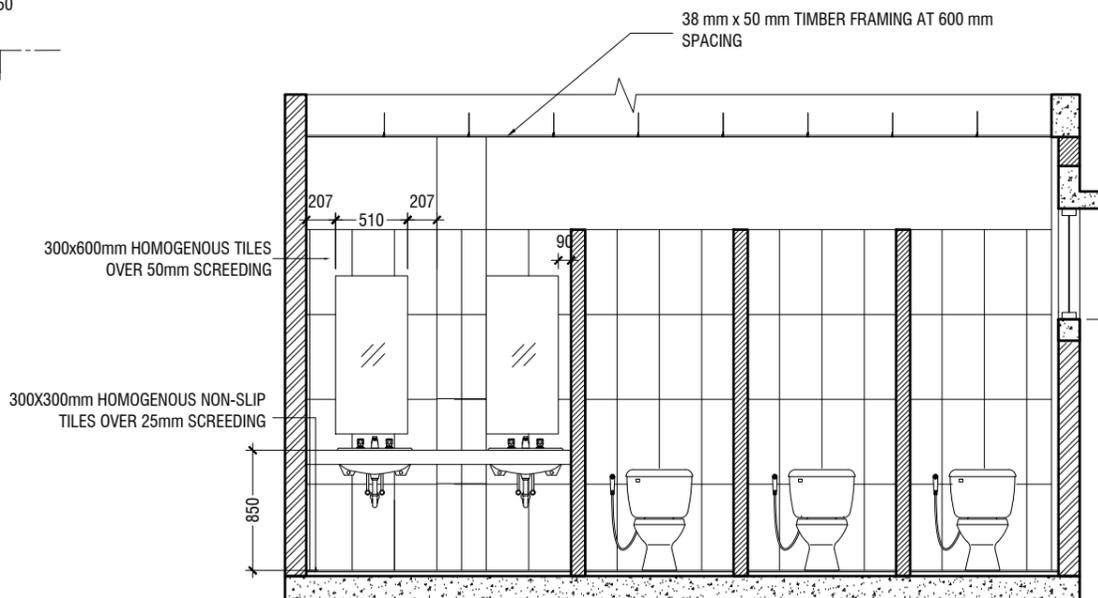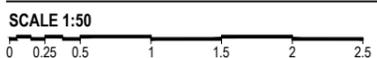

SECTION A1-A1
SCALE 1:50

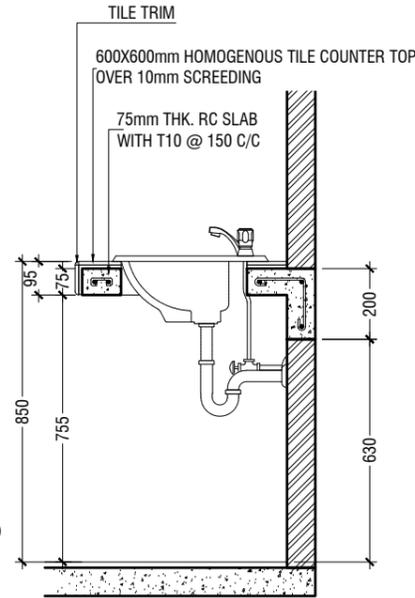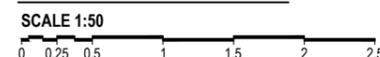

COUNTER TOP DETAILS
SCALE 1:20

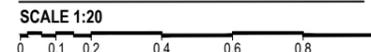

NOTE:
ALL THE MATERIALS FOR FIXTURES SHALL BE APPROVED
BY THE ARCHITECT/CONSULTANT BEFORE INSTALLATION

GRAB BARS OF THE DISABLE TOILET SHALL BE AS PER MANUFACTURE'S DETAIL

**DETAIL - 3
TOILET DETAILS**
SCALE 1:50

Th.Omadhoo School Health Room, Science Lab & 2 Classroom Block (2 story)
Client: Ministry of Education

Project Number: RI/2020/006	Date
Date: April 2021	Rev no
Architect: Maryam Irasha Shareef	Rev no
Engineer: Mohamed Muhtalib Waleed	Rev no
Drawn by: Maryam Leevan Jaleel	Rev no
Services: Alshath Ahmed Interior	Rev no



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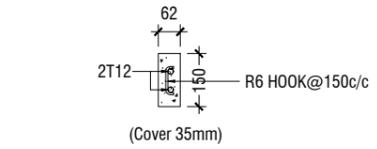
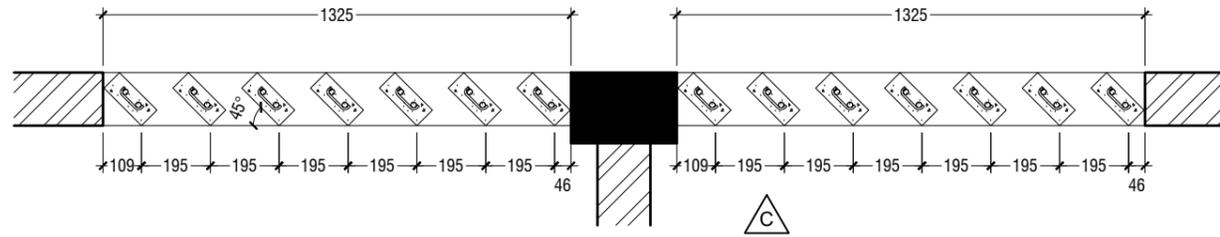
Title: Typical Toilet Details

Page: A-17/21

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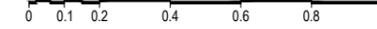
PLAN

SCALE 1:20




RC FIN DETAIL

SCALE 1:20




ROOF BEAM LEVEL -2

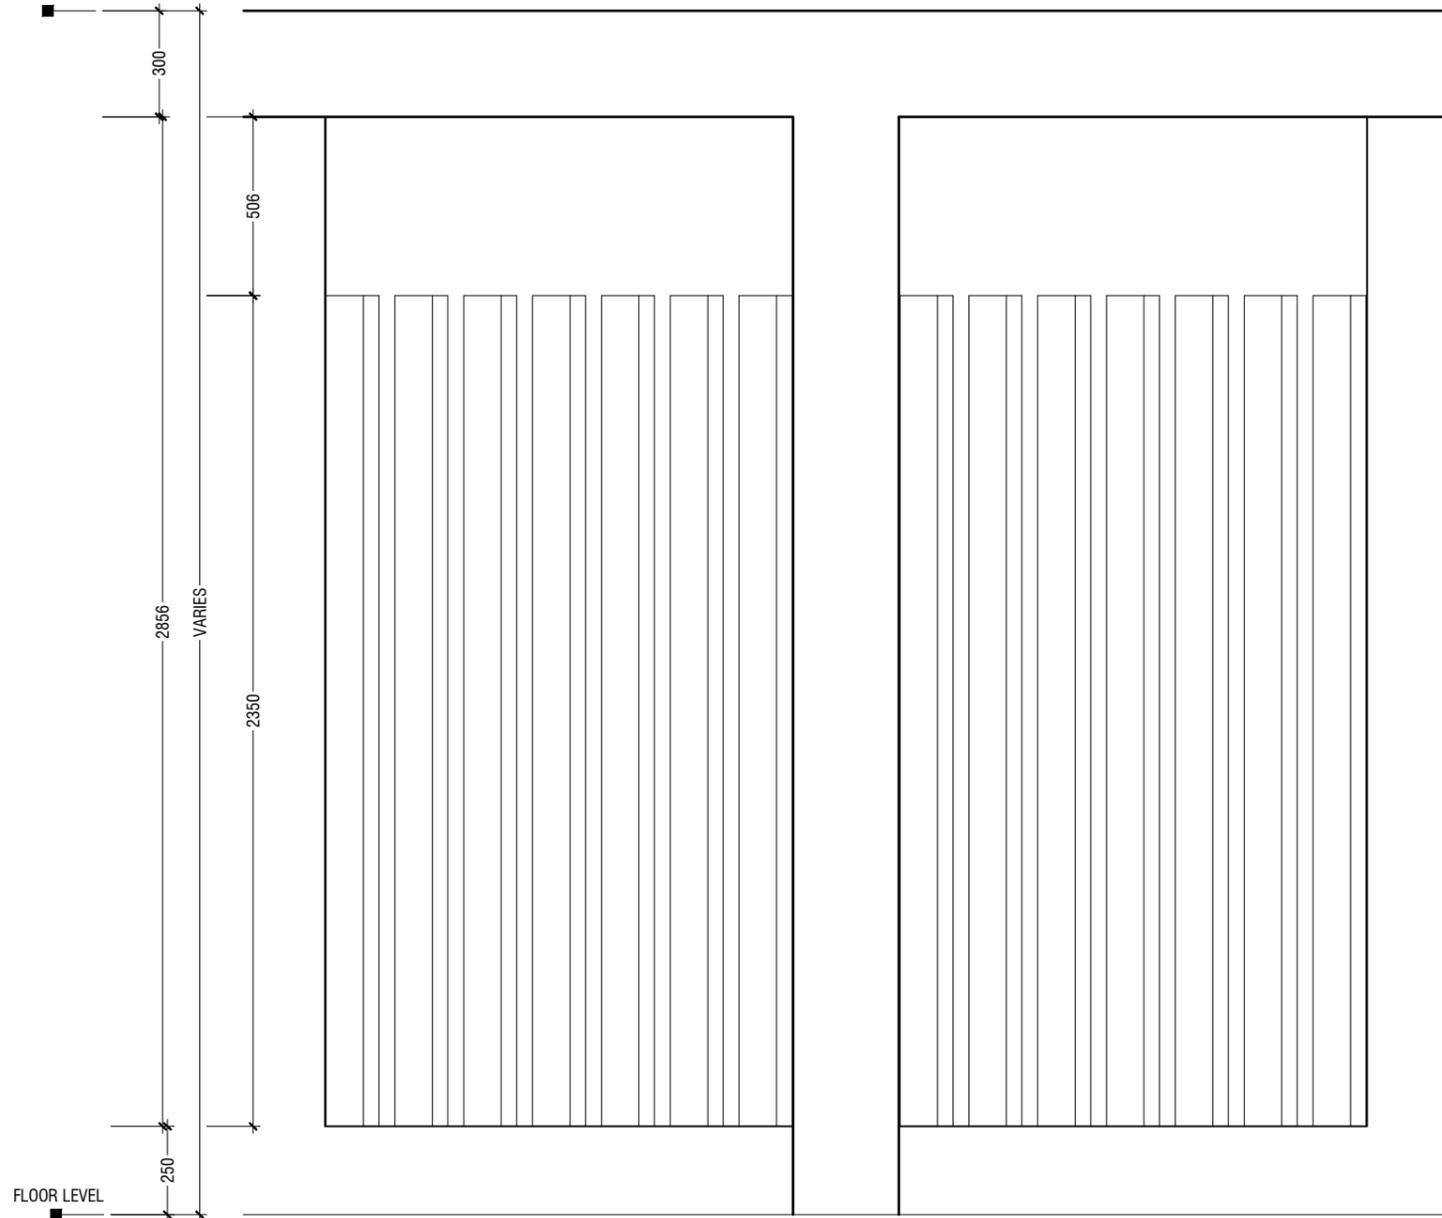


ELEVATION - C

SCALE 1:20

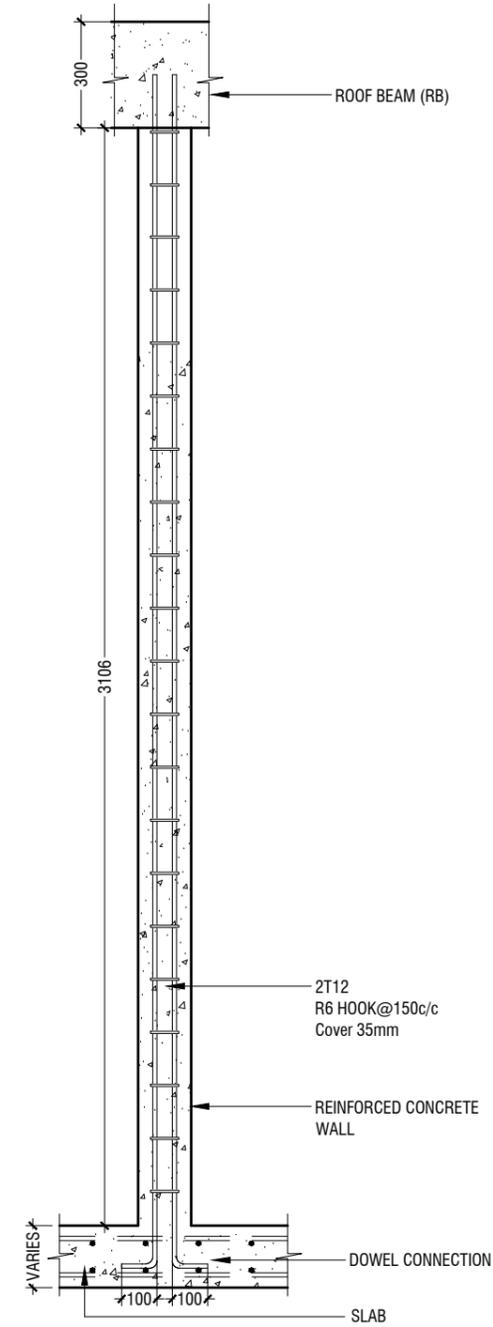

SECTION C-C

SCALE 1:20

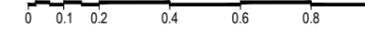

NOTE:- FLOOR TO FLOOR HEIGHT VARIES AND WILL BE SUBJECTED TO CHANGES

**DETAIL - 4
RC FIN DETAILS (TOILET)**

SCALE 1:20



Th.Omadhoo School Health Room, Science Lab & 2 Classroom Block (2 story)
Client: Ministry of Education

Project Number:	Date
RI/2020/006	April 2021
Architect:	Rev no
Mariyam Irasha Shareef	01
Engineer:	Date
Mohamed Muthalib Waleed	01
Drawn by:	Rev no
Mariyam Leevan Jaleel	01
Services:	Date
Aishath Ahmed	01
Interior:	Date
	01



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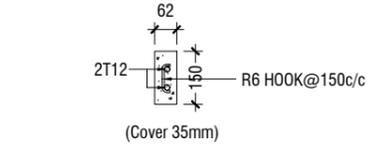
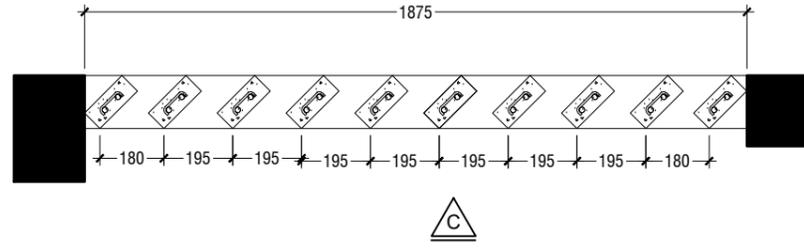
Title: RC Fins Details

Page: A-18/21

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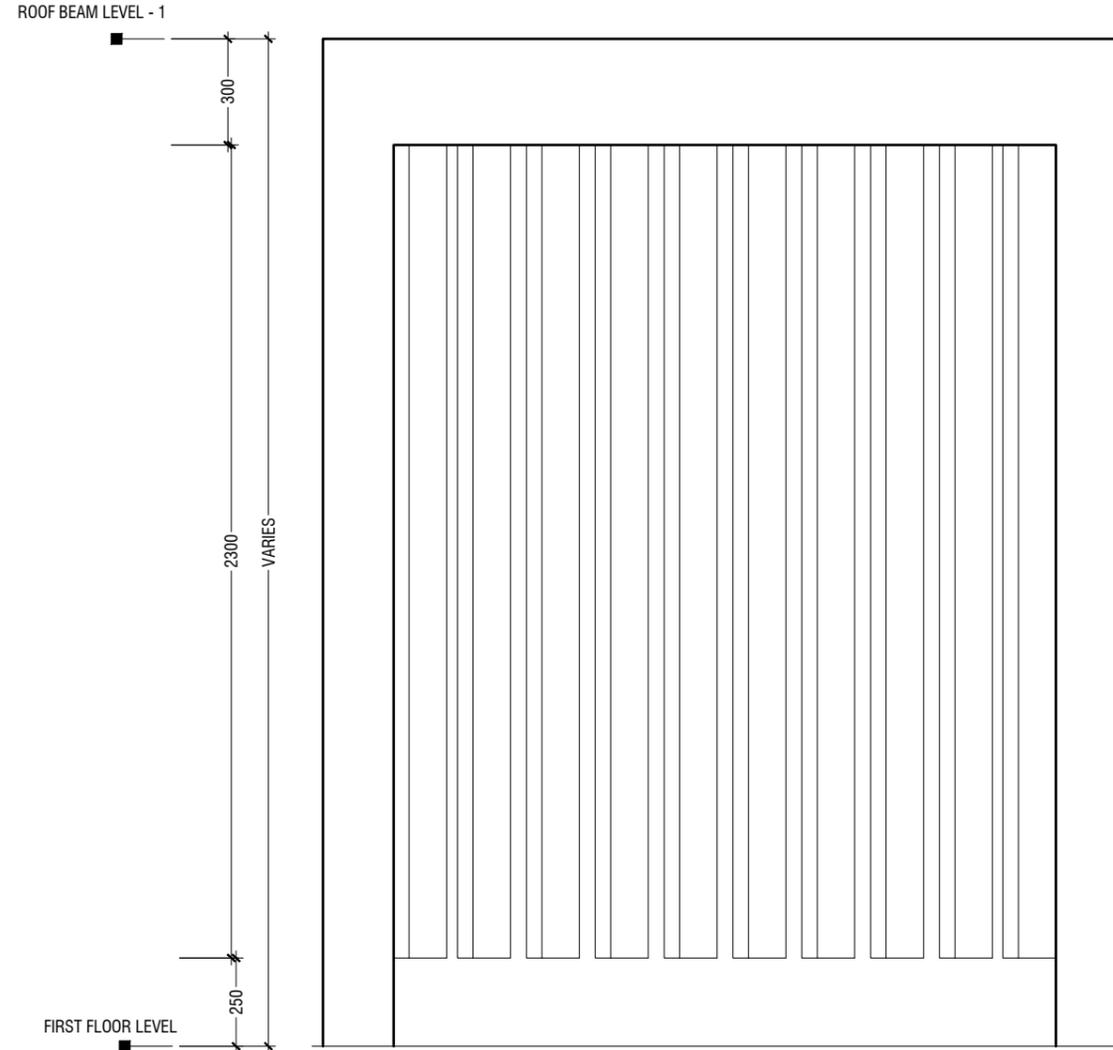
PLAN

SCALE 1:20




RC FIN DETAIL

SCALE 1:20



ELEVATION - C

SCALE 1:20

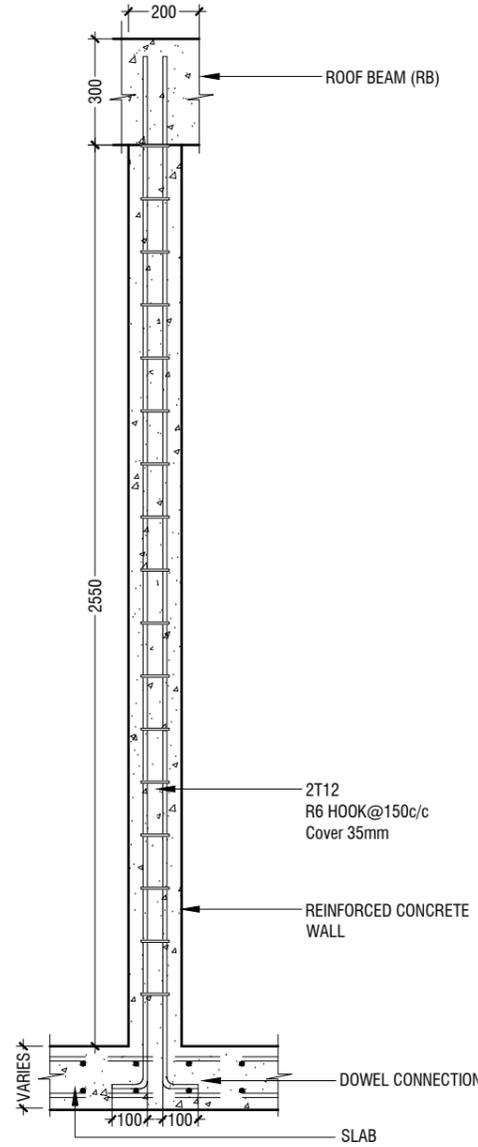

SECTION C-C

SCALE 1:20

NOTE:-
FLOOR TO FLOOR HEIGHT VARIES AND WILL BE SUBJECTED TO CHANGES

DETAIL - 5
RC FIN DETAILS (CORRIDOR)

SCALE 1:20

Th.Omadhoo School Health Room, Science Lab & 2 Classroom Block (2 story)
Client: Ministry of Education

Rev no	Date
..
..
..
..

Project Number: RI/2020/006
Date: April 2021
Architect: Mariyam Irasha Shareef
Engineer: Mohamed Muhtalib Waleed
Drawn by: Mariyam Leevan Jaleel
Services: Aishath Ahmed Interior




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Title: RC Fins Detail

Page: A-19/21

ROOF BEAM LEVEL
+6150

FIRST FLOOR LEVEL
+3300

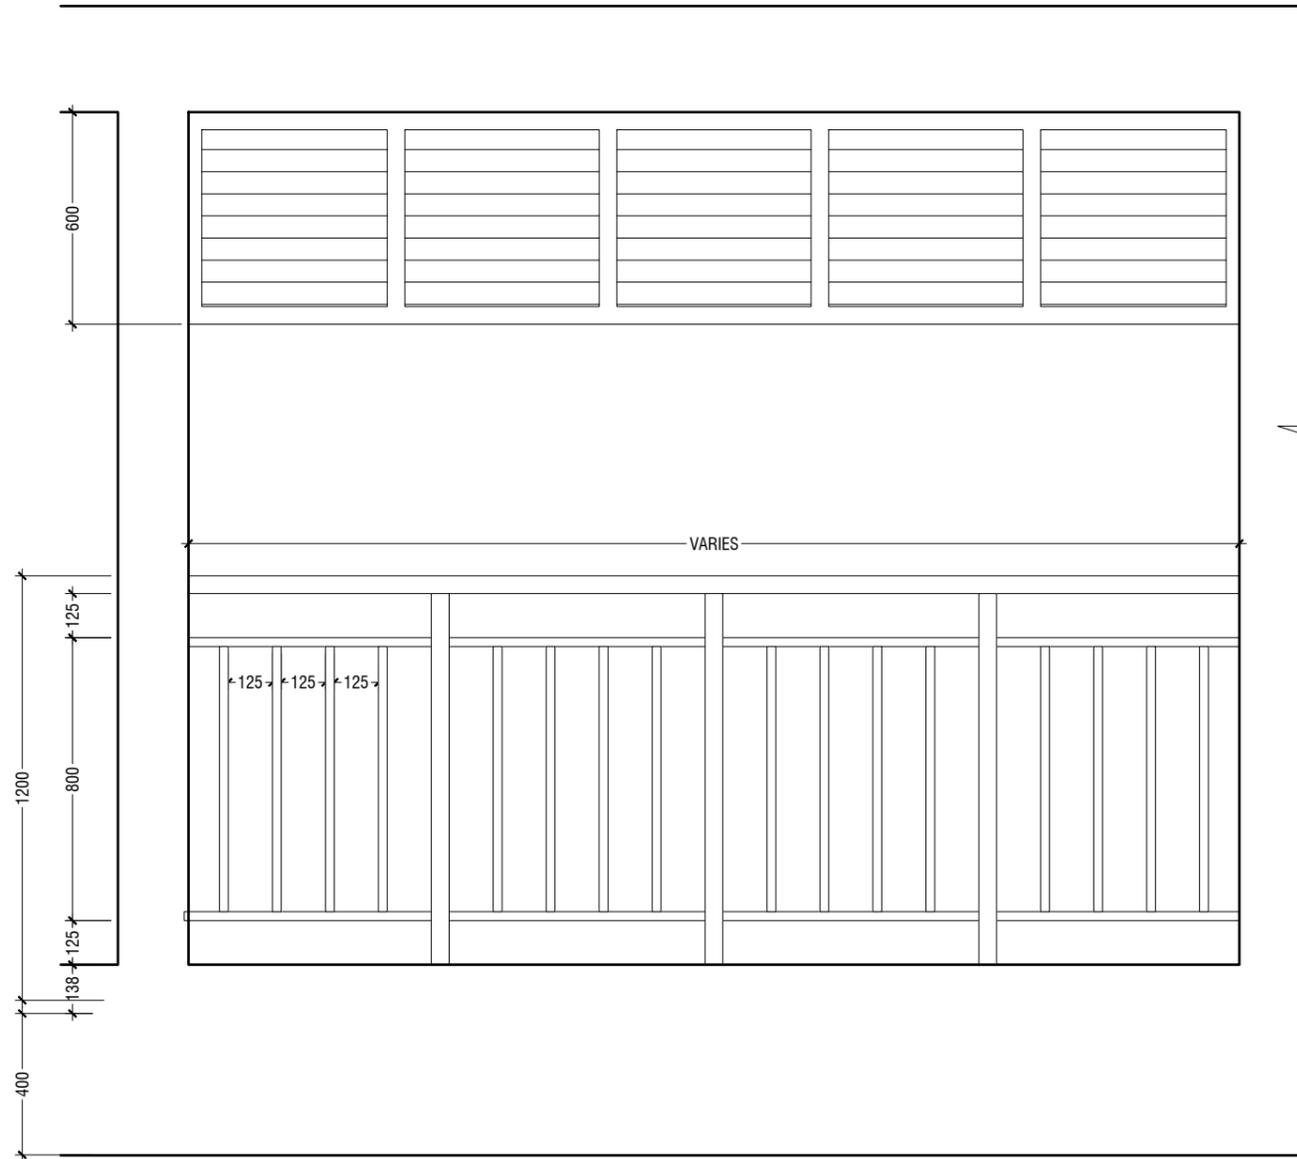



ELEVATION

SCALE 1:20

NOTE:-
FLOOR TO FLOOR HEIGHT VARIES AND WILL BE SUBJECTED TO CHANGES

DETAIL - 6 RAILING DETAILS

SCALE 1:20

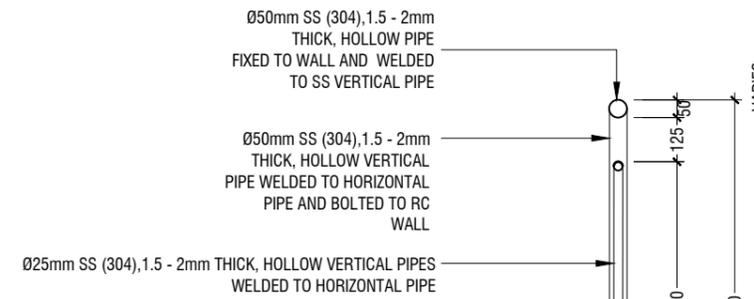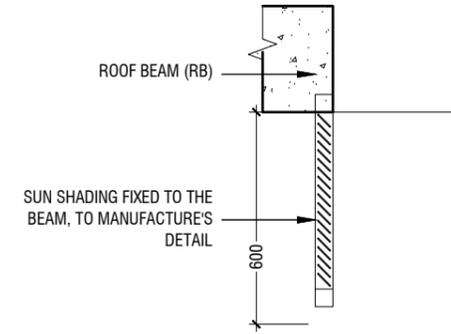

Ø50mm SS (304), 1.5 - 2mm THICK, HOLLOW PIPE FIXED TO WALL AND WELDED TO SS VERTICAL PIPE

Ø50mm SS (304), 1.5 - 2mm THICK, HOLLOW VERTICAL PIPE WELDED TO HORIZONTAL PIPE AND BOLTED TO RC WALL

Ø25mm SS (304), 1.5 - 2mm THICK, HOLLOW VERTICAL PIPES WELDED TO HORIZONTAL PIPE

RC SLAB

Ø50mm SS (304), 1.5 - 2mm THICK, HOLLOW PIPE

4 NOS. 12mm ANCHOR BOLTS FIXED TO THE RC WALL WITH SS PLATE AND COVERED BY PLASTERING

100mm THICK RC CONCRETE WALL

SECTION

SCALE 1:20

Th.Omadhoo School Health Room, Science Lab & 2 Classroom Block (2 story)
Client: Ministry of Education

Project Number: RI/2020/006	Date
Date: April 2021	
Architect: Mariyam Irasha Shareef	
Engineer: Mohamed Muhtalib Waleed	
Drawn by: Mariyam Leevan Jaleel	
Services: Aishath Ahmed Interior	

Rev no	Date
1	
2	
3	
4	




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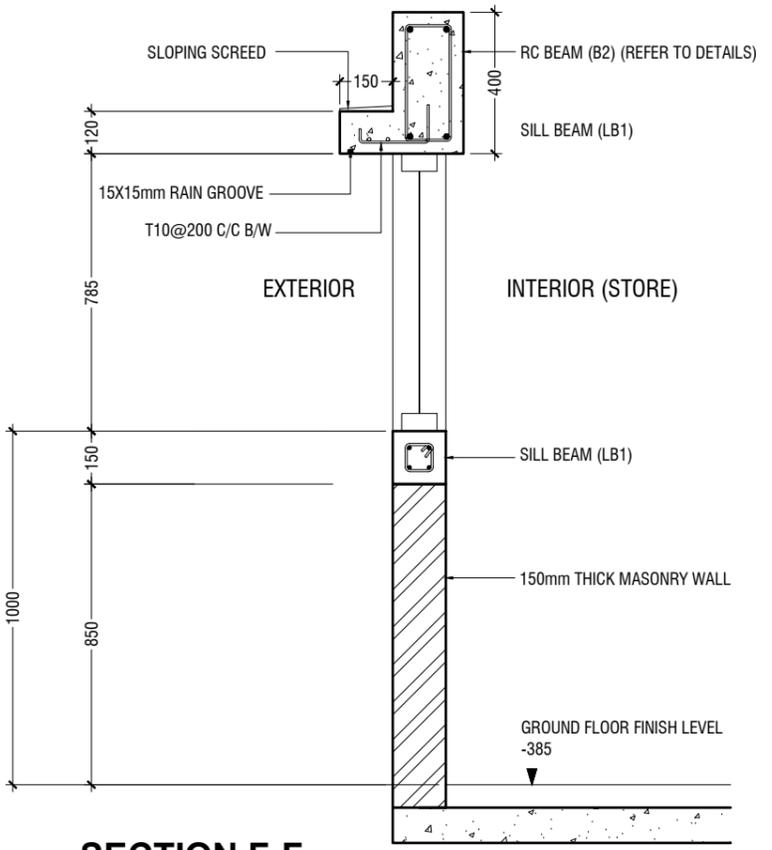
Title: Railing Detail

Page: A-20/21


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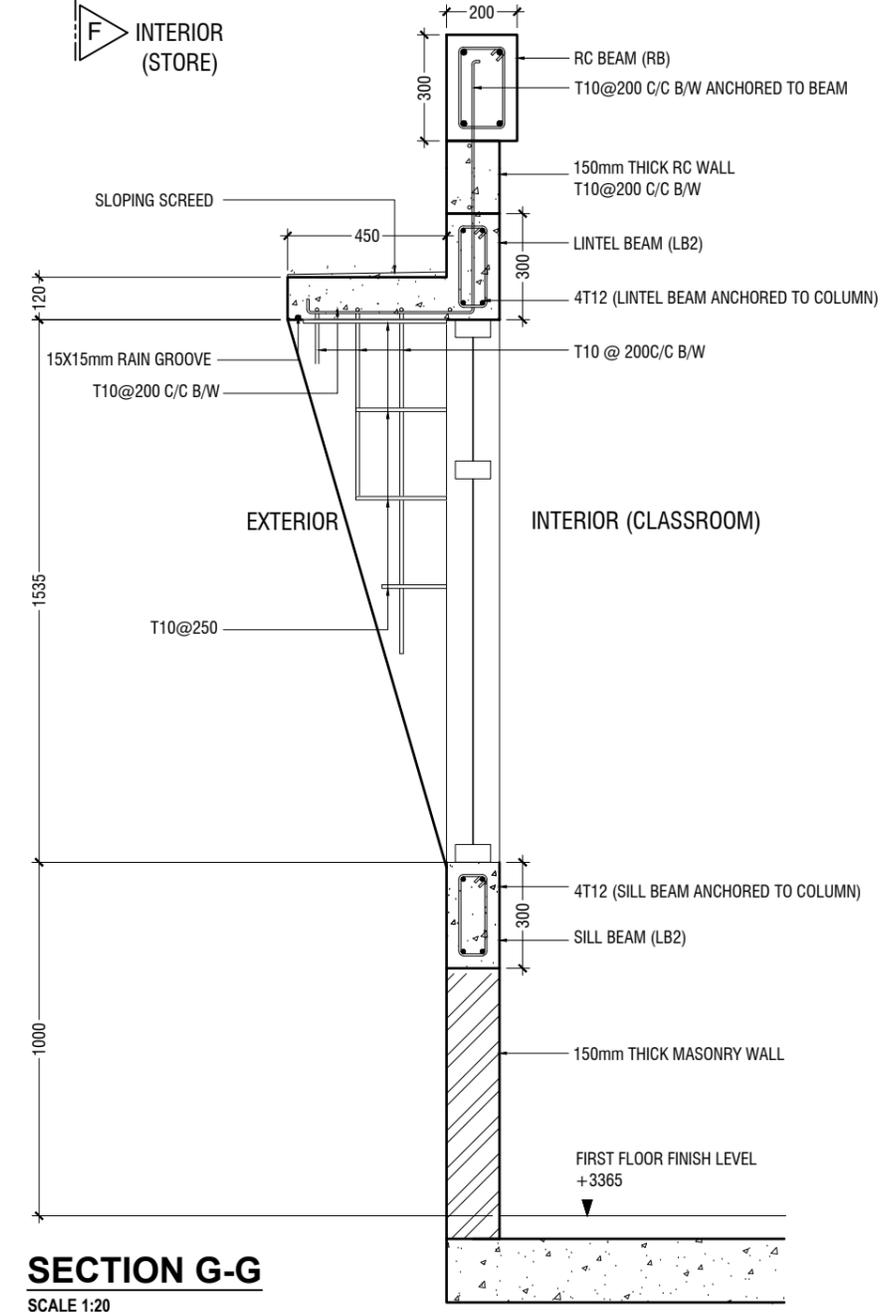
PLAN
SCALE 1:20



SECTION F-F
SCALE 1:20

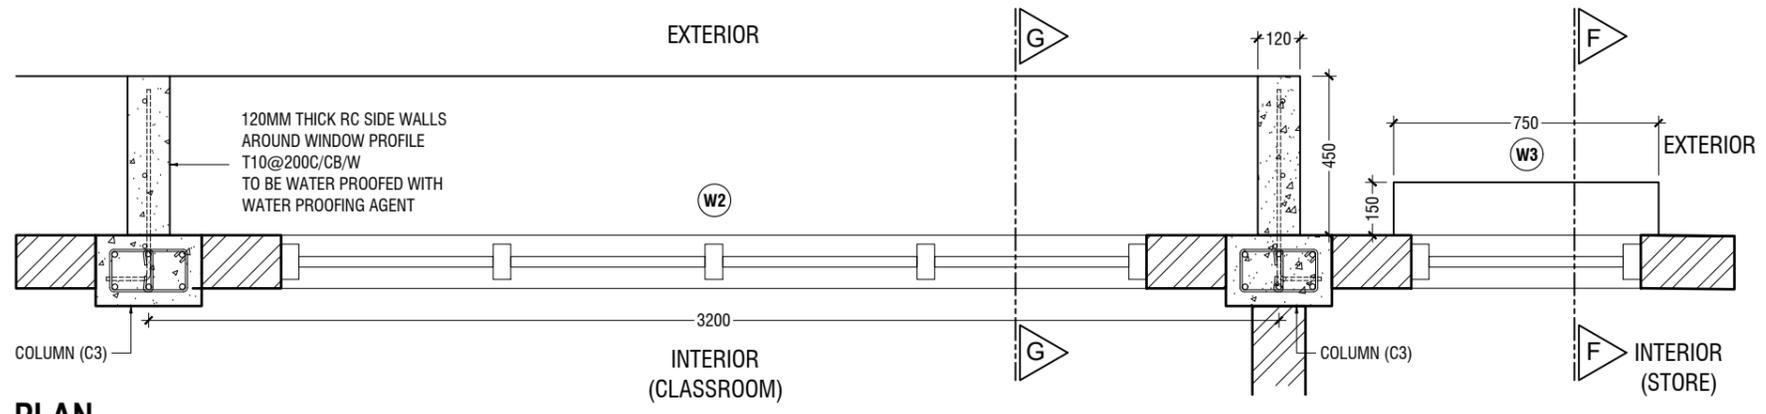

SECTION G-G
SCALE 1:20
* NOTE: GROUND FLOOR

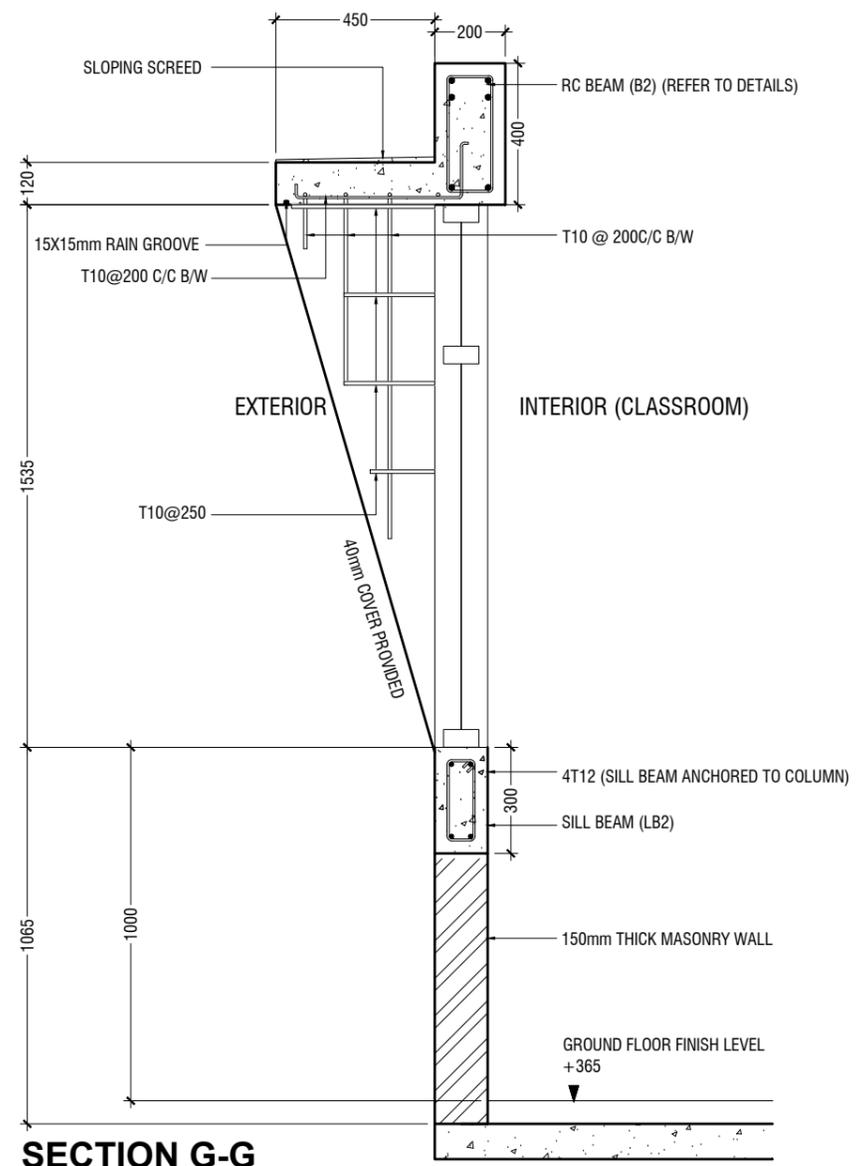

SECTION G-G
SCALE 1:20
* NOTE: FIRST FLOOR

DETAIL - 7
RC WALL DETAILS
SCALE 1:20

Th.Omadhoo School Health Room, Science Lab & 2 Classroom Block (2 story)
Client: Ministry of Education

Rev no	Date
01	01/04/2021
02	01/04/2021
03	01/04/2021
04	01/04/2021
05	01/04/2021
06	01/04/2021
07	01/04/2021
08	01/04/2021
09	01/04/2021
10	01/04/2021

Project Number: RI/2020/006
Date: April 2021
Architect: Maryam Irasha Shareef
Engineer: Mohamed Muhtalib Waleed
Drawn by: Maryam Leevan Jaleel
Services: Aishath Ahmed Interior



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Title: RC Wall details

Page: A-21/21

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GENERAL NOTES

THE GENERAL NOTES SHALL BE READ IN CONJUNCTION WITH THE CONTRACT SPECIFICATIONS AND DRAWINGS.

REGARDLESS OF WHETHER OR NOT SHOWN IN DRAWINGS OR OTHER TENDER DOCUMENTS, THE STANDARD PROVISIONS SPECIFIED HEREUNDER FOR COMPLIANCE BY THE CONTRACTOR SHALL APPLY TO ALL RELEVANT PORTIONS OF THE STRUCTURAL WORKS AND SHALL FORM PART OF THIS CONTRACT.

1.0 VERIFICATION OF DIMENSIONS AND LEVELS

- THE CONTRACTOR SHALL VERIFY ALL DIMENSIONS AND LEVELS ON SITE, AND RESOLVE ALL DISCREPANCIES WITH THE ARCHITECT OR ENGINEER PRIOR TO COMMENCEMENT OF WORK.
- DRAWING INDICATES GENERAL & TYPICAL DETAILS OF CONSTRUCTION. WHERE CONDITIONS ARE OF SIMILAR CHARACTER TO DETAILS SHOWN AND ALTHOUGH NOT SPECIFICALLY INDICATED, SIMILAR DETAILS OF CONSTRUCTION SHALL BE USED SUBJECT TO REVIEW BY THE ENGINEER.
- PRIOR TO COMMENCEMENT OF WORKS, THE CONTRACTOR SHALL VERIFY ALL DIMENSIONS AND LEVELS IN THE CONTRACT DRAWINGS.
- DISCREPANCIES IN DRAWINGS ARISING FROM SUCH VERIFICATION WORKS SHALL BE BROUGHT TO THE ATTENTION OF THE ARCHITECT/ENGINEER.

2.0 SHOP DRAWINGS

- THE CONTRACTOR SHALL BE SOLELY RESPONSIBLE FOR ENSURING TOTAL COORDINATION OF ALL WORKS AND SHALL TAKE SITE MEASUREMENTS PRIOR TO THE PREPARATION OF ANY SHOP DRAWINGS OR BEFORE COMMENCING FABRICATION.
- THE CONTRACTOR SHALL SUBMIT SHOP DRAWINGS FOR ALL SPECIALIST TRADES, SUCH AS PRESTRESSING, CURTAIN WALLING, ETC. FOR REVIEWS AND COMMENTS BY THE ARCHITECT/ENGINEER PRIOR TO COMMENCEMENT OF WORK. SUCH SHOP DRAWINGS SUBMITTED SHALL INCORPORATE ALL NECESSARY CONNECTION DETAILS TO THE STRUCTURAL MEMBERS SUCH AS CAST-IN INSERTS, EMBEDDED PLATES, ETC.

3.0 INCORPORATION OF M&E REQUIREMENTS IN THE STRUCTURE

- THE CONTRACTOR SHALL BE SOLELY RESPONSIBLE FOR ENSURING TOTAL COORDINATION OF STRUCTURAL, M & E PENETRATION DRAWINGS OF SERVICES AND SUBMIT SUCH SHOP DRAWINGS TO THE ARCHITECT/ENGINEER FOR REVIEWS AND APPROVAL PRIOR TO COMMENCEMENT OF WORK.
- THESE SHOP DRAWINGS SHALL INCORPORATE ALL MECHANICAL, ELECTRICAL AND SANITARY WORKS TO BE EMBEDDED IN CONCRETE AND ALL OPENINGS FOR ALL PIPE OR DUCT WORKS, BASED ON THE REQUIREMENTS OF M & E DRAWINGS IN HIS POSSESSION.
- HE SHALL CHECK AND RESOLVE ALL DISCREPANCIES WITH THE RESPECTIVE ENGINEER PRIOR TO PLACEMENT OF CONCRETE.

4.0 LEAN CONCRETE FOR SUSPENDED STRUCTURES

- UNLESS OTHERWISE STATED, 50 MM THICK LEAN CONCRETE WITH A MINIMUM 28-DAY CUBE STRENGTH OF 15N/MM² SHALL BE PROVIDED ON ALL SOIL SURFACES FORMING THE UNDERSIDE OF STRUCTURAL CONCRETE MEMBERS.

5.0 STRUCTURAL ELEMENTS ON GRADE

- UNLESS OTHERWISE STATED, A SINGLE LAYER OF 0.25 MM (HEAVY DUTY) POLYTHENE SHEET, OR EQUIVALENT THERMOPLASTIC MATERIAL, LAID OVER A COMPACTED 60 MM THICK LAYER OF HARD CORE BLINDED WITH SAND TO PREVENT GROUT LOSS FROM SEEPAGE INTO THE GROUND SHALL BE PROVIDED ON ALL SOIL SURFACES FORMING THE UNDERSIDE OF THE NON-SUSPENDED SLABS.

6.0 SUBGRADE UNDER STRUCTURAL ELEMENTS

- WHERE THE CONTRACTOR REQUIRES REMOVAL AND SUBSEQUENT BACKFILL OF SUBGRADE PRIOR TO CASTING OF PILECAP/WALL/BEAM/SLAB, HE SHALL ENSURE THAT THE BACKFILL IS OF APPROVED MATERIAL AND THAT THE BACKFILL SHALL BE REASONABLY COMPACTED TO ENSURE THAT THE COMPACTED SOIL IS ABLE TO WITHSTAND THE WEIGHT OF THE WET CONCRETE. THE CONTRACTOR SHALL EXERCISE PROPER SKILL AND CARE TO AVOID DAMAGE TO ADJACENT INSTALLED STRUCTURES ARISING FROM HIS CONSTRUCTION SEQUENCE.

7.0 WATERPROOFING FOR STRUCTURES

- THE CONTRACTOR SHALL SUBMIT SHOP DRAWINGS AND METHOD STATEMENTS FOR THE ENGINEER'S APPROVAL PRIOR TO COMMENCEMENT OF WORK. REQUIRED SHOP DRAWING DETAILS INCLUDE BUT ARE NOT LIMITED TO TREATMENT OF FLASHINGS, WATERSTOP AT CONSTRUCTION JOINTS, WALL AND SLAB PENETRATIONS.
- ALL PENETRATIONS THROUGH STRUCTURAL ELEMENTS SHALL BE CAST-IN, SLEEVED AND PROVIDED WITH APPROVED PUDDLE FLANGE DETAIL. IF FOR ANY REASON THE CONTRACTOR IS UNABLE TO LAY WATERSTOP AT CONSTRUCTION JOINTS AS INDICATED IN THE DRAWINGS, HE SHALL AT HIS OWN EXPENSES PROVIDE ADEQUATE GROUT TUBES FOR WATERPROOF PRESSURE GROUTING TO ENSURE WATERTIGHTNESS OF THE JOINT.
- ALL GROUT TUBES SHALL BE MARKED AND PROTECTED FROM BLOCKAGE.
- BACKFILLING OPERATIONS AGAINST VERTICAL SURFACE SHALL BE CARRIED OUT AS SOON AS THE WATERPROOFING BARRIER IS INSTALLED TO THE SATISFACTION OF THE ENGINEER.

8.0 CASTING LAYERS

- INCLINED CASTING LAYERS AND INCLINED CONSTRUCTION JOINTS SHALL BE AVOIDED.
- HORIZONTAL CASTING LAYERS SHALL NOT IN GENERAL EXCEED 0.6 M THICKNESS UNLESS OTHERWISE APPROVED BY THE ENGINEER.

9.0 FOUNDATIONS

- ALL FOUNDATIONS HAS BEEN DESIGNED FOR SAFE GROUND PRESSURE OF 150 KN/M².
- ALL BACKFILL SHOULD BE DONE WITH MATERIALS APPROVED BY THE CONSULTANT AND SOURCE. ALL BACKFILL SHOULD BE STRUCTURAL FILL, COMPACTED IN LAYERS AS SPECIFIED.
- WEAK POCKETS FOUND BELOW THE ASSUMED FOUNDATION LEVELS SHALL BE REMOVED AND REPLACED BY PLAIN CONCRETE.
- IN CASE OF EXCAVATIONS BELOW THE ASSUMED LEVEL OF THE FOUNDATION, THE SOIL SHALL BE REPLACED BY PLAIN CONCRETE.
- IN CASE GROUND WATER IS PRESENT ABOVE FOUNDATION LEVEL, THE CONTRACTOR SHALL BE RESPONSIBLE FOR DEWATERING THE BELOW LEVEL OF FOUNDATIONS.
- THE CONTRACTOR SHALL MAINTAIN DRY WORKING CONDITIONS THROUGH OUT THE CONSTRUCTION PERIOD. RESTORING WATER TABLE CAN BE DONE AFTER BACKFILLING AND COMPACTION UP TO THE SLAB ON GRADE LEVEL, OR AS DIRECTED BY THE ENGINEER.
- NO BACK FILLING SHALL BE PLACED AGAINST WALLS RETAINING EARTH, UNLESS THE WALLS ACHIEVE SUFFICIENT STRENGTH TO PREVENT MOVEMENT OR STRUCTURAL DAMAGE.

10.0 CONSTRUCTION LOAD AND SHORING

- CONSTRUCTION LIVE LOAD IMPOSED ON ANY SINGLE FLOOR SHALL NOT EXCEED 1.5 KN/M². UNLESS OTHERWISE APPROVED BY THE ENGINEER, DEAD LOAD OF THE TOP CONSTRUCTION FLOOR SHALL BE SUPPORTED BY TWO COMPLETED FLOORS DIRECTLY BELOW IT.
- PROPS TO BEAMS AND SLABS AT ANY FLOORS SHALL NOT BE REMOVED UNTIL THE TWO IMMEDIATE FLOORS ABOVE THAT LEVEL ARE CAPABLE OF SUPPORTING THEMSELVES AS WELL AS ANY LOADS IMPOSED DURING CONSTRUCTION. CONSIDERATIONS GOVERNING REMOVAL OF PROPS INCLUDE BUT ARE NOT LIMITED TO THE ATTAINMENT OF 28-DAY STRENGTH FOR THE CONCRETE, DESIGN LOAD CAPACITY OF THE FLOOR UNDER REVIEW AND THE COMPLETION OF PRESTRESSING AND GROUTING OPERATIONS IN THE CASE OF A PRESTRESSED STRUCTURAL FLOOR SYSTEM.

- PROPS SHALL BE LEFT IN PLACE FOR SUPPORTING THE CONSTRUCTION LOADS APPROVED BY THE ENGINEER.
- NO ALLOWANCE HAS BEEN MADE IN THE DESIGN OF THE PERIMETER BEAMS/WALLS FOR THE SUPPORT OF TEMPORARY SCAFFOLDINGS.
- THE CONTRACTOR SHALL ENGAGE HIS OWN PROFESSIONAL ENGINEER TO DESIGN AND STRENGTHEN THE BEAMS/WALLS.
- THE CONTRACTOR SHALL ENGAGE HIS OWN PROFESSIONAL ENGINEER CHECK THE ADEQUACY OF SHORING DETAIL PROVIDED PROCEEDING THE WORK, AS SHORING WAS DESIGNED, CONSIDERING THE STATUS OF THE BUILDING AT THE TIME OF DESIGN.

11.0 CONCRETE COVER

- MINIMUM COVER TO OUTERMOST REINFORCEMENT INCLUDING LINKS SHALL BE AS FOLLOWS.

STRUCTURAL ELEMENT	COVER (mm)
RAFT BEAM & SLAB (EARTH FACE)	60
RAFT BEAM & SLAB (INTERNAL FACE)	60
COLUMN	40
BEAM	35
BEAM (EXTERNAL FACE)	40
SLAB	30
INTERNAL WALL	30
EXTERNAL WALL	40

- NOTE: EARTH FACE COVER OF BEAMS, COLUMNS & WALLS SHOULD BE 50mm

12.0 MATERIAL STRENGTHS

12.1 CONCRETE

- UNLESS OTHERWISE STATED, ORDINARY PORTLAND CEMENT CONFORMING TO BS 12, TO BE USED FOR ALL THE RC STRUCTURAL ELEMENTS.
- THE MINIMUM 28-DAY COMPRESSIVE CUBE STRENGTH OF CONCRETE FOR SPECIFIED STRUCTURAL ELEMENTS SHALL BE AS FOLLOWS UNLESS OTHERWISE STATED:

MAIN BUILDING	
LEAN CONCRETE	15 N/mm ²
MASS CONCRETE	30 N/mm ²
COLUMN, BEAM AND SLAB	30 N/mm ²
EXTERNAL WORK	
PAVEMENTS	30 N/mm ²
ALL OTHERS (CULVERT, DRAINS, MANHOLE, ETC)	30 N/mm ²
FOUNDATION	
PILECAP, FOOTING, RAFT TIE-BEAM, CAPPING BEAM	30 N/mm ²

- CEMENT SHALL BE ORDINARY PORTLAND CEMENT TO BS 12.

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Engineer : Mohamed Muththaliib Waleed	3	11/04/2021
Drawn by : Mariyam Leevyan Jaleel	4	11/04/2021
Services : Alishath Ahmed	5	11/04/2021
Interior : -		



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12.2 REINFORCEMENT

- UNLESS OTHERWISE STATED, BAR SIZE 10MM DIAMETER OR LARGER SHALL BE HIGH TENSILE TYPE II DEFORMED BARS. THE MINIMUM YIELD STRENGTH OF STEEL BAR REINFORCEMENT SHALL BE AS FOLLOWS:

MILD STEEL PLAIN BAR	250 N/mm ²
HIGH TENSILE TYPE II DEFORMED BAR	415 N/mm ²

12.25 REINFORCEMENT ANCHORAGE OR LAPPING IS AS FOLLOWS U.N.O.

BAR GRADE 415	
TENSION	45Ø
COMPRESSION	45Ø

Ø IS DIAMETER OF THE SMALLER SIZED LAPPED BAR.

- NO SPLICE SHALL BE MADE AT POINT OF MAXIMUM STRESS, EG IN BEAMS AND SLABS. THERE SHALL BE NO SPLICING OF TOP BARS OVER SUPPORTS NOR BOTTOM BARS AT MID-SPANS. SPLICES SHALL BE STAGGERED WHEREVER POSSIBLE. LAP LENGTH FOR UNEQUAL SIZE BARS (OR WIRES IN FABRIC) MAY BE BASED UPON THE SMALLER BAR. FOR BUNDLED BARS, THE EQUIVALENT DIAMETER SHALL BE USED. CRANKING OF BARS SHALL NOT EXCEED A SLOPE OF 1:10.
- FOR LAP LENGTH, WHERE SYMBOLS ARE NOT INDICATED, THE TENSION LAP LENGTH SHALL BE FOLLOWED.

13.0 STIRRUPS, LINKS AND TIES

- ALL STIRRUPS, LINKS AND TIES IN BEAMS, COLUMNS AND WALLS RESPECTIVELY SHALL TERMINATE NOT MORE THAN 75mm FROM THE FACE OF ANY ADJACENT STRUCTURAL MEMBERS.

14.0 SLAB DISTRIBUTION BARS

- REGARDLESS OF WHETHER OR NOT SHOWN ON PLAN, ALL DISTRIBUTION BARS FOR SLAB SHALL COMPRISE TYPICALLY ONE OF THE FOLLOWING COMBINATIONS, UNLESS OTHERWISE STATED IN THE RELEVANT DRAWINGS :

SLAB THICKNESS (mm)	MIN. DISTRIBUTION BAR
250 OR LESS	T10-300
GREATER THAN 250 BUT LESS THAN OR EQUAL TO 300	T10-200
GREATER THAN 300 BUT LESS THAN OR EQUAL TO 400	T10-150

15.0 FLOOR RENDERING

- THICKNESS OF SCREED RENDERING/MASS CONCRETE TOPPING EXCEEDING 60 OR MORE SHALL BE REINFORCED WITH ONE LAYER OF R6.

16.0 SHRINKAGE CRACKS


- THE SURFACE OF CONCRETE SHALL BE ADEQUATELY AND CONTINUOUSLY CURED TO SPECIFICATION TO PREVENT FORMATION OF SHRINKAGE CRACKS. THOUGH SHRINKAGE CRACKS HAVE NO EFFECT ON THE STRENGTH AND INTEGRITY OF THE STRUCTURE, THEY SHOULD BE SEALED BY EPOXY PRESSURE GROUTING. ALL COST INCURRED FOR THE NECESSARY SEALING UP OF SHRINKAGE CRACKS BY EPOXY PRESSURE GROUTING SHALL BE DEEMED TO BE INCLUDED IN THE CONCRETE WORK AS TENDERED.

17.0 STEEL BAR CORROSION PROTECTION


- ALL EXPOSED BARS FOR FUTURE CONSTRUCTION PURPOSES (EXCEEDING 3 MONTHS) MUST BE COATED WITH MASTER EMACO 8100 AP OR APPROVED EQUIVALENT AND PROVIDED WITH ADEQUATE MAINTENANCE.

18.0 SPACER BARS


- ALL SPACER BARS BETWEEN 2 OR MORE LAYERS OF REINFORCEMENT SHALL T25 OR BAR DIAMETER (WHICHEVER IS GREATER) AT ±1-5M C/C.

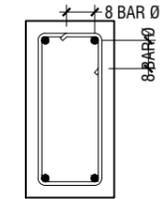


Ø = DIA OF LINK
SHEAR LINKS ANCHORAGE DETAIL

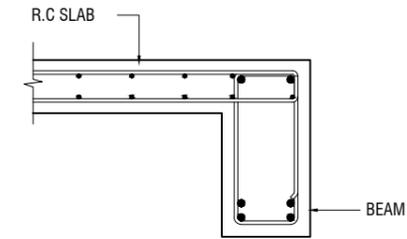

SLAB-BEAM ANCHORAGE DETAIL

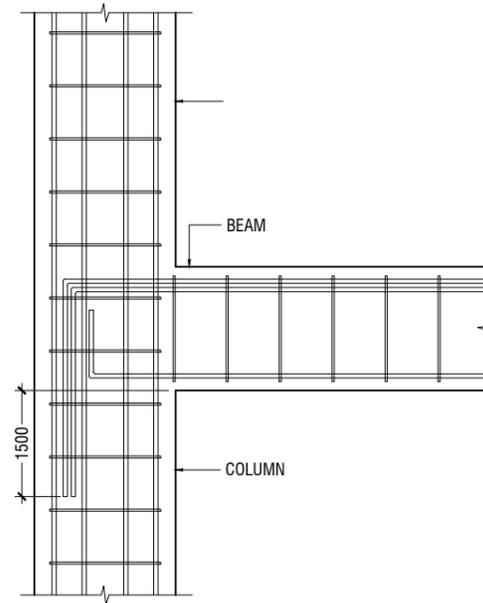

BEAM TO COLUMN CONNECTION

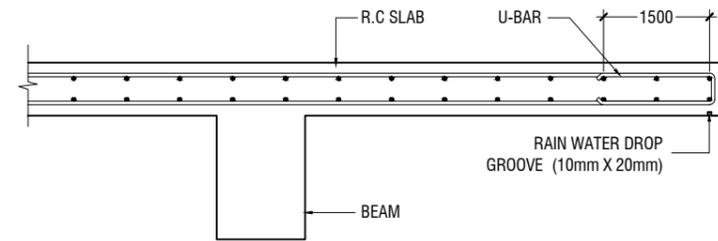

CANTILEVERED SLAB EDGE DETAIL

Th.Omadhoo School Health Room, Science Lab & 2 Classroom Block (2 story)
Client: Ministry of Education

Rev no	Date
1
2
3
4

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Date: April 2021
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Services: Alishah Ahmed
Interior:



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19.0 STRUCTURAL TIMBER SPECIFICATION

19.1 THE CONTRACT STRUCTURAL DRAWINGS AND SPECIFICATIONS REPRESENT THE COMPLETED STRUCTURE, AND ARE NOT INTENDED TO INDICATE THE METHOD OR MEANS OF CONSTRUCTION. THE CONTRACTOR SHALL SUPERVISE AND DIRECT THE WORK AND SHALL BE SOLELY RESPONSIBLE FOR ALL CONSTRUCTION MEANS, METHODS, PROCEDURES, TECHNIQUES, SEQUENCES, AND FOR JOB SAFETY.

19.2 THE ENGINEER DOES NOT HAVE CONTROL OR CHARGE OF, AND SHALL NOT BE RESPONSIBLE FOR, CONSTRUCTION MEANS, METHODS, TECHNIQUES, SEQUENCES, OR PROCEDURES, FOR SAFETY PRECAUTIONS AND PROGRAMS IN CONNECTION WITH THE WORK, FOR THE ACTS OR OMISSIONS OF THE CONTRACTOR, SUBCONTRACTOR, OR ANY OTHER PERSONS PERFORMING ANY OF THE WORK, OR FOR THE FAILURE OF ANY OF THEM TO CARRY OUT THE WORK IN ACCORDANCE WITH THE CONTRACT DOCUMENTS.

19.3 ALL CONSTRUCTION IS IN COMPLIANCE WITH THE CONSTRUCTION DOCUMENTS. THE GENERAL CONTRACTOR SHALL BE RESPONSIBLE FOR PERFORMING ALL WORK IN COMPLIANCE WITH THE CONSTRUCTION DOCUMENTS.

19.4 ALL TIMBER FOR STRUCTURAL USE SHALL BE HARDWOOD OR SOFTWOOD OF VISUAL GRADE C/D IN ACCORDANCE WITH BS 5756 WITH THE FOLLOWING MINIMUM GRADE STRESSES:

19.5 CONNECTIONS

PLATES - STAINLESS STEEL GRADE 316 OF STATED THICKNESS
BOLTS - SS GRADE 316

19.6 TIMBER TREATMENT

MOISTURE - PRESSURE IMPREGNATION OF CCA
INSECTS - TERMITE TREATMENT FOR TIMBER IN / NEAR GROUND

20.0 STRUCTURAL STEEL SPECIFICATION

1. SEE 21.0 ON PRIMARY CODES AND SPECIFICATIONS.

2. MATERIALS:

W-SHAPES & WT-SHAPES..... ASTM A992
S-SHAPES, M-SHAPES, HP-SHAPES..... ASTM A36
ST-SHAPES & MT-SHAPES..... ASTM A36
C-SHAPES & MC-SHAPES..... ASTM A36
ANGLES & PLATES..... ASTM A36
HSS SHAPES..... ASTM A500, GRADE B
STEEL PIPE..... ASTM A53 (TYPE E OR S), GRADE B
HIGH STRENGTH BOLTS..... ASTM A325
MACHINE BOLTS..... ASTM A307
ANCHOR RODS..... ASTM F1554, GRADE 55 TYPE S1 (UNO)
WELDED HEADED STUDS..... ASTM A108
DEFORMED BAR ANCHORS..... ASTM A496
WELDING ELECTRODES..... AWS D1.1, E70 SERIES

3. NON-SHRINK, NON-METALLIC GROUT WITH A 28 DAY STRENGTH OF 35MPa SHALL BE USED UNDER BASE PLATES AND SHALL CONFORM TO BS EN 12390-3 AND EN 196-1. MASTERFLOW 542 OR EQUIVALENT MAYBE USED.

23.0 POST-INSTALLED ANCHORS

1. POST-INSTALLED ANCHORS SHALL ONLY BE USED WHERE SPECIFIED ON THE DRAWINGS. CONTRACTOR SHALL OBTAIN APPROVAL FROM ENGINEER OF RECORD (EOR) PRIOR TO USING POST-INSTALLED ANCHORS FOR MISSING OR MISPLACED ANCHORS.

2. CARE SHALL BE GIVEN TO AVOID CONFLICTS WITH EXISTING REINFORCING WHEN DRILLING HOLES. HOLES SHALL BE DRILLED AND CLEANED PER THE MANUFACTURER'S INSTRUCTIONS. ANCHORS SHALL BE INSTALLED PER THE MANUFACTURER'S INSTALLATION INSTRUCTIONS AT NOT LESS THAN MINIMUM EDGE DISTANCES AND/OR SPACINGS INDICATED IN THE MANUFACTURER'S LITERATURE.

3. SPECIAL INSPECTION SHALL BE PROVIDED FOR ALL ADHESIVE AND MECHANICAL ANCHOR INSTALLATIONS AS REQUIRED BY THE EOR. INDEPENDENT ON-SITE PROOF LOAD TESTING SHALL BE PERFORMED AS REQUIRED BY THE EOR. CONTACT EOR FOR NUMBER OF ANCHORS REQUIRED TO BE TESTED AND REQUIRED PROOF LOAD MAGNITUDE.

Th.Omadhoo School Health Room, Science Lab & 2 Classroom Block (2 story)
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Drawn by : Mariyam Leevan Jaleel	--	-----
Services : Aishath Ahmed	--	-----
Interior : -	--	-----






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NOTE:
 STANDARD DETAILS GIVEN HERE ALSO APPLIES TO FOUNDATION MEMBERS
 OTHER DETAILS NOT FOUND HERE SHALL BE REFERRED TO IN RELEVANT BS
 CODES OR SHALL BE APPROVED BY CLIENT'S ENGINEER

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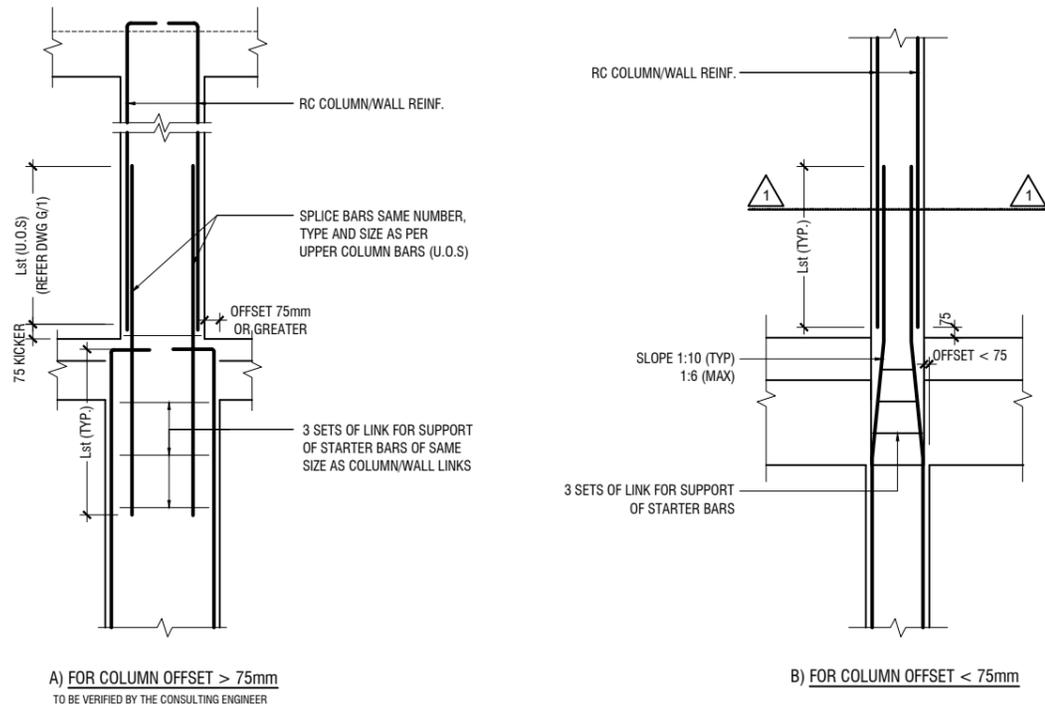


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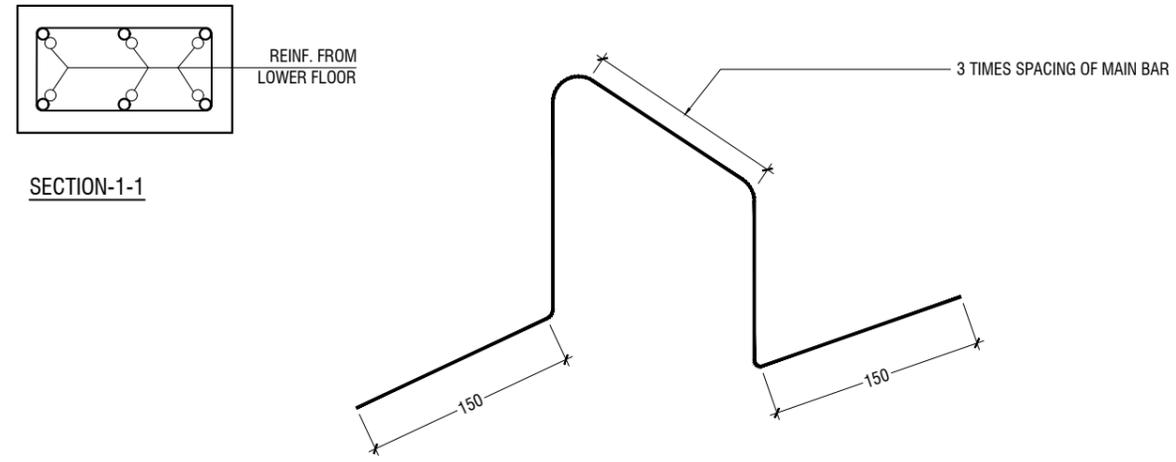
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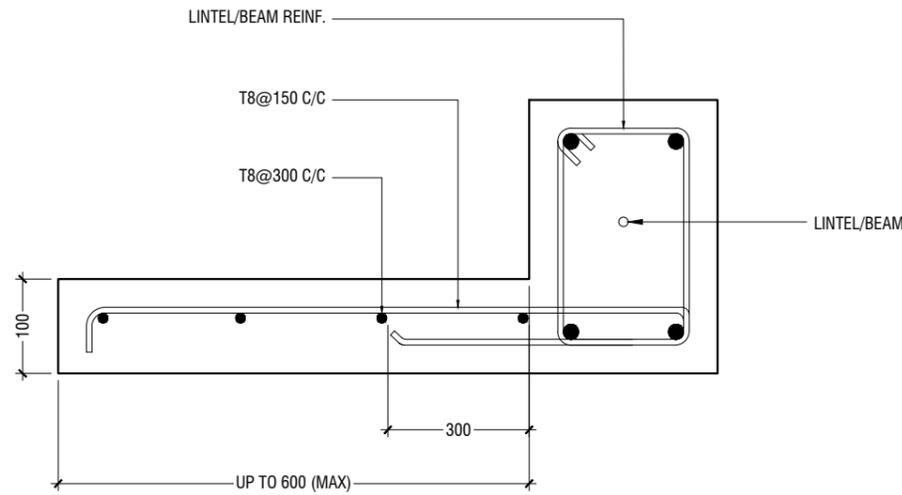
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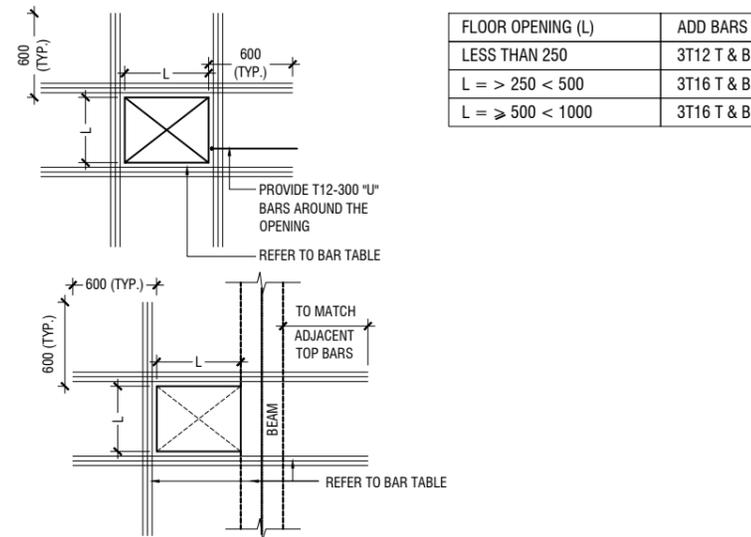
COLUMN/WALL REINF. LAPPING DETAIL AT FLOOR LEVEL

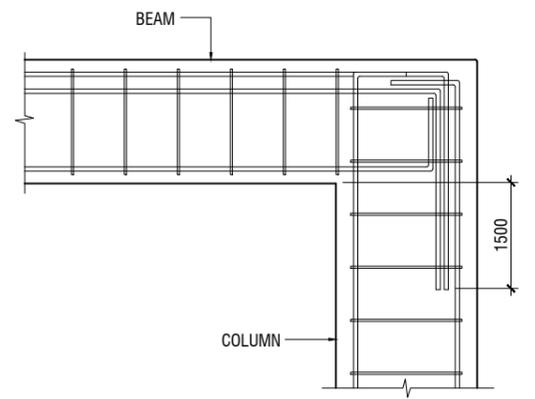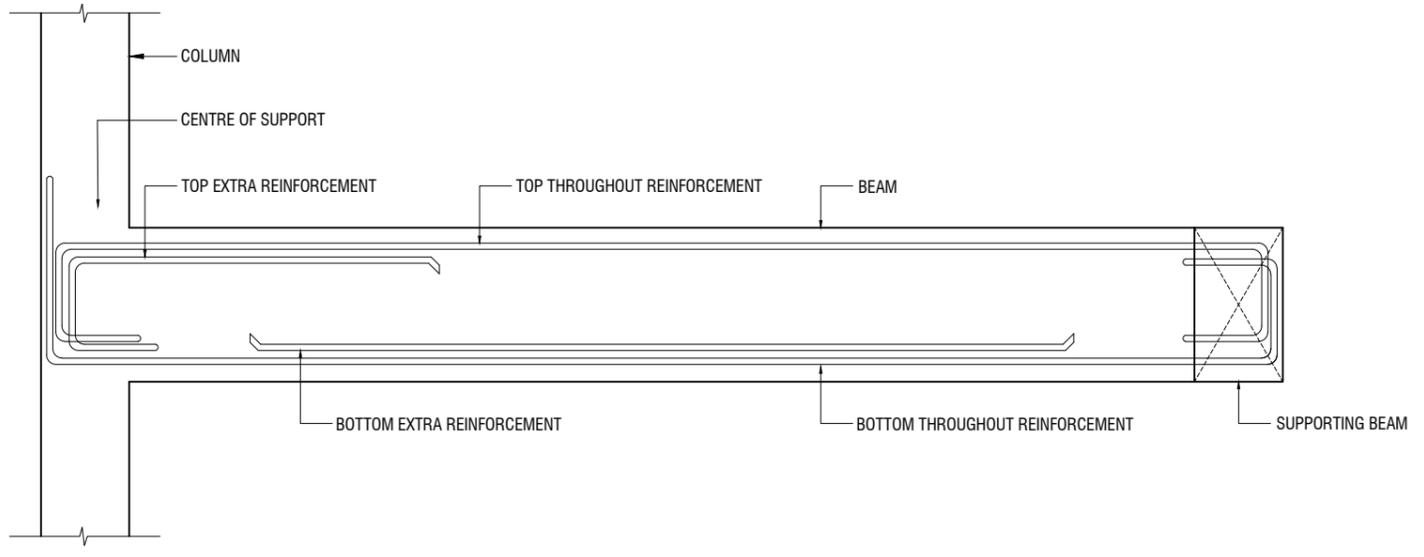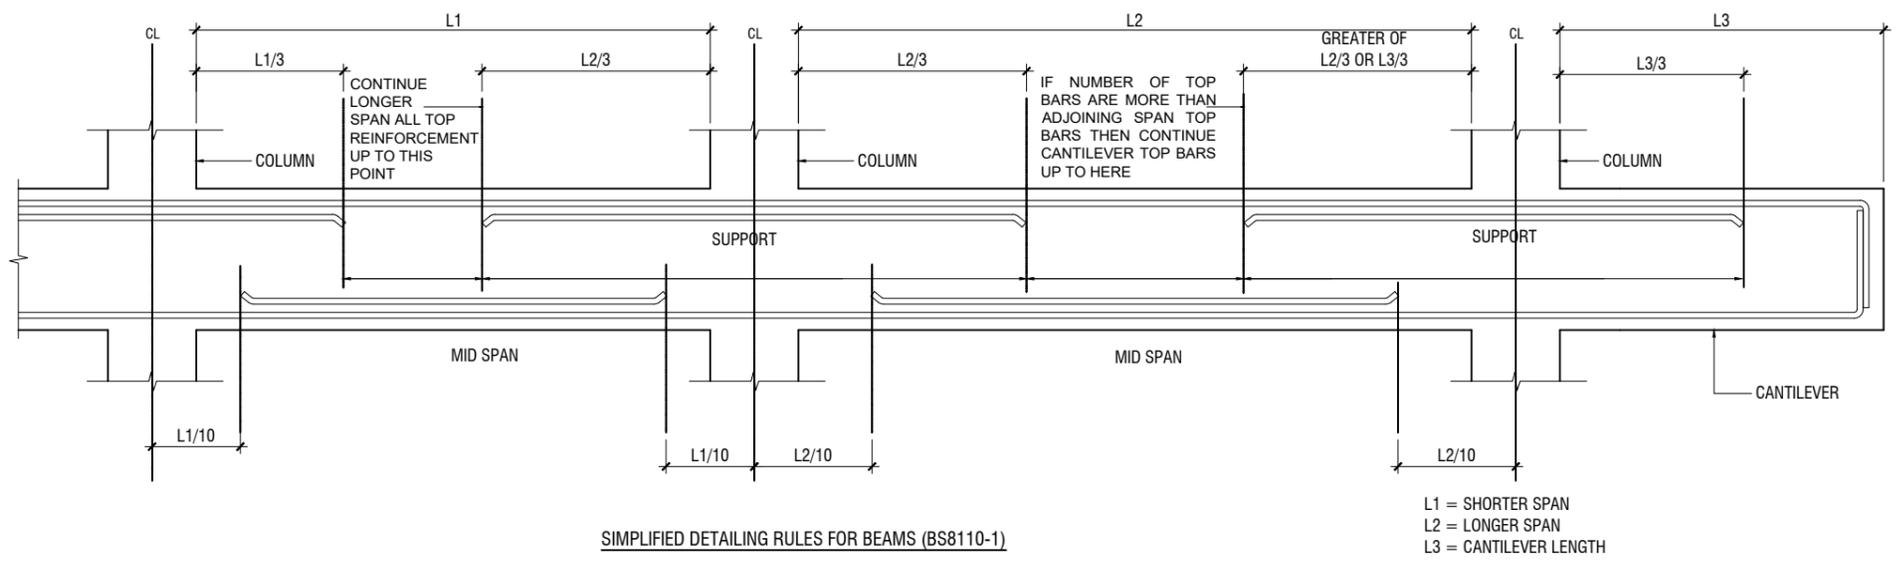

TYPICAL CHAIR DETAIL



TYPICAL CANTILEVER DETAILS



- NOTE:-**
- FOR OPENINGS LESS THAN 200x200. SLAB REBARS TO BE ADJUSTED AROUND OPENING.
 - FOR OPENINGS GREATER THAN 250x250 TO BE APPROVED BY THE ENGINEER.
 - ALL SLAB OPENINGS LOCATION TO BE APPROVED BY THE ENGINEER.
 - EQUIVALENT OPENING AREA SHALL APPLY THE DETAILS SHOWN ABOVE.
 - EQUIVALENT OPENING AREA SHALL INCLUDE RECTANGLE, TRIANGLE AND ANY POLYGON SHAPE.
 - EXCEPT HACKING, NO SLAB CORING ARE ADVISABLE FOR POST-TENSIONED SLAB.

TYPICAL TRIMMER BARS DETAILS FOR OPENING IN SLABS

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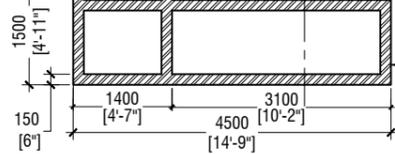
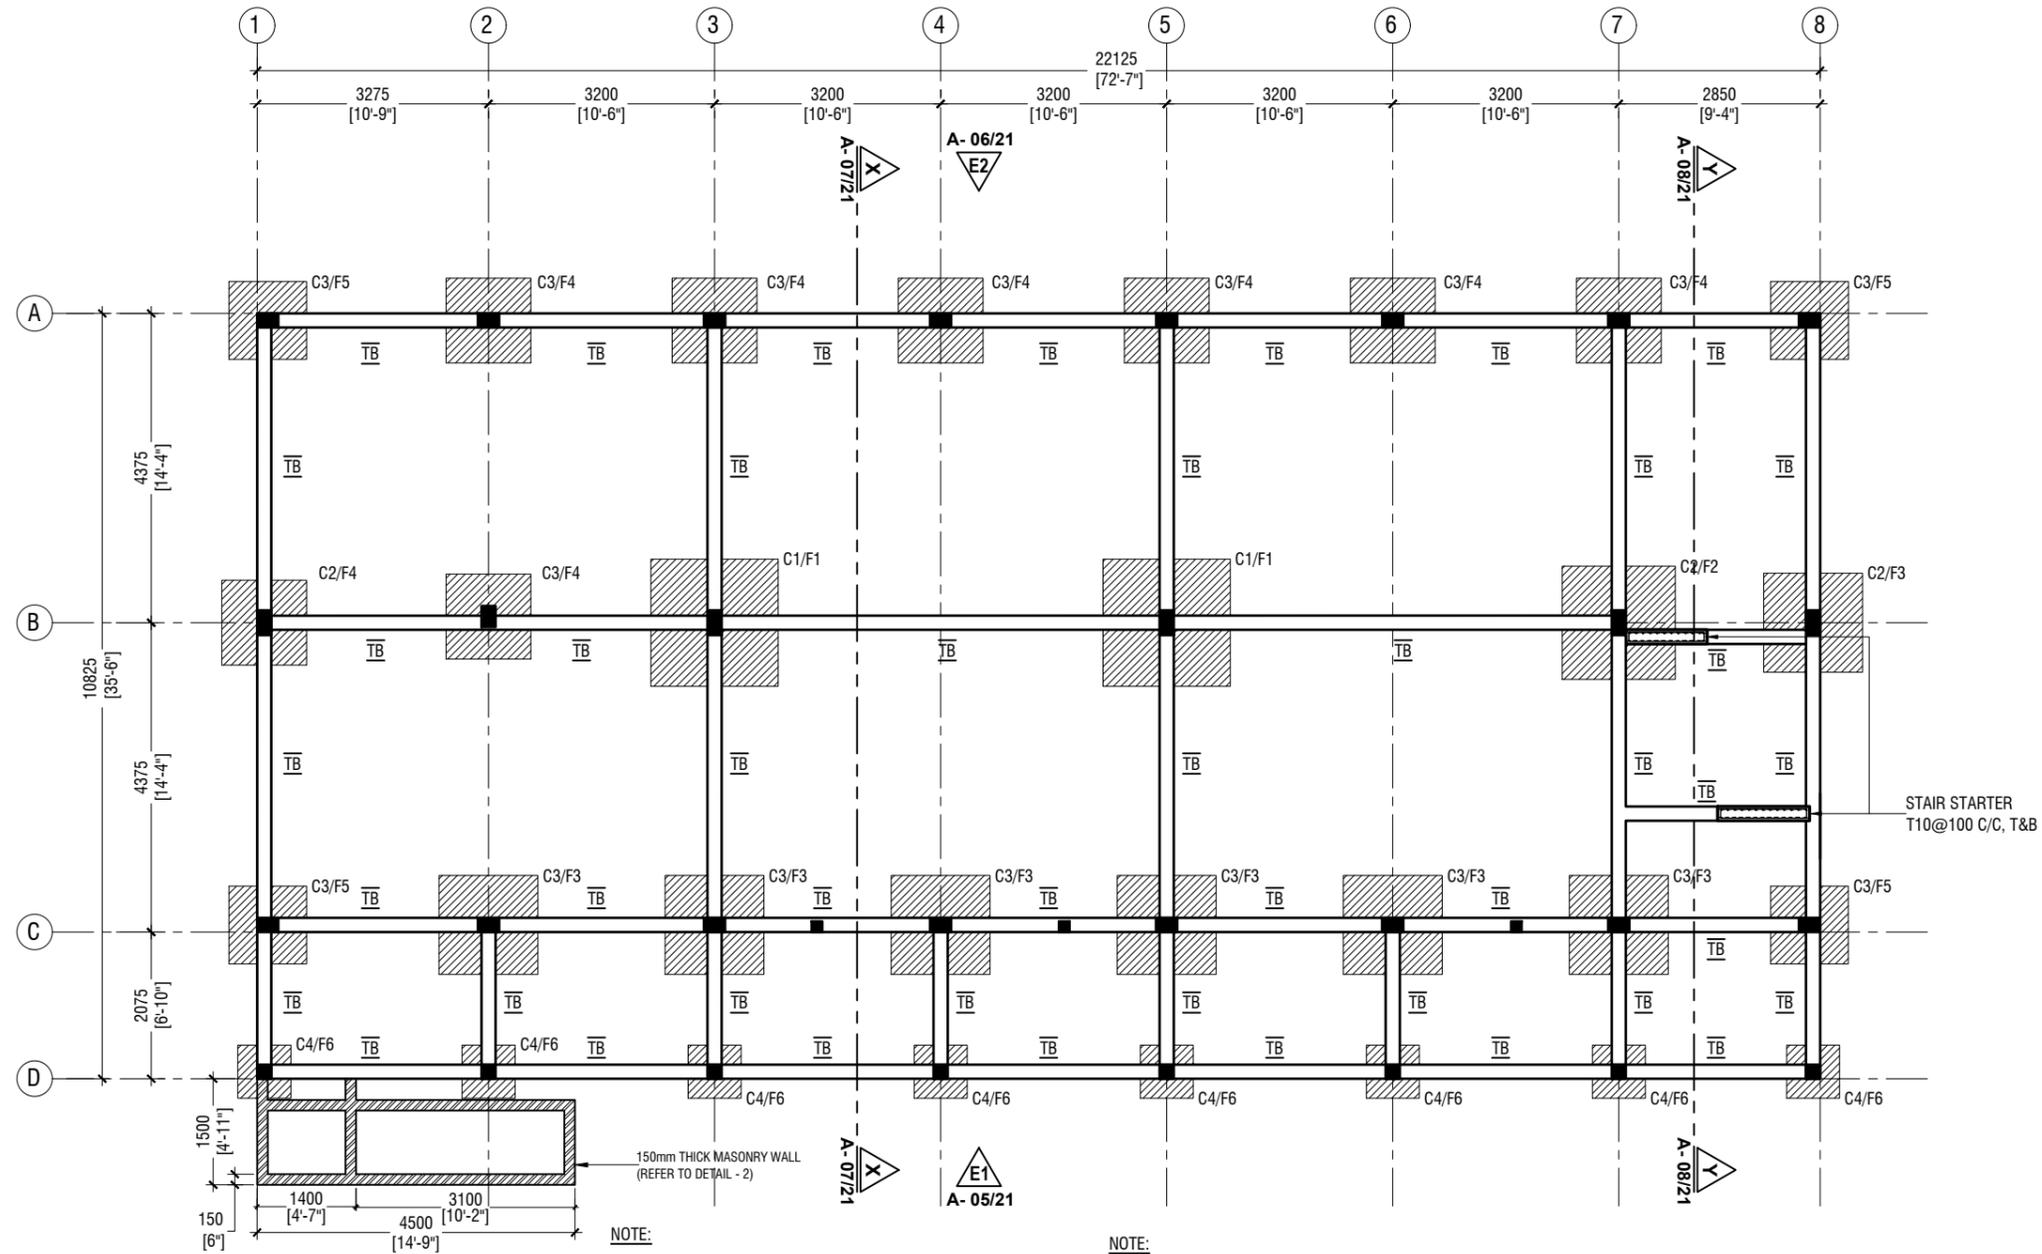


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NOTE:

COLUMN SIZES

- C1 : 200 x 350 mm
- C2 : 200 x 350 mm
- C3 : 200 x 300 mm
- C4 : 200 x 200 mm
- SC : 150 x 150 mm
- COVER : 40mm

FOUNDATION PAD SIZES

	DIMENSION	REINFORCEMENT
F1	1800 x 1800 x 300	T16@150 C/C B/W (B)
F2	1600 x 1600 x 300	T12@150 C/C B/W (B)
F3	1400 x 1400 x 300	T12@150 C/C B/W (B)
F4	1200 x 1200 x 300	T12@150 C/C B/W (B)
F5	1100 x 1100 x 300	T12@150 C/C B/W (B)
F6	750 x 750 x 300	T12@150 C/C B/W (B)

NOTE:

CONCRETE COVER

- COLUMN : 40mm
- SLAB : 30mm
- BEAM : 35mm
- FOOTING : 50mm
- TIE BEAM : 50mm

LAP LENGTH FOR BARS

- 25MM : 1125 mm
- 20MM : 900 mm
- 16MM : 720 mm
- 12MM : 550 mm
- 10MM : 450 mm

CONCRETE GRADE = M25

SAFE BEARING CAPACITY = 150KPa

HOOK LENGTH AND OTHER DETAILS ARE PROVIDED IN THE GENERAL NOTES

FOUNDATION DEPTH : 1200mm BELOW GROUND LEVEL

ALL FOOTINGS ARE TO BE LAID ON TOP OF 50mm THICK LEAN CONCRETE
APPLY WATER PROOFING TO SUBSTRUCTURE (BELOW GROUND ELEMENTS)

TIE BEAM SIZES

- TB : 200 x 450 mm
- COVER : 50mm

GROUND SLAB : 100mm THK RC SLAB ON FILL REINFORCED WITH T10@200 C/C BW

-150mm THK. SOLID MASONRY BLOCK WALL

RAMP SLAB : 100mm THK RC SLAB ON COMPACTED FILL REINFORCED WITH T10@200 C/C BW

FOUNDATION PLAN

SCALE 1:100



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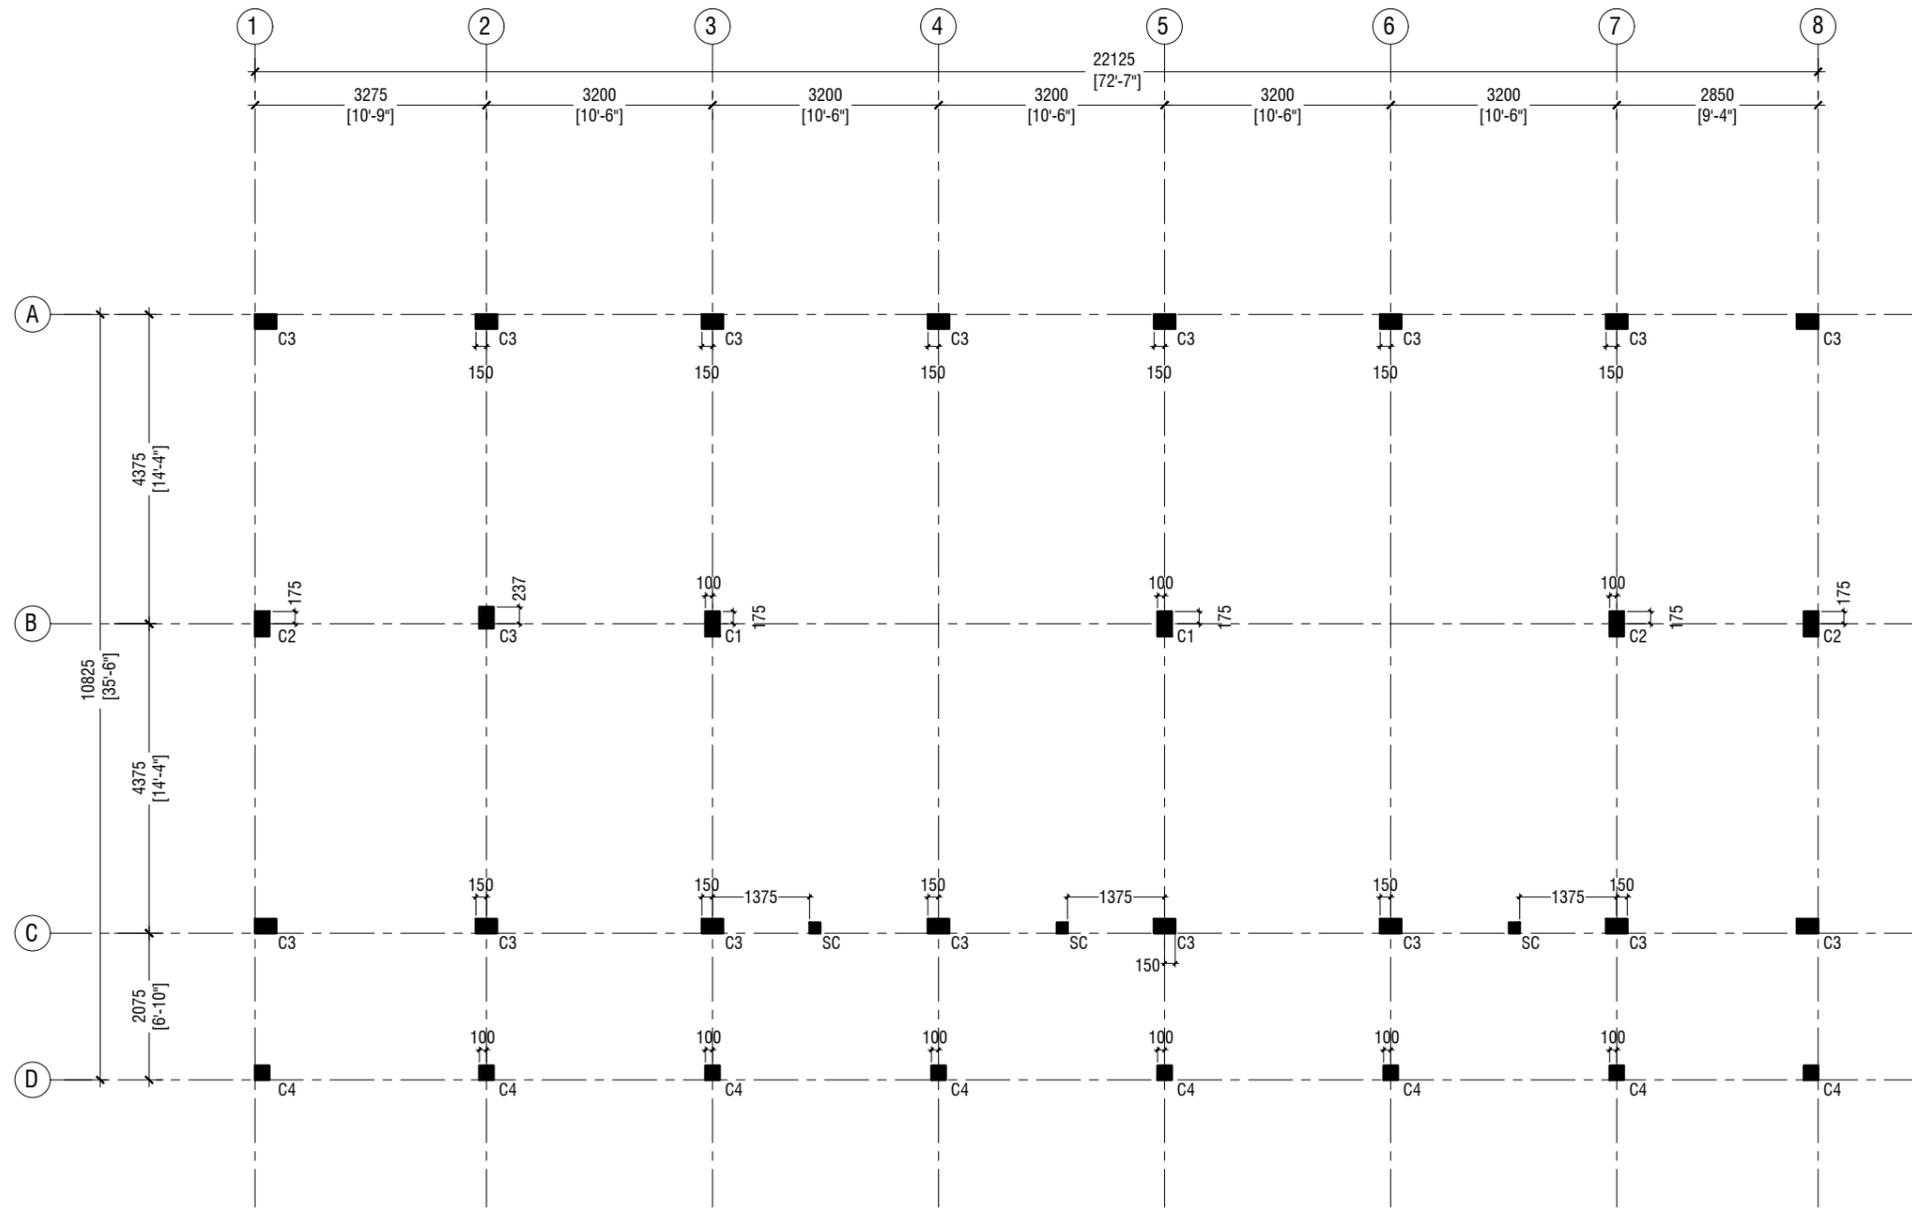
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Title: Foundation Plan

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NOTE:

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- C3 : 200 x 300 mm
- C4 : 200 x 200 mm
- SC : 150 x 150 mm
- COVER : 40mm

FIRST FLOOR COLUMN LAYOUT PLAN

SCALE 1:100



Th.Omadhoo School Health Room, Science Lab & 2 Classroom Block (2 story)
Client: Ministry of Education

Rev no	Date

Project Number: RI/2020/006

Date: April 2021

Architect: Mariyam Iqasha Shareef

Engineer: Mohamed Muththaliq Waleed

Drawn By: Mariyam Laveyan Jaleel

Services: Alshath Ahmed

Interior: -




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3rd floor, H. Azum, Ameenleemsgu, Male'

Title: First Floor Column Layout Plan

Page: S-02/12

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NOTE:

BEAM SIZES

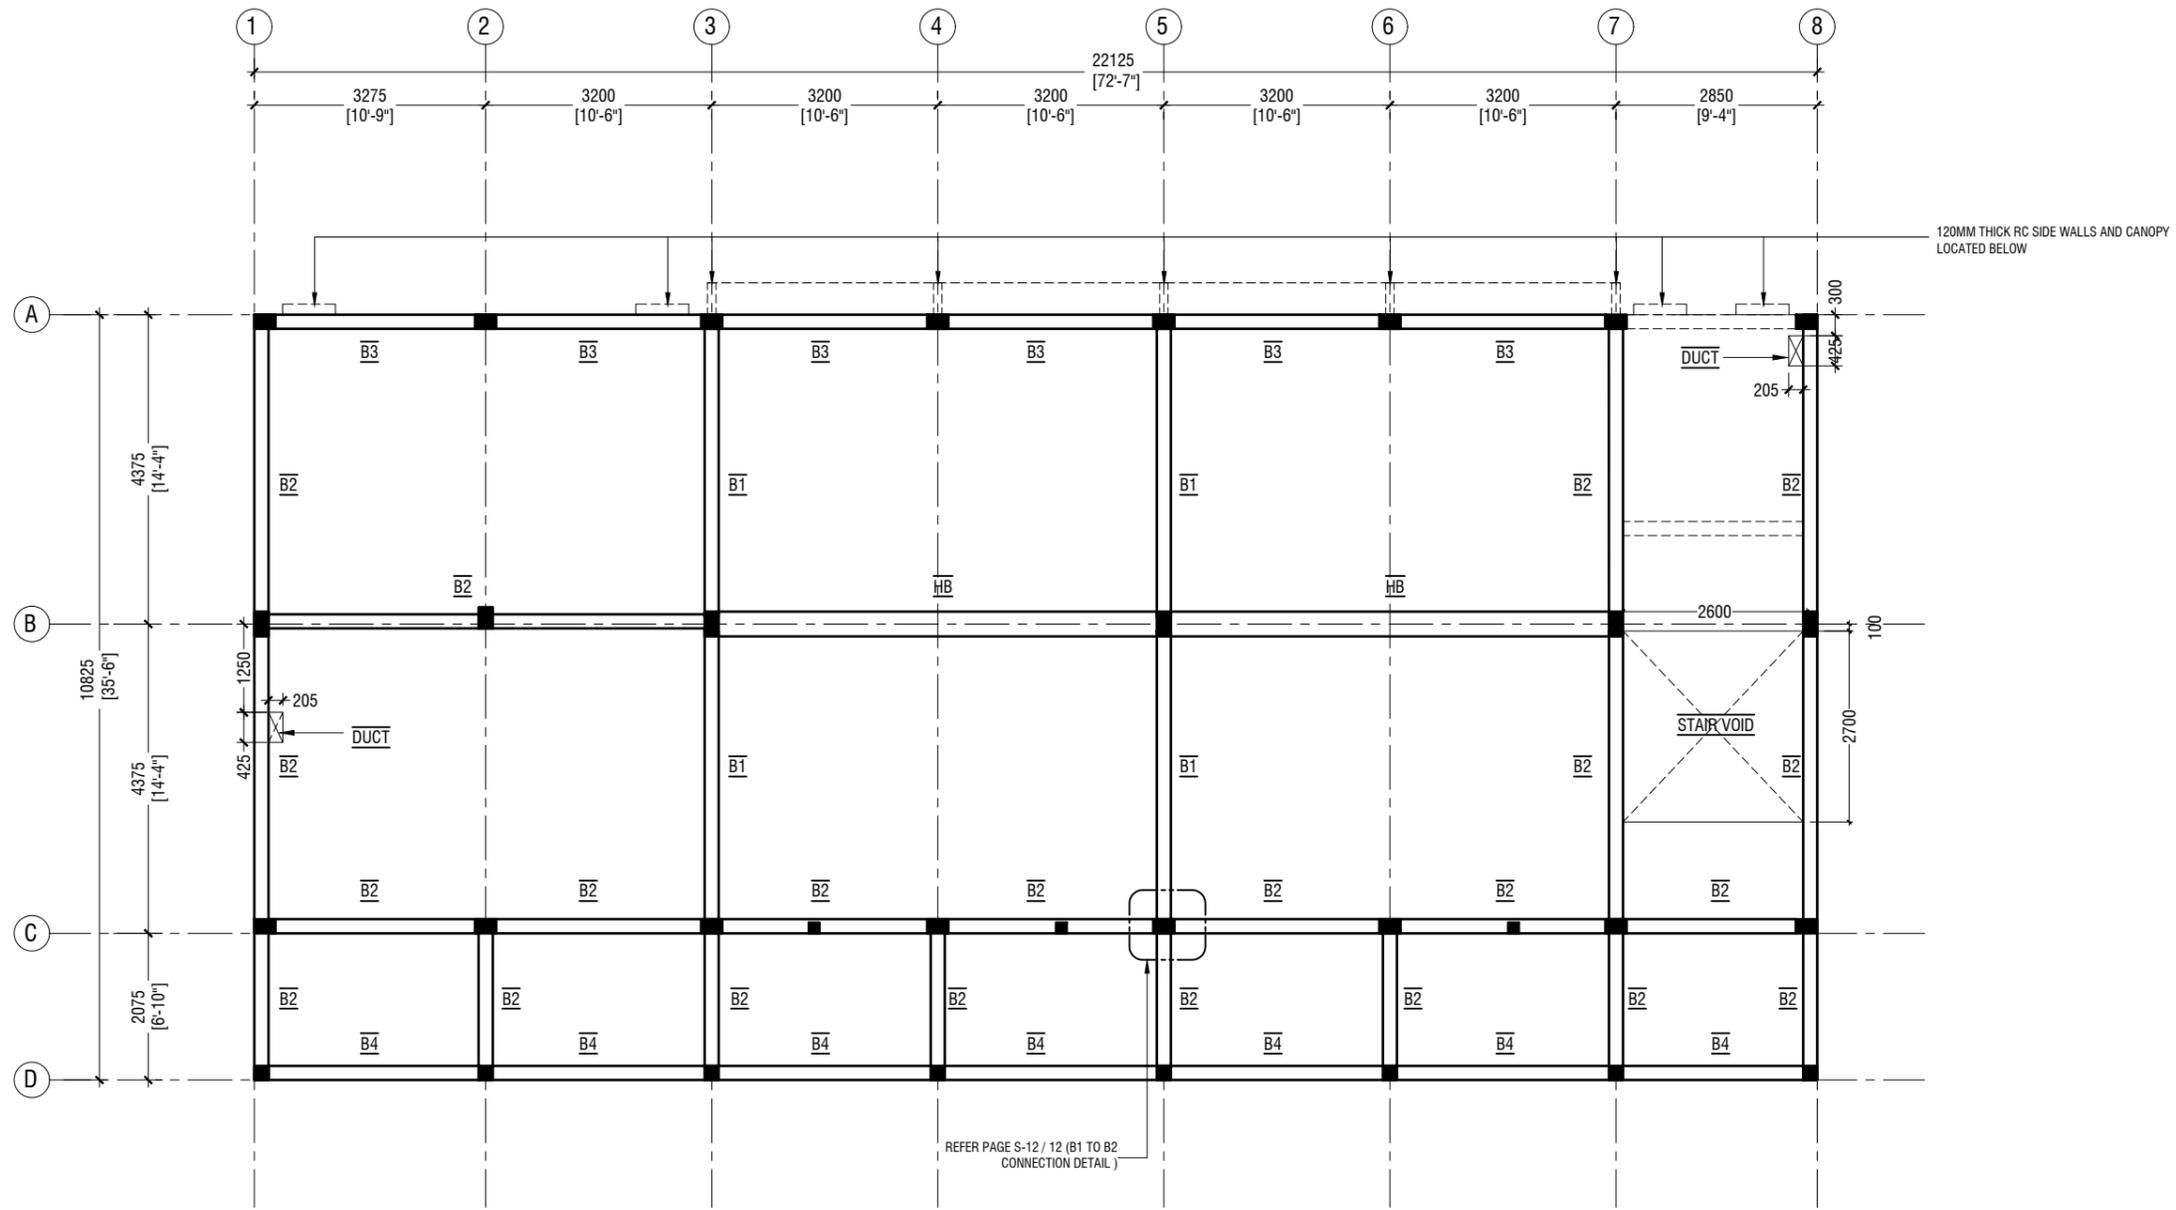B1	: 200x475 mm
B2	: 200x400 mm
B3	: 200x400 mm
B4	: 200x400 mm
HB	: 350x180 mm
COVER	: 35mm

FIRST FLOOR BEAM PLAN

SCALE 1:100



Th.Omadhoo School Health Room, Science Lab & 2 Classroom Block (2 story)
Client: Ministry of Education

Project Number: RI/2020/006	Rev no	Date
Date: April 2021		
Architect: Mariyam Irasha Shareef		
Engineer: Mohamed Muthalib Walleed		
Drawn by: Mariyam Leevan Jaleel		
Services: Alshah Alimed		




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Title: First Floor Beam Plan

Page: S-03/12

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NOTE:

BEAM SIZES

- B1 : 200x475 mm
- B2 : 200x400 mm
- B3 : 200x400 mm
- B4 : 200x400 mm
- COVER : 35mm

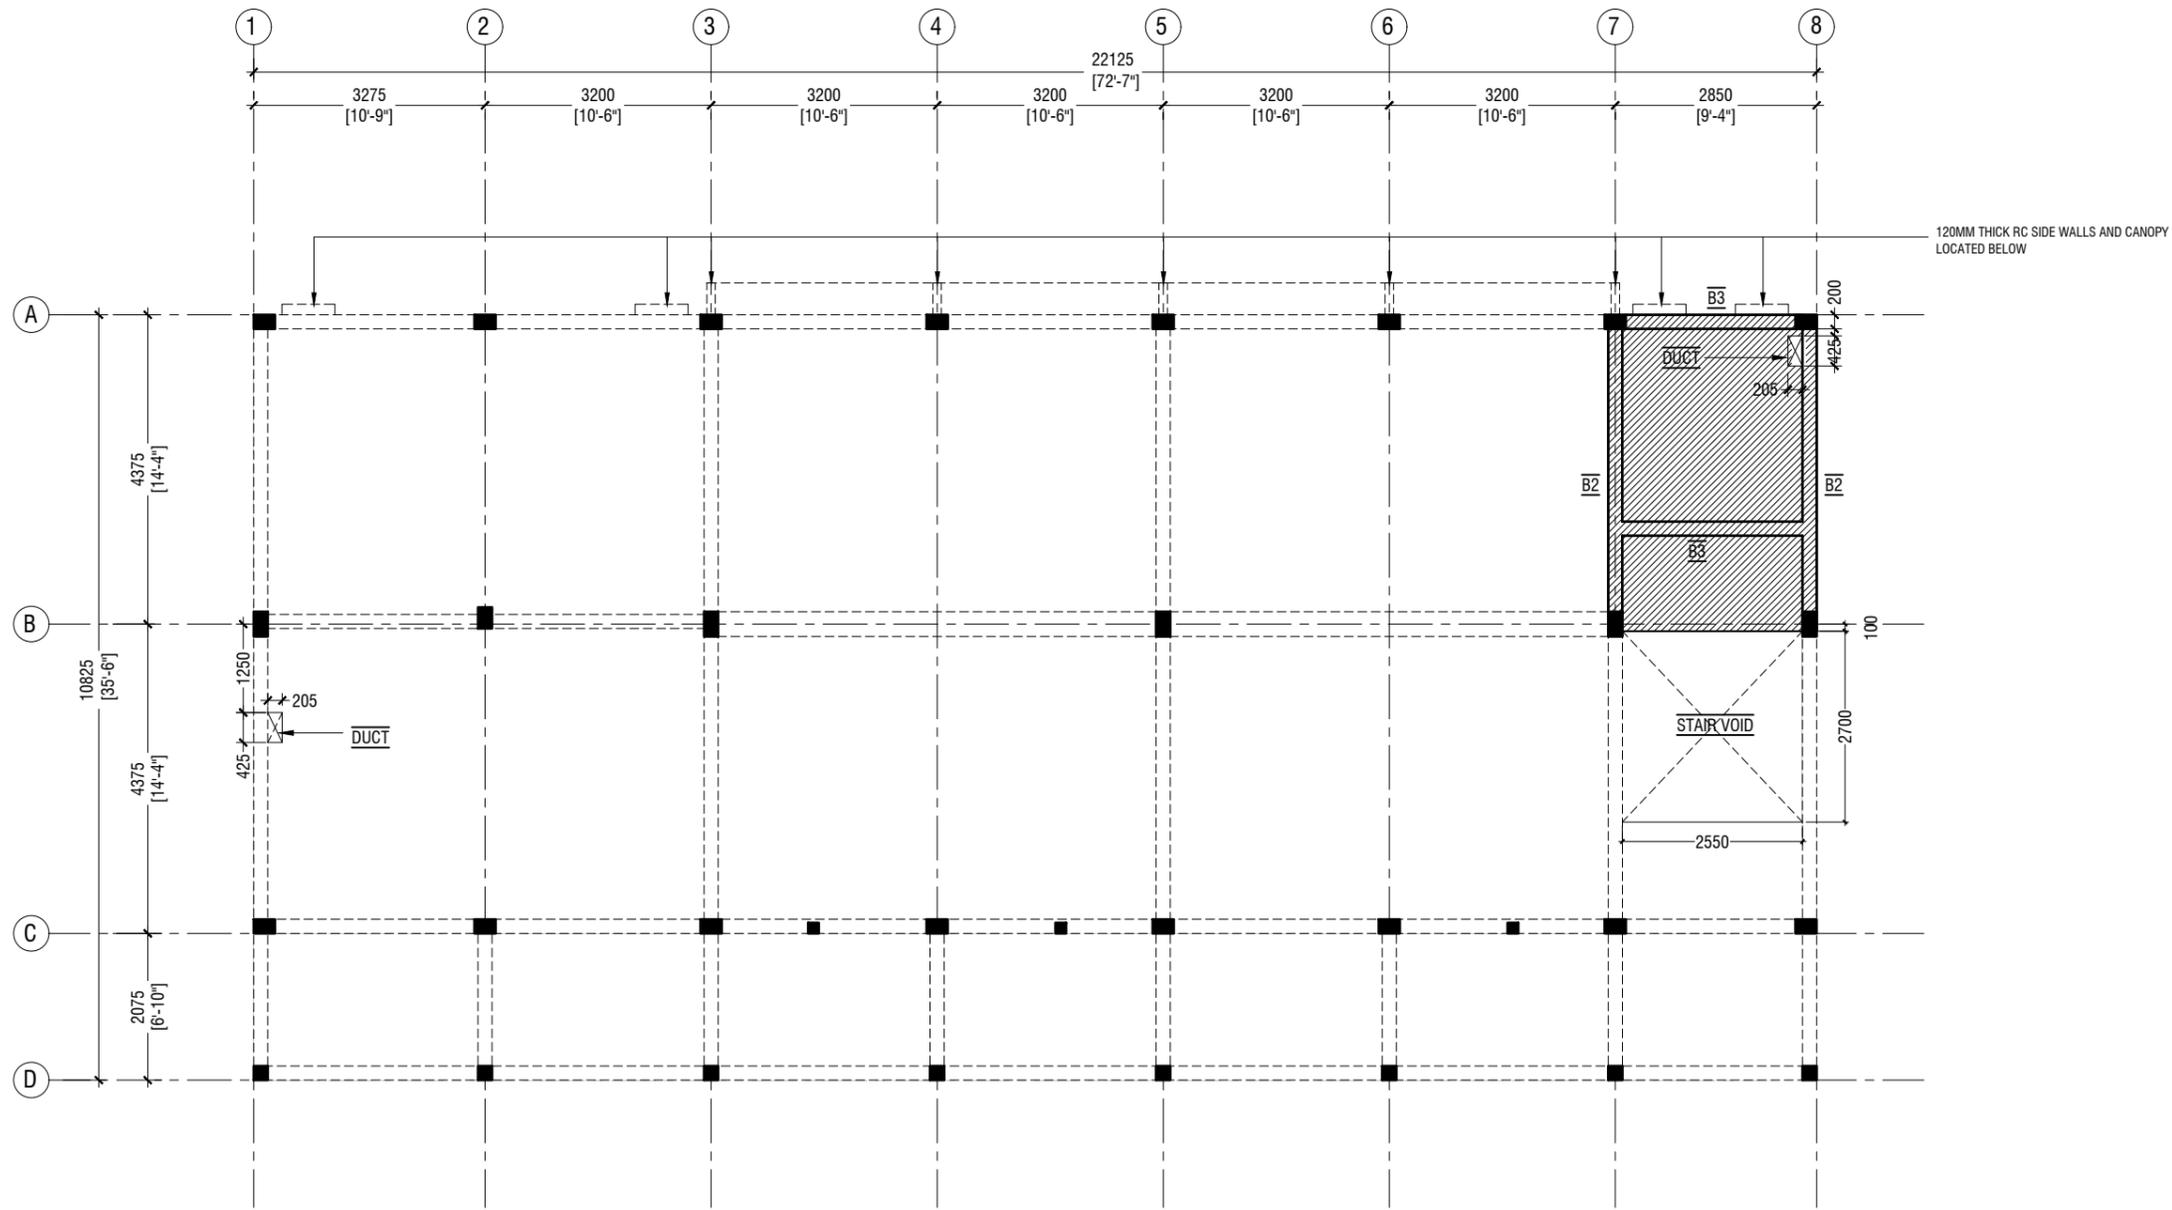SLAB THICKNESS: 150mm

REINFORCEMENT: T10@150C/C B/W (T&B)

ALL REINFORCEMENT TO BE DISCONTINUOUS OVER THE VOIDS

STORE / HALF LANDING FLOOR BEAM & SLAB REINFORCEMENT PLAN (+1865)

SCALE 1:100



Th.Omadhoo School Health Room, Science Lab & 2 Classroom Block (2 story)
Client: Ministry of Education

Rev no	Date

Project Number: RI/2020/006
Date: April 2021
Architect: Mariyam Irasha Shareef
Engineer: Mohamed Muthalib Waleed
Drawn by: Mariyam Leevan Jaleel
Services: Aishath Ahmed Interior




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Title: Store / Half Landing Beam & Slab Rein. Plan

Page: S-04/12



NOTE:

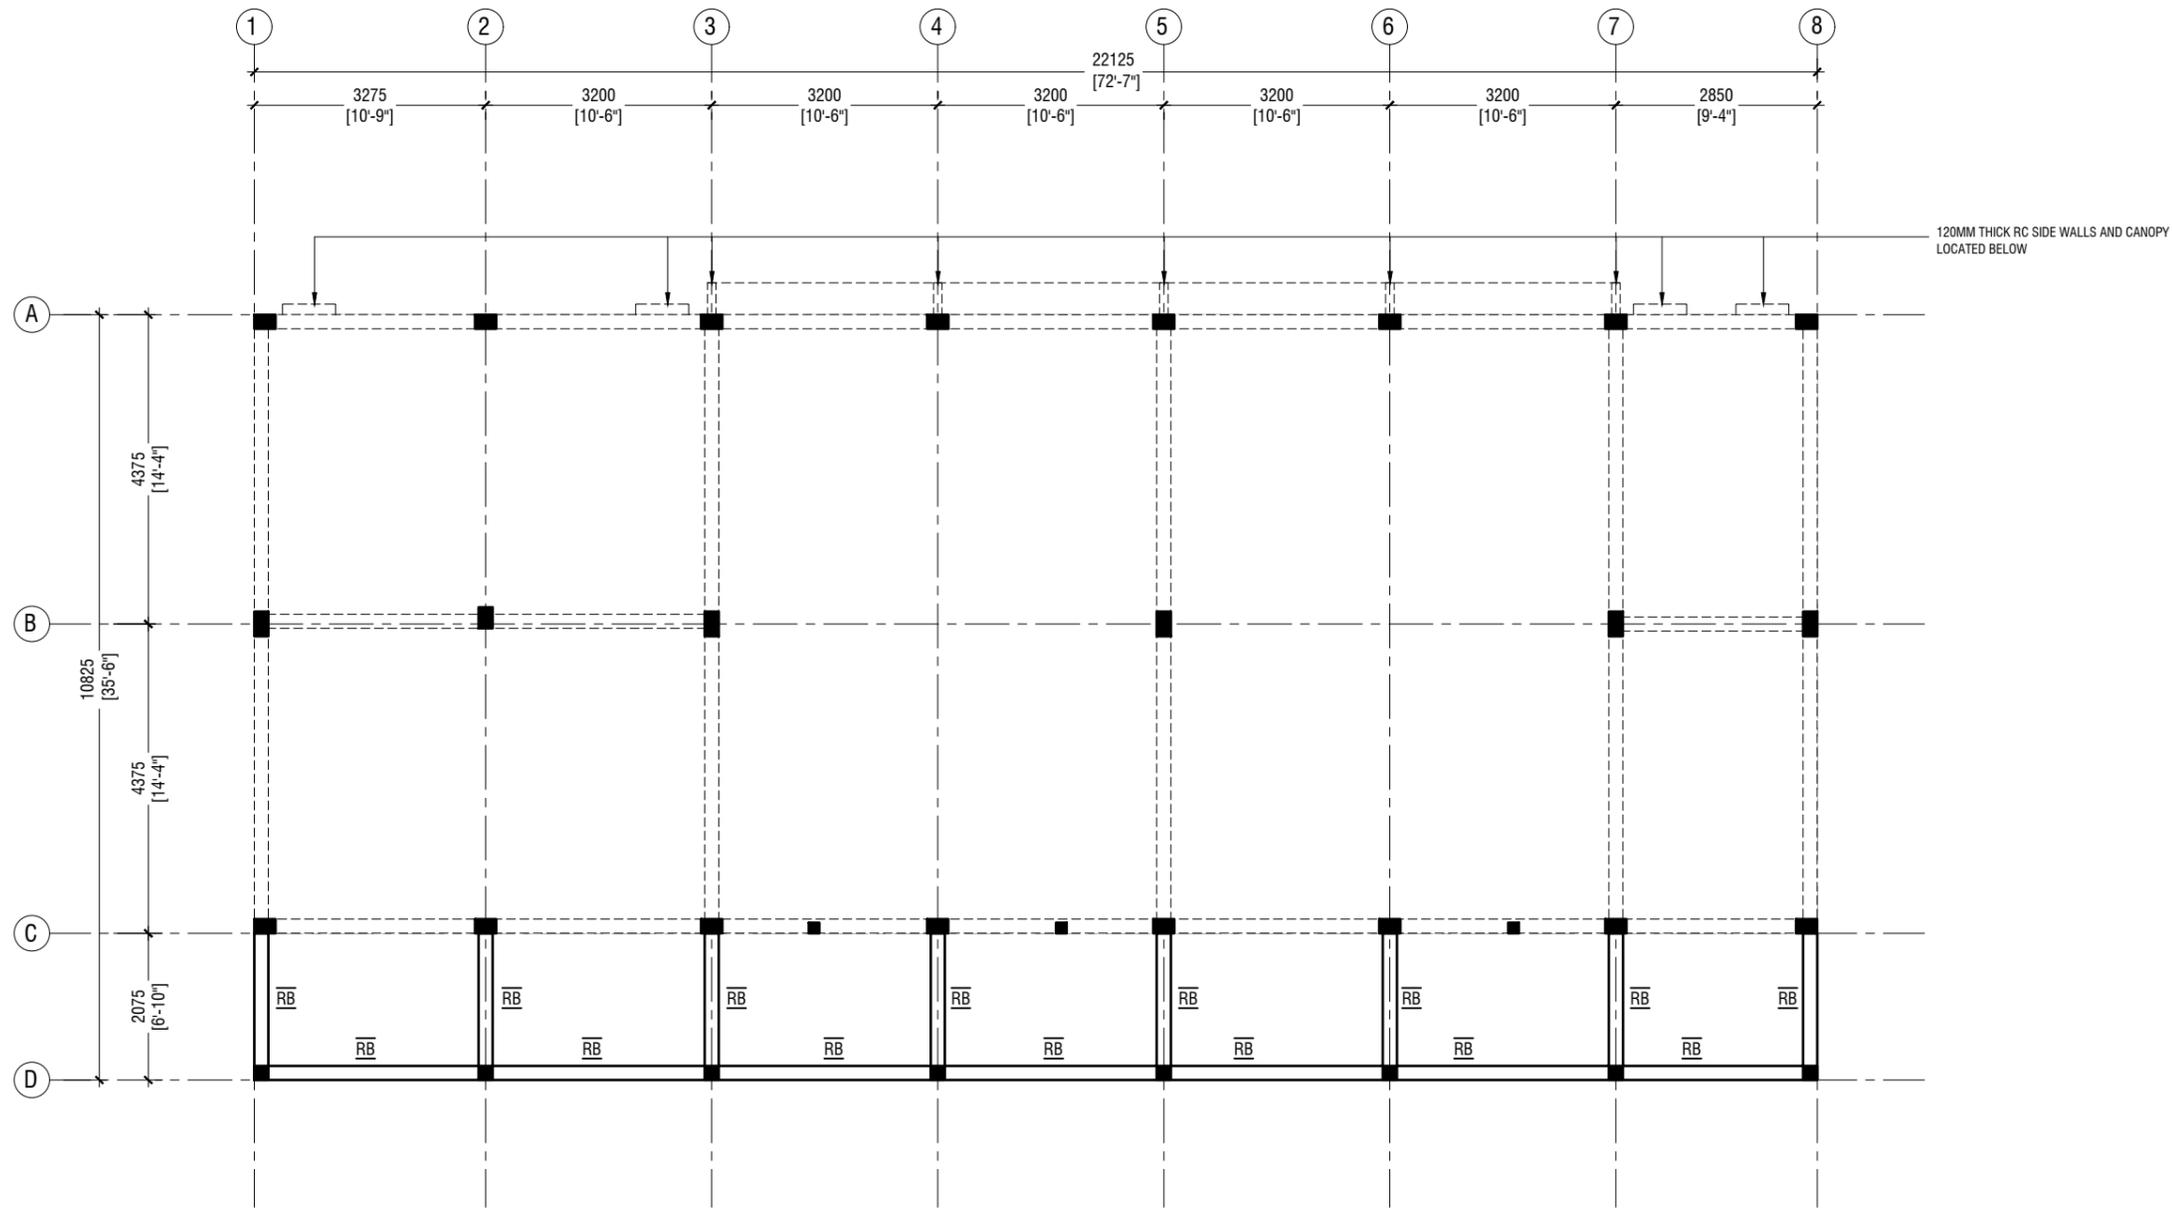BEAM SIZES
 RB : 200x300 mm
 COVER : 35mm

ROOF BEAM PLAN - 1 @6.15m FROM F.F.L

SCALE 1:100



Th.Omadhoo School Health Room, Science Lab & 2 Classroom Block (2 story)
 Client: Ministry of Education

Project Number: R/2020/006
 Date: April 2021
 Architect: Maryam Irasha Shareef
 Engineer: Mohamed Muthalib Walleed
 Drawn by: Maryam Leevan Jaleel
 Services: Aishath Ahmed Interior

Rev no	Date

Project Number: R/2020/006
 Date: April 2021

Architect: Maryam Irasha Shareef
 Engineer: Mohamed Muthalib Walleed
 Drawn by: Maryam Leevan Jaleel
 Services: Aishath Ahmed Interior

Rev no	Date



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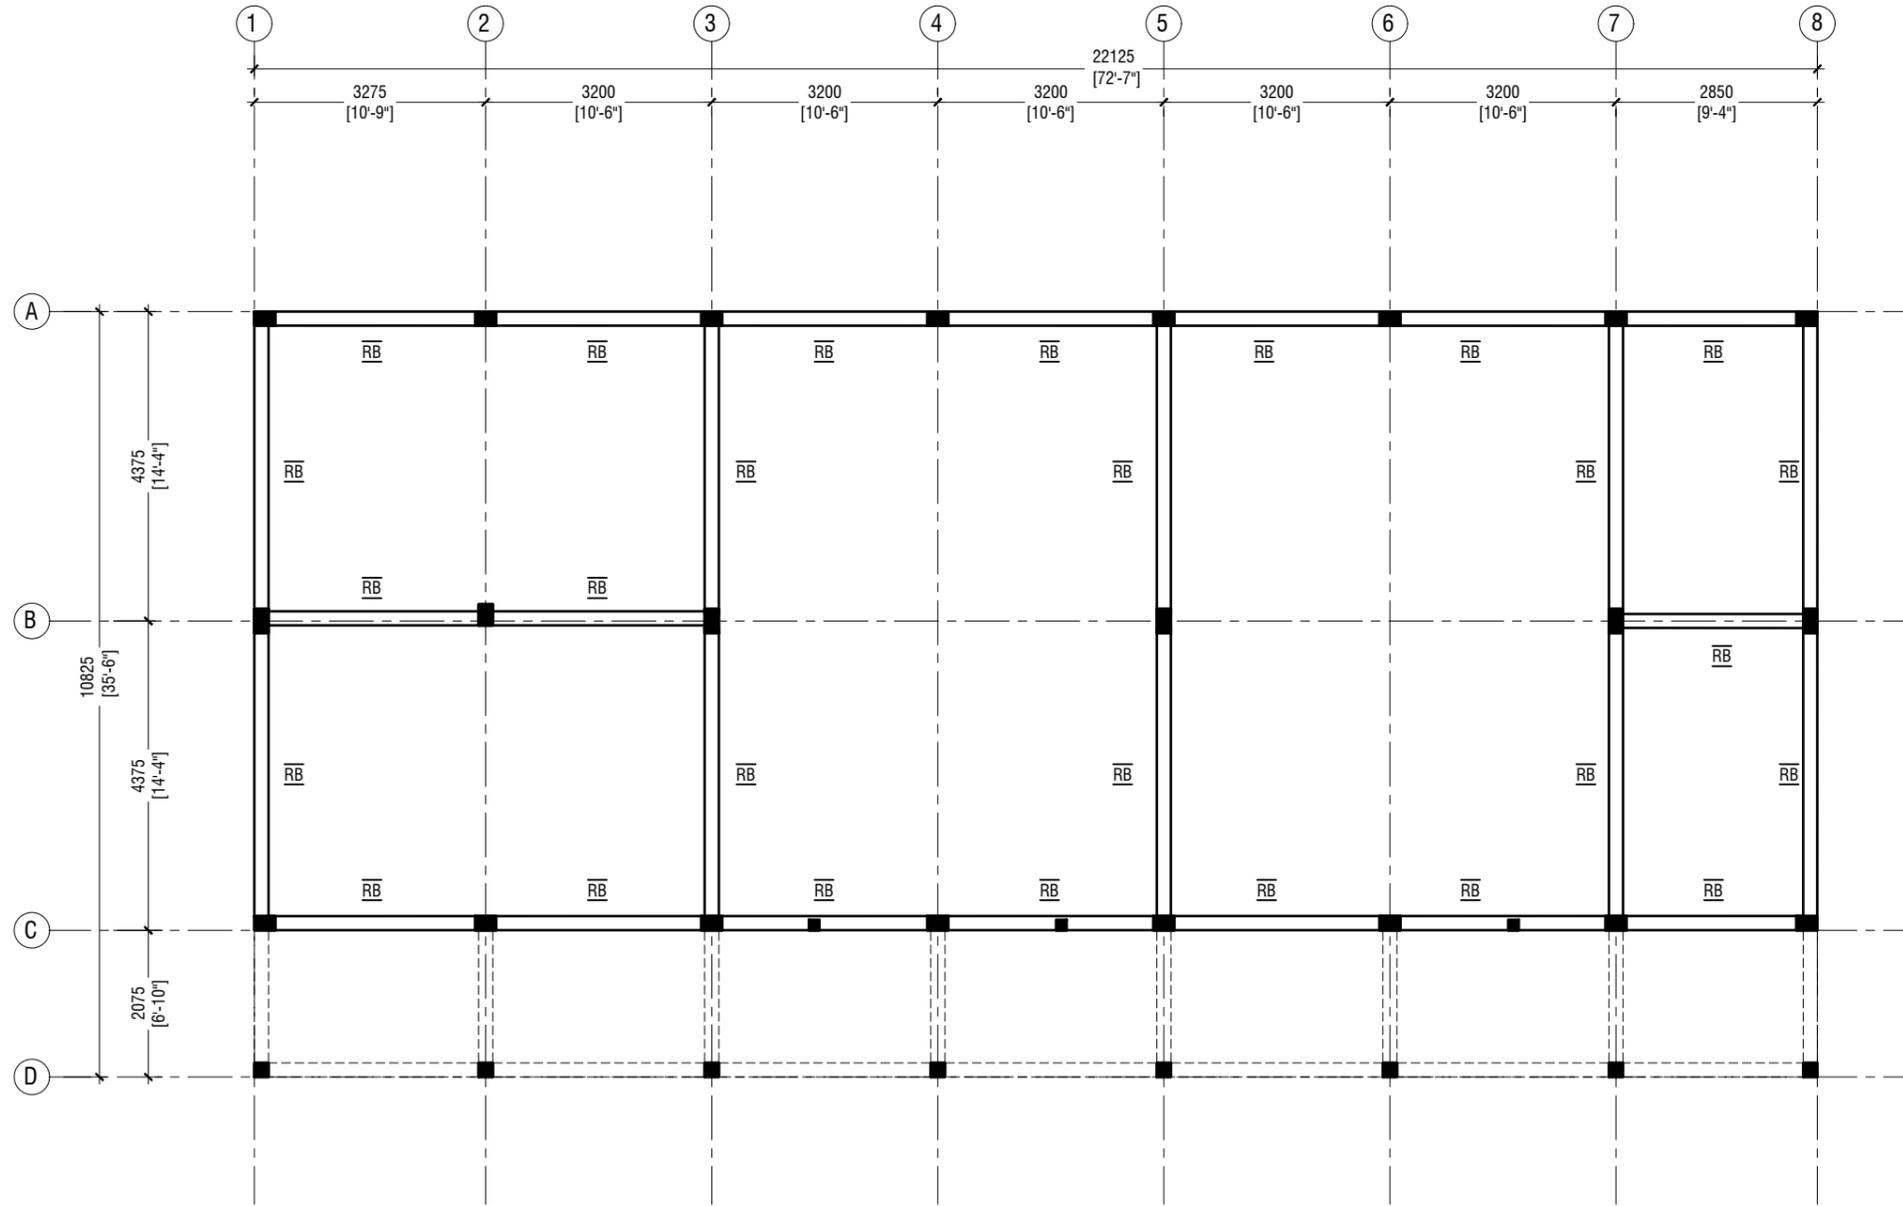
Title: Roof Beam Plan 1

Page: S-06/12

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ROOF BEAM PLAN - 2 @6.706 FROM F.F.L

SCALE 1:100



NOTE:

BEAM SIZES
 RB : 200x300 mm
 COVER : 35mm

Th.Omadhoo School Health Room, Science Lab & 2 Classroom Block (2 story)
Client: Ministry of Education

Rev no	Date
..
..
..
..

Project Number: RI/2020/006
 Date: April 2021
 Architect: Mariyam Irasha Shareef
 Engineer: Mohamed Muthalib Waleed
 Drawn by: Mariyam Leevan Jaleel
 Services: Aishath Ahmed
 Interior: ..




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Title: Roof Beam Plan 2

Page: S-07/12

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ROOF TRUSS & FRAMING PLAN

SCALE 1:100

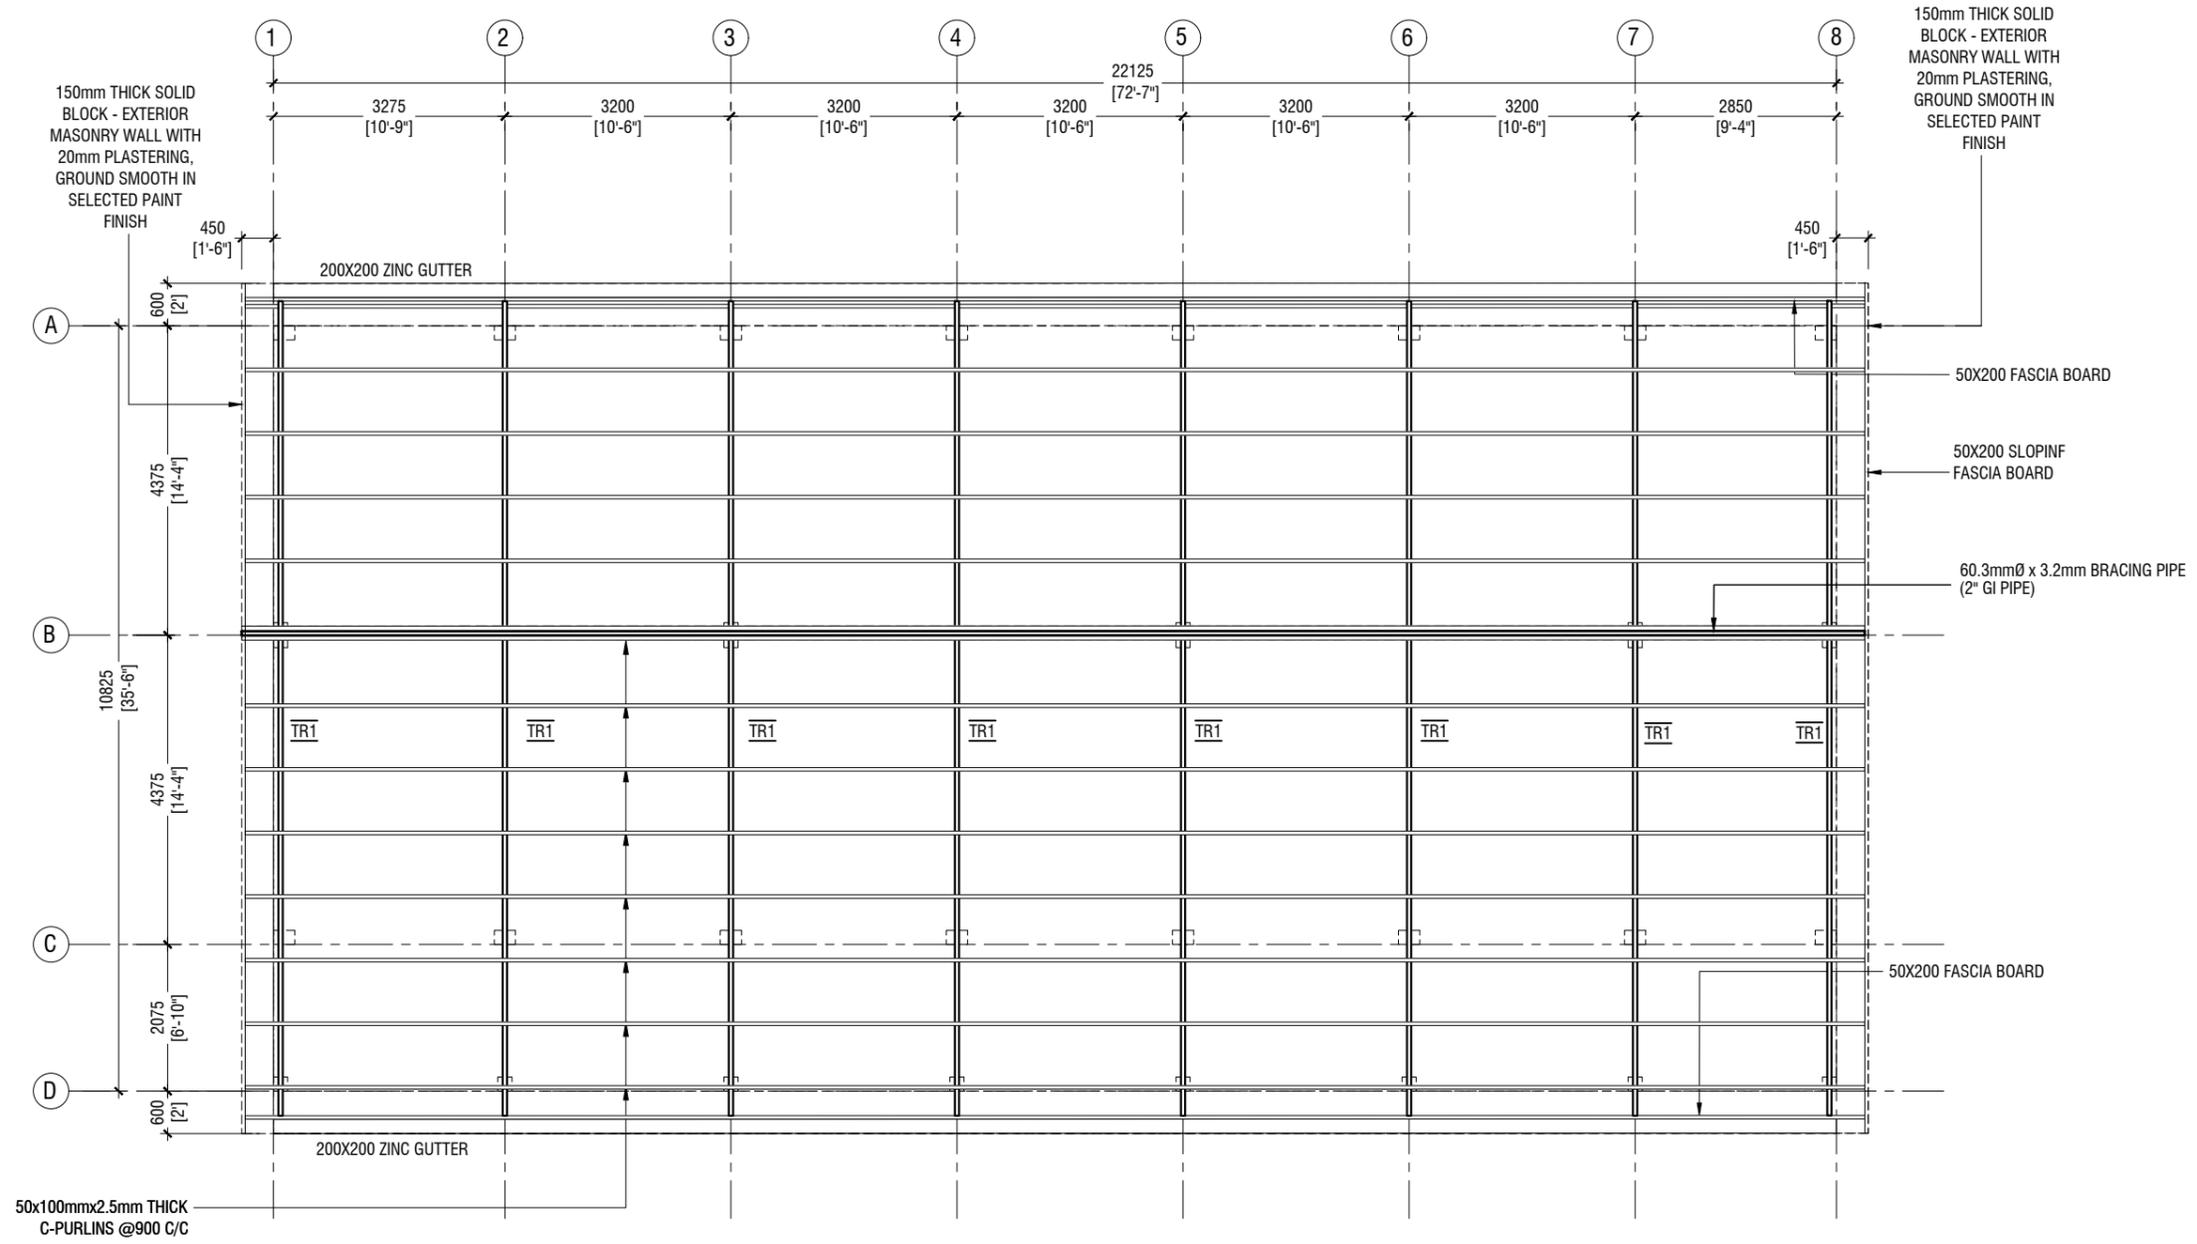

Th.Omadhoo School Health Room, Science Lab & 2 Classroom Block (2 story)
 Client: Ministry of Education

Rev no	Date
..	..
..	..
..	..
..	..

Project Number: RI/2020/006

Date: April 2021

Architect: Mariyam Irasha Shareef

Engineer: Mohamed Muthalib Waleed

Drawn by: Mariyam Leevan Jaleel

Services: Aishath Ahmed Interior



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Title: Roof Truss and Framing Plan

Page: S-08/12

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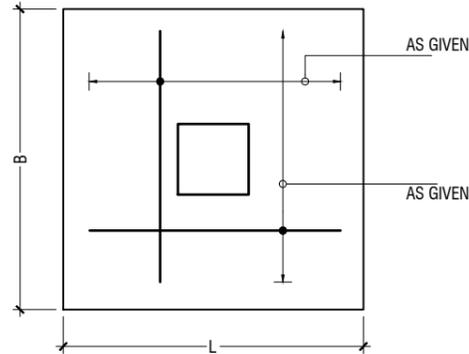
	DIMENSION (LXBXD)	REINFORCEMENT
F1	1800 x 1800 x 300	T16@150 C/C B/W (B)
F2	1600 x 1600 x 300	T12@150 C/C B/W (B)
F3	1400 x 1400 x 300	T12@150 C/C B/W (B)
F4	1200 x 1200 x 300	T12@150 C/C B/W (B)
F5	1100 x 1100 x 300	T12@150 C/C B/W (B)
F6	750 x 750 x 300	T12@150 C/C B/W (B)

FOUNDATION DEPTH = 1200mm


NOTE:-
COVER TO FOUNDATION = 50mm
COVER TO COLUMNS = 40mm
COVER TO BEAMS = 35mm
LAPS = Ø OF BAR x 45
BEAMS @END SUPPORT = Ø OF BAR x 12

CONCRETE GRADE = M25


FOUNDATION PADS



PLAN

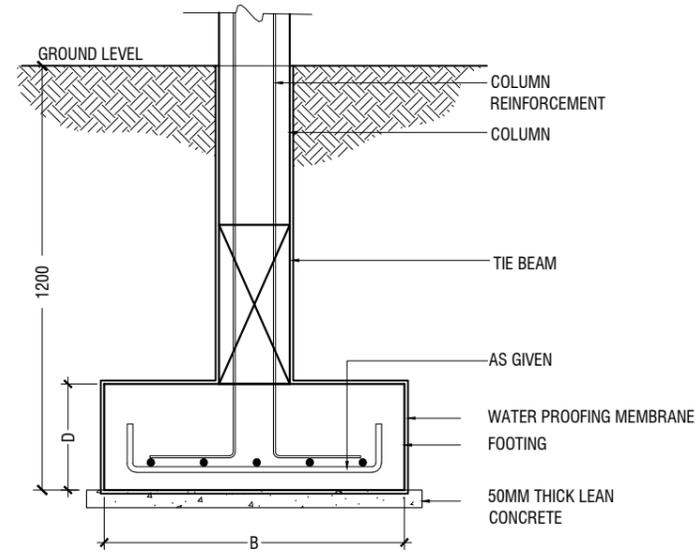

TYPICAL FOOTING SECTION

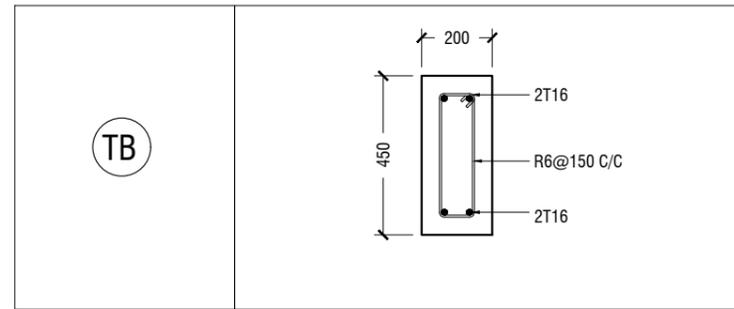

FOUNDATION DETAILS

	GROUND & 1ST FLOOR
C1	
C2	
C3	
C4	
SC	

COLUMN DETAIL

STRUCTURAL DETAILS - 1

SCALE 1:20



Th.Omadhoo School Health Room, Science Lab & 2 Classroom Block (2 story)
Client: Ministry of Education

Rev no	Date
..	..
..	..
..	..

Project Number: RI/2020/006
Date: April 2021
Architect: Mariyam Irasha Shareef
Engineer: Mohamed Muthalib Waleed
Drawn by: Mariyam Leevan Jaleel
Services: Aishath Ahmed
Interior: ..



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Title: Structural Details - 1

Page: S-10/12

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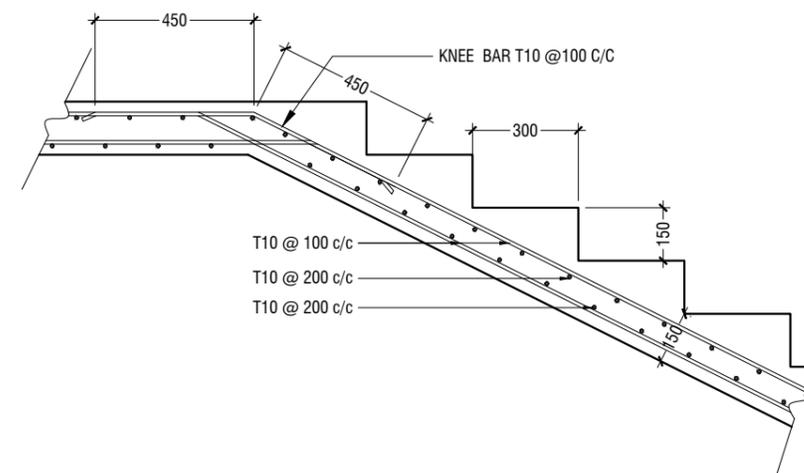
	MIDSPAN	SUPPORT
B1		
B2		
B3		
B4		
RB		
HB		

BEAM DETAIL

NOTE:
PROVIDE 25MM SPACER BAR @ 2000 C/C BETWEEN TWO LAYERS OF BEAM REINFORCEMENT


LT1	
LT2	

LINTELS OVER ALL DOORS, WINDOWS
(THAT DOES NOT RISE TO ROOF BEAM LEVEL)
LT2 FOR WINDOW (W2) ONLY



MAIN STAIRCASE REINFORCEMENT DETAIL

STRUCTURAL DETAILS - 2

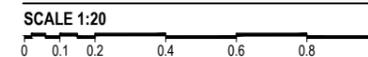

Th.Omadhoo School Health Room, Science Lab & 2 Classroom Block (2 story)
Client: Ministry of Education

Project Number: RI/2020/006	Rev no	Date
Date: April 2021		
Architect: Maryam Irasha Shareef		
Engineer: Mohamed Muhtalib Waleed		
Drawn by: Maryam Leevan Jaleel		
Services: Aishath Ahmed		
Interior: .		




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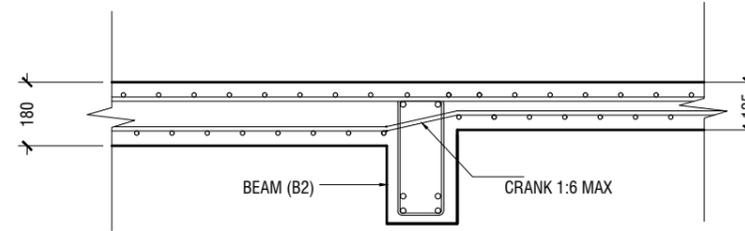
Title: Structural Details - 2

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B1 TO B2 CONNECTION DETAIL



SLAB THICKNESS REDUCTION DETAIL

STRUCTURAL DETAILS - 3

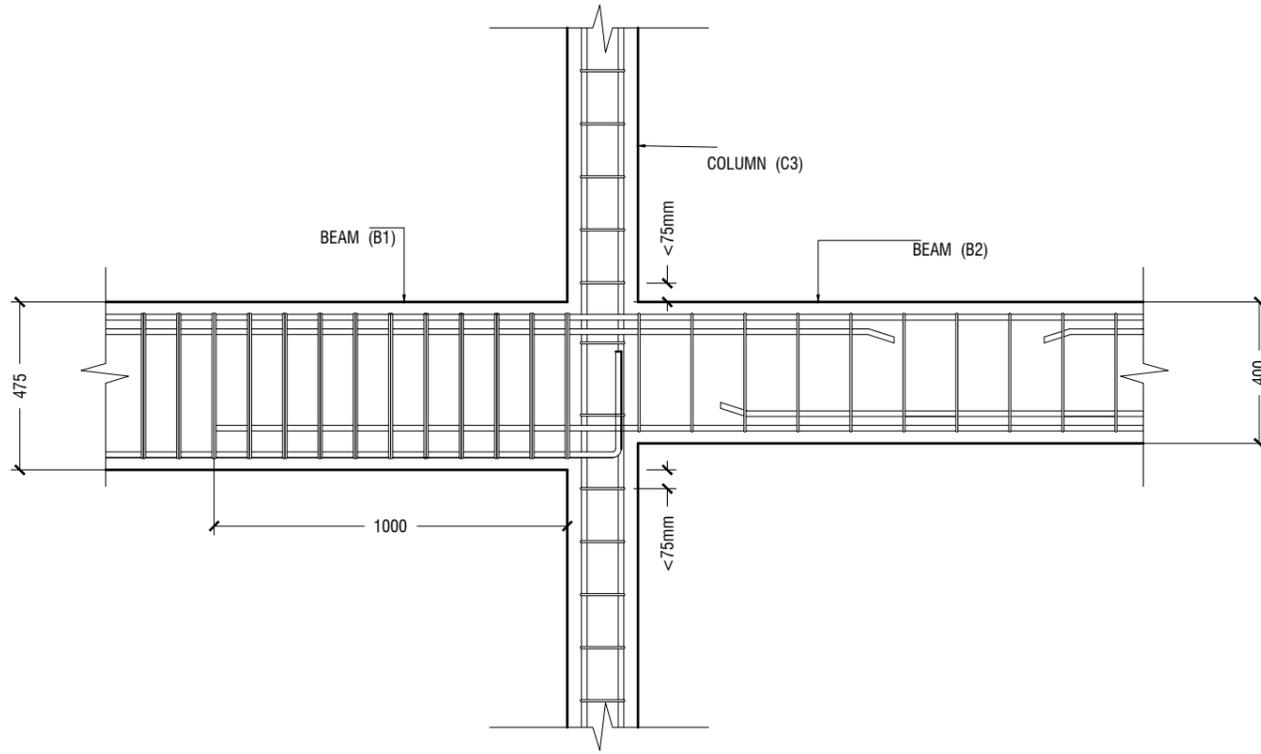SCALE 1:20



Th.Omadhoo School Health Room, Science Lab & 2 Classroom Block (2 story)
Client: Ministry of Education

Project Number: RI/2020/006	Rev no	Date
Date: April 2021	--	-----
Architect: Maryam Irasha Shareef	--	-----
Engineer: Mohamed Muththailib Waleed	--	-----
Drawn by: Maryam Leevan Jaleel	--	-----
Services: Aishath Ahmed	--	-----
Interior: .	--	-----



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Title: Structural Details - 3

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