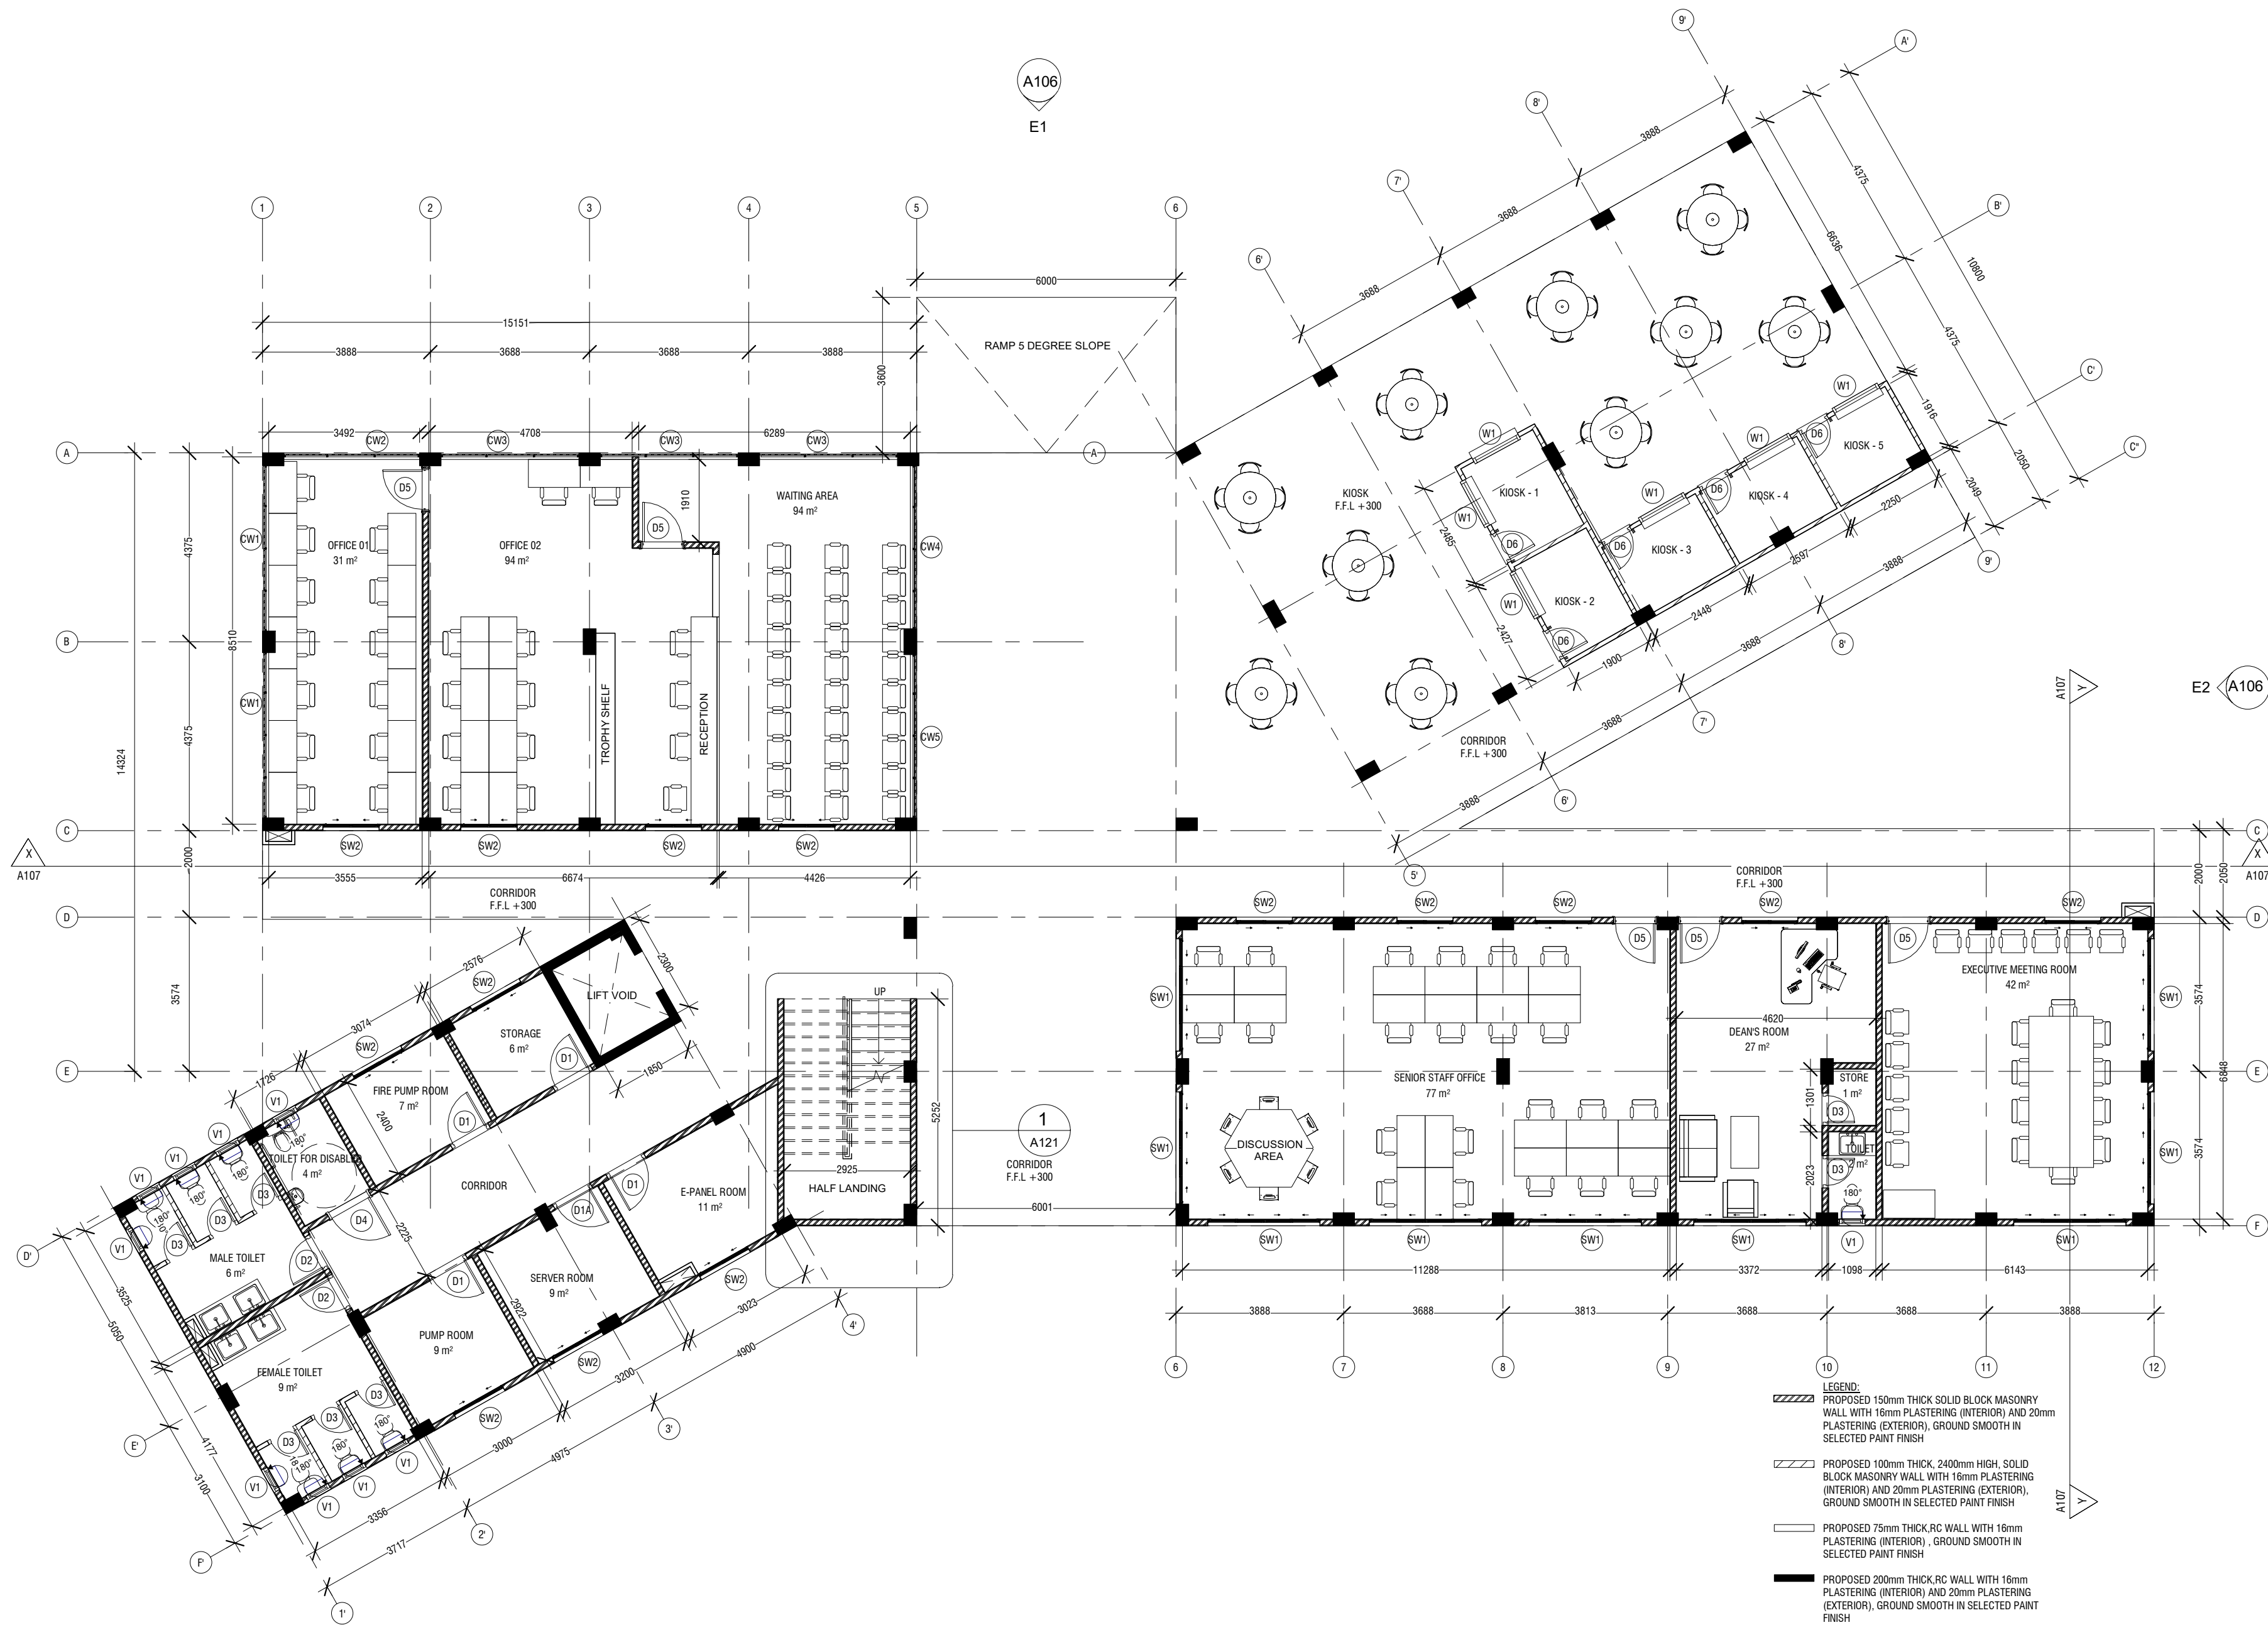


Preparation of Drawings for Gn. Fuvahmulah Campus  
(Main Block)  
The Maldives National University

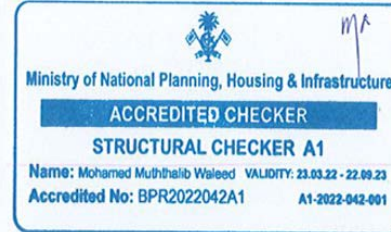


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*3rd floor, H.Azum, Ameenemagu, Male'*





1 GROUND FLOOR LEVEL  
1 : 100



#### GENERAL NOTES

#### REVISIONS

REV. NO.	REV. DATE	REV. DESCRIPTION	REV. BY	CHK. BY

#### CONSULTANT

LEAD CONSULTANT

#### LANDSCAPE DESIGN

#### REGISTERED LOCAL CONSULTANT



RYAN PRIVATE LIMITED

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CONSULTANT PROJECT NO. R21323MMNU

ARCHITECT Mariyam Irasha Shareef

CIVIL ENGINEER Zainal Abidheen

MEP ENGINEER -

INT. DESIGNER -

INFRA. DESIGNER -

DRAWN BY Mariyam Leevan Jaleel

CHECKED BY Zunabath Abdul Majid

APPROVED BY -

PROJECT NAME

**Preparation of Drawings  
for Gn. Fuvahmulah  
Campus (Main Block)**

CLIENT The Maldives National University

DEVELOPER -

ATOLL Gnaviyani Atoll (GN.)

ISLAND Gn. Fuvahmulah

LAGOON (GPS COORDINATES)

ISSUED FOR

BUILDING NAME

**Gn. Fuvahmulah Campus**

BUILDING/STRUCTURE NO.

ISSUE DATE

02/22/23

DRAWING TITLES

**GROUND FLOOR PLAN**

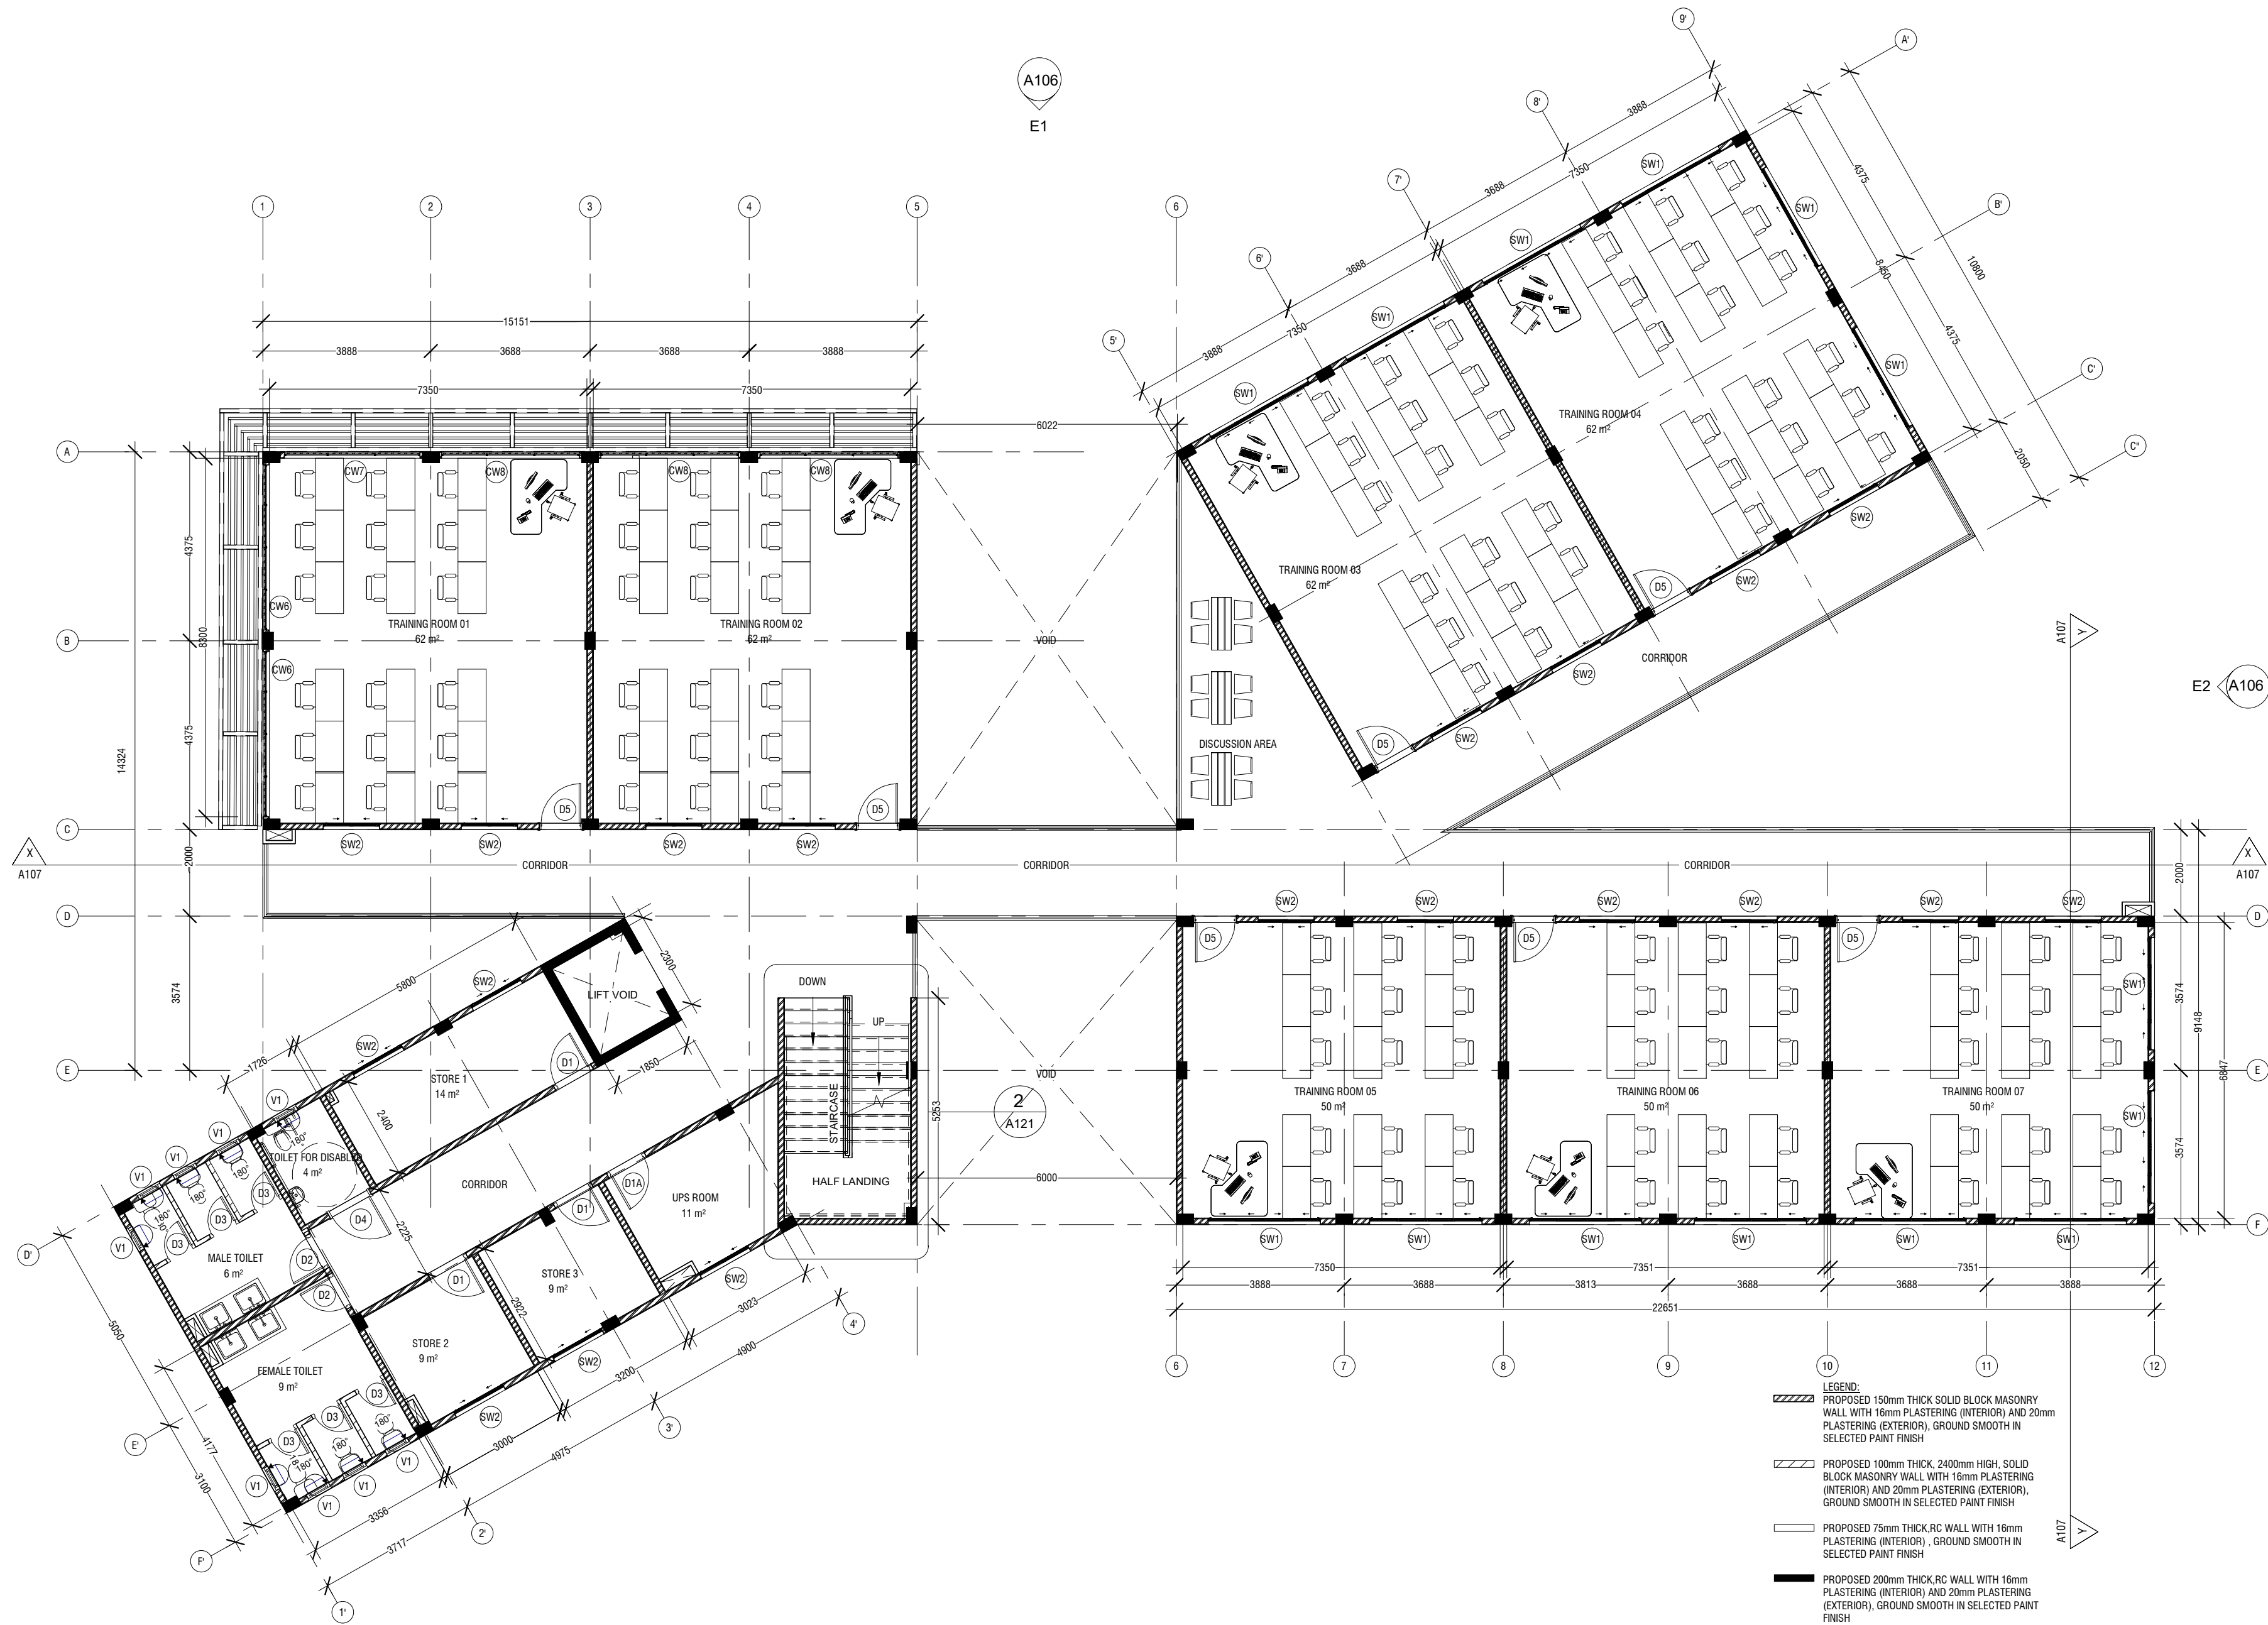
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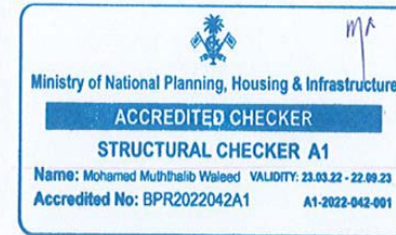
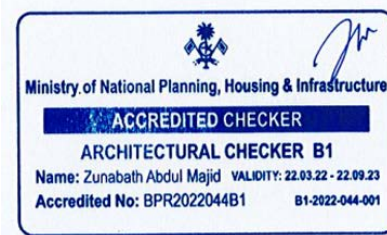
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1 FIRST FLOOR PLAN  
1 : 100



#### GENERAL NOTES

#### REVISIONS

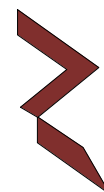
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#### CONSULTANT

LEAD CONSULTANT

#### LANDSCAPE DESIGN

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CONSULTANT PROJECT NO. R21323MNU

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CIVIL ENGINEER Zainal Abiddeen

MEP ENGINEER -

INT. DESIGNER -

INFRA. DESIGNER -

DRAWN BY Mariyam Leevan Jaleel

CHECKED BY Zunabath Abdul Majid

APPROVED BY -

PROJECT NAME

**Preparation of Drawings  
for Gn. Fuvahmulah  
Campus (Main Block)**

CLIENT The Maldives National University

DEVELOPER -

ATOLL Gnaviyani Atoll (GN.)

ISLAND Gn. Fuvahmulah

LAGOON (GPS COORDINATES)

ISSUED FOR

BUILDING NAME

**Gn. Fuvahmulah Campus**

BUILDING/STRUCTURE NO.

ISSUE DATE

02/22/23

DRAWING TITLES

**FIRST FLOOR PLAN**

SHEET SIZE A2 SCALE 1 : 100

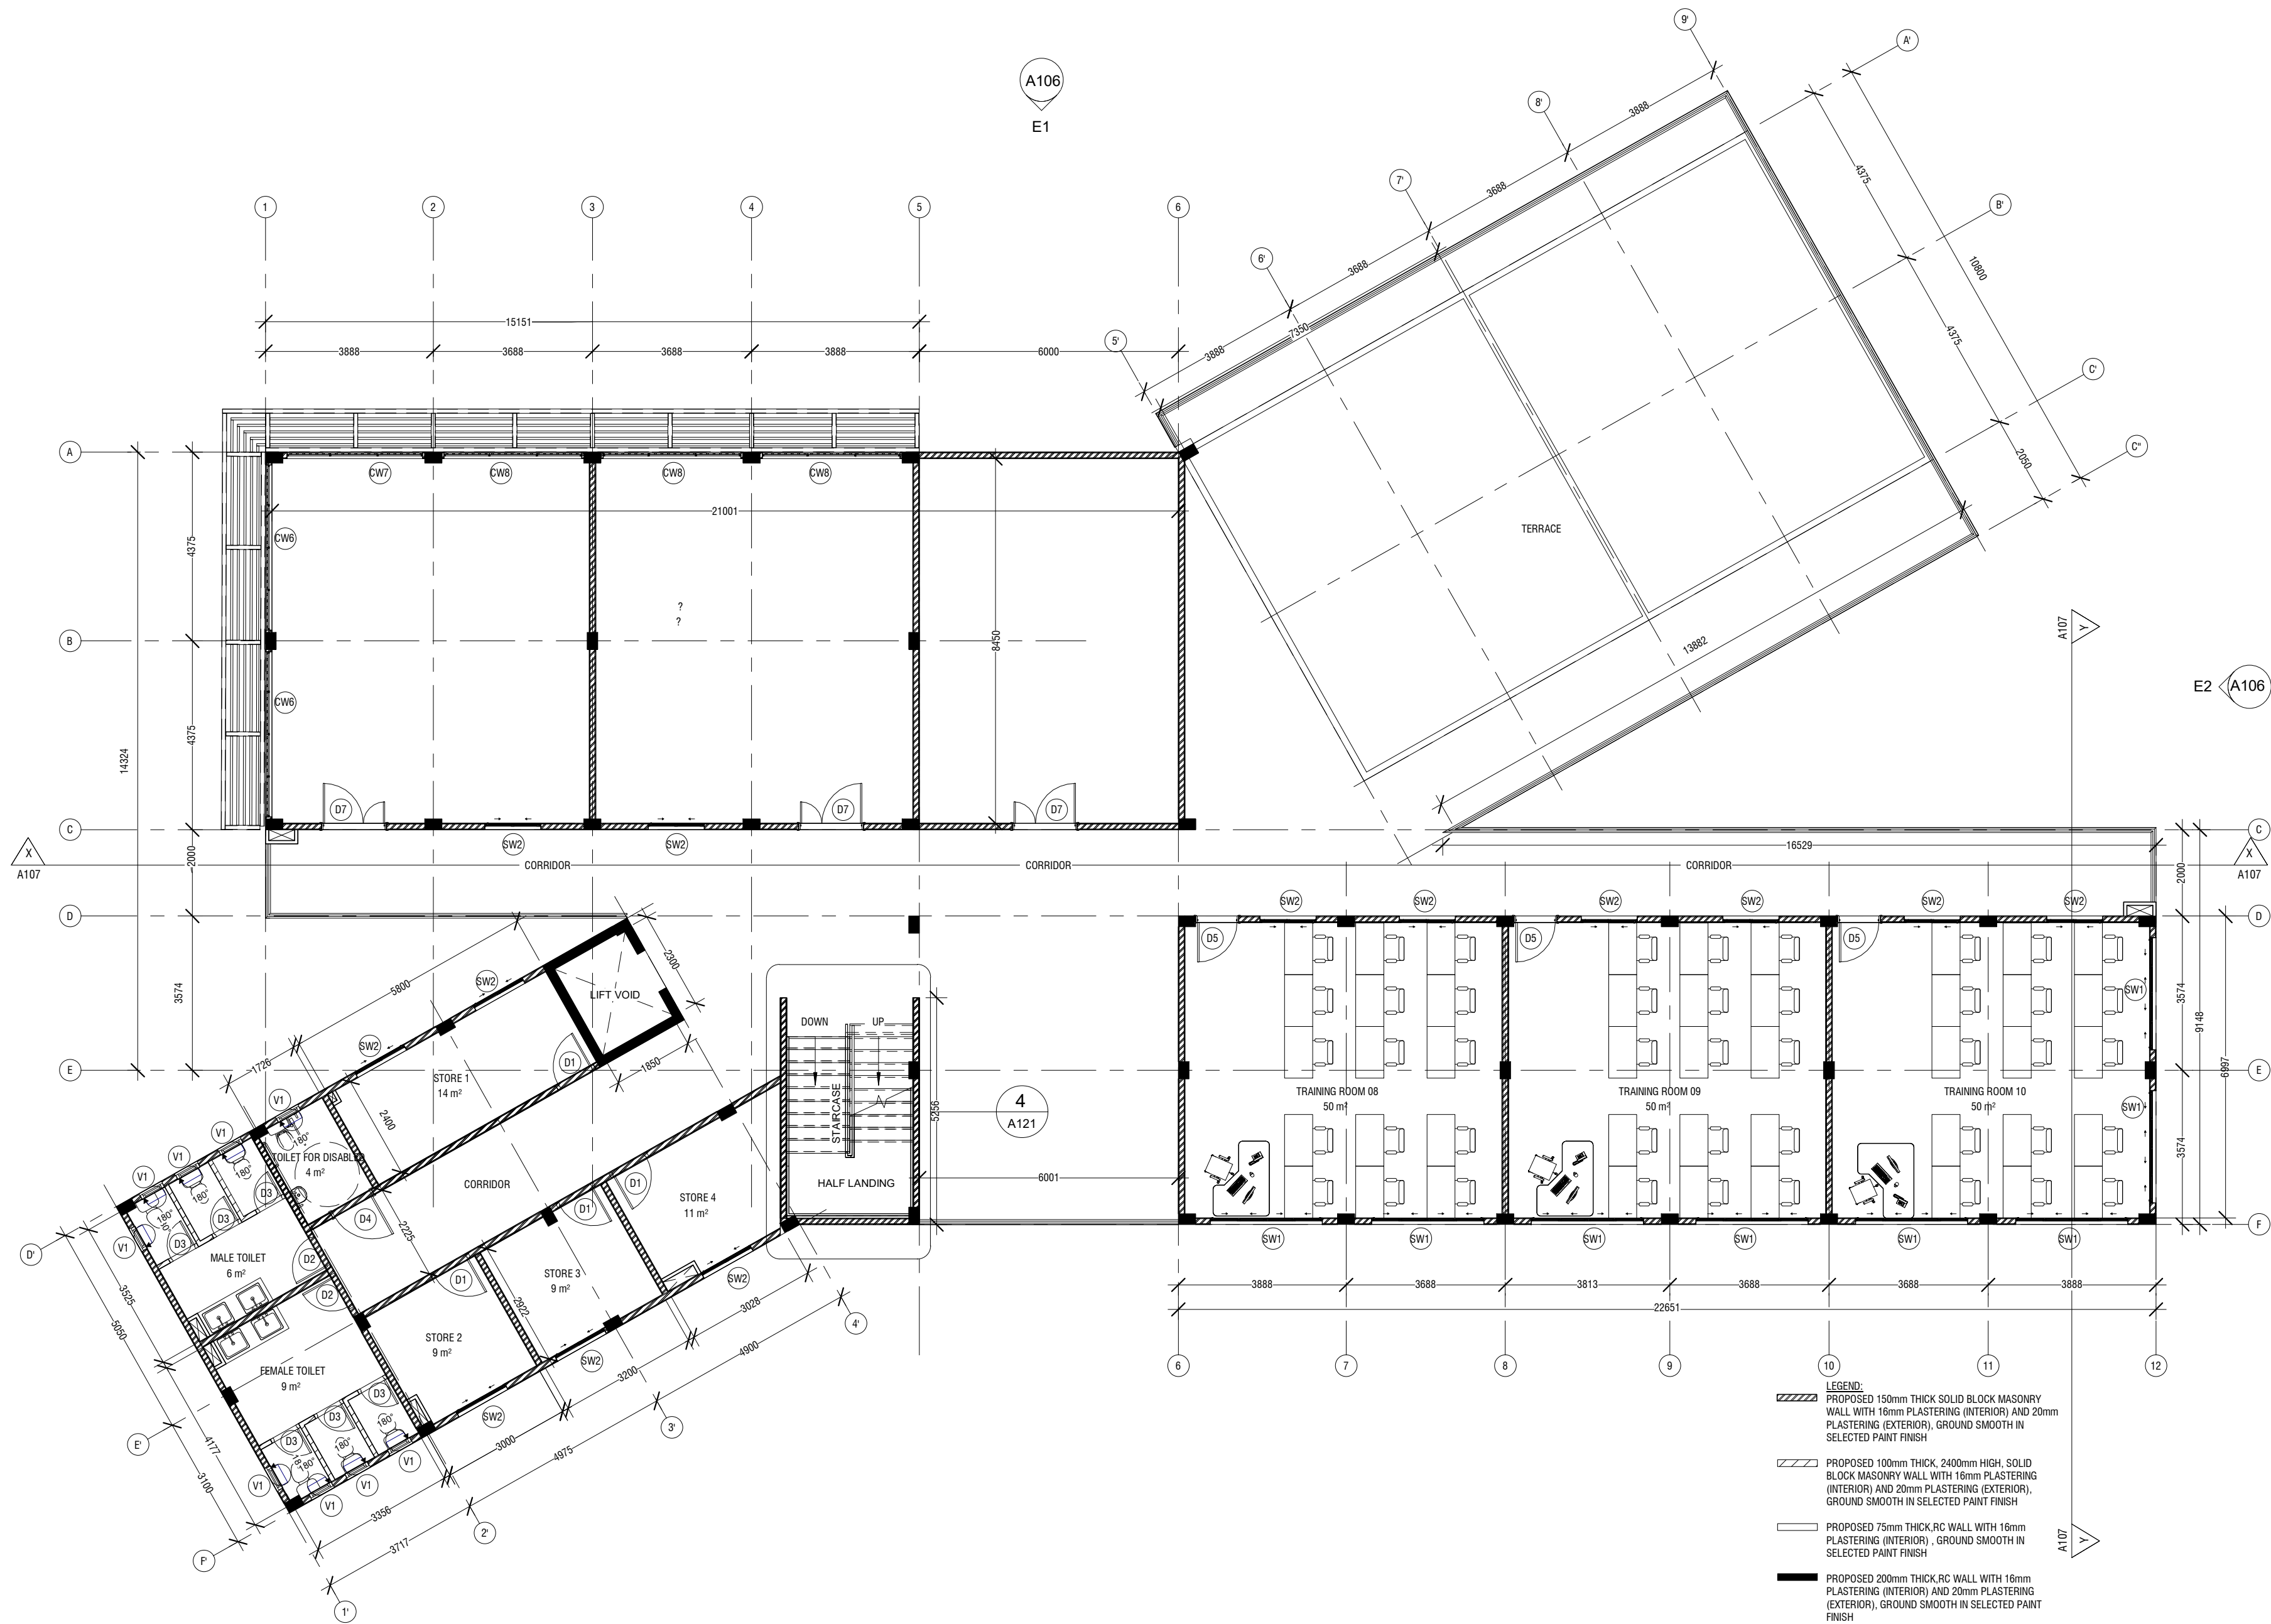
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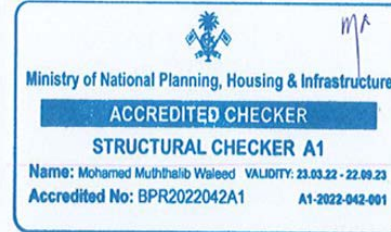
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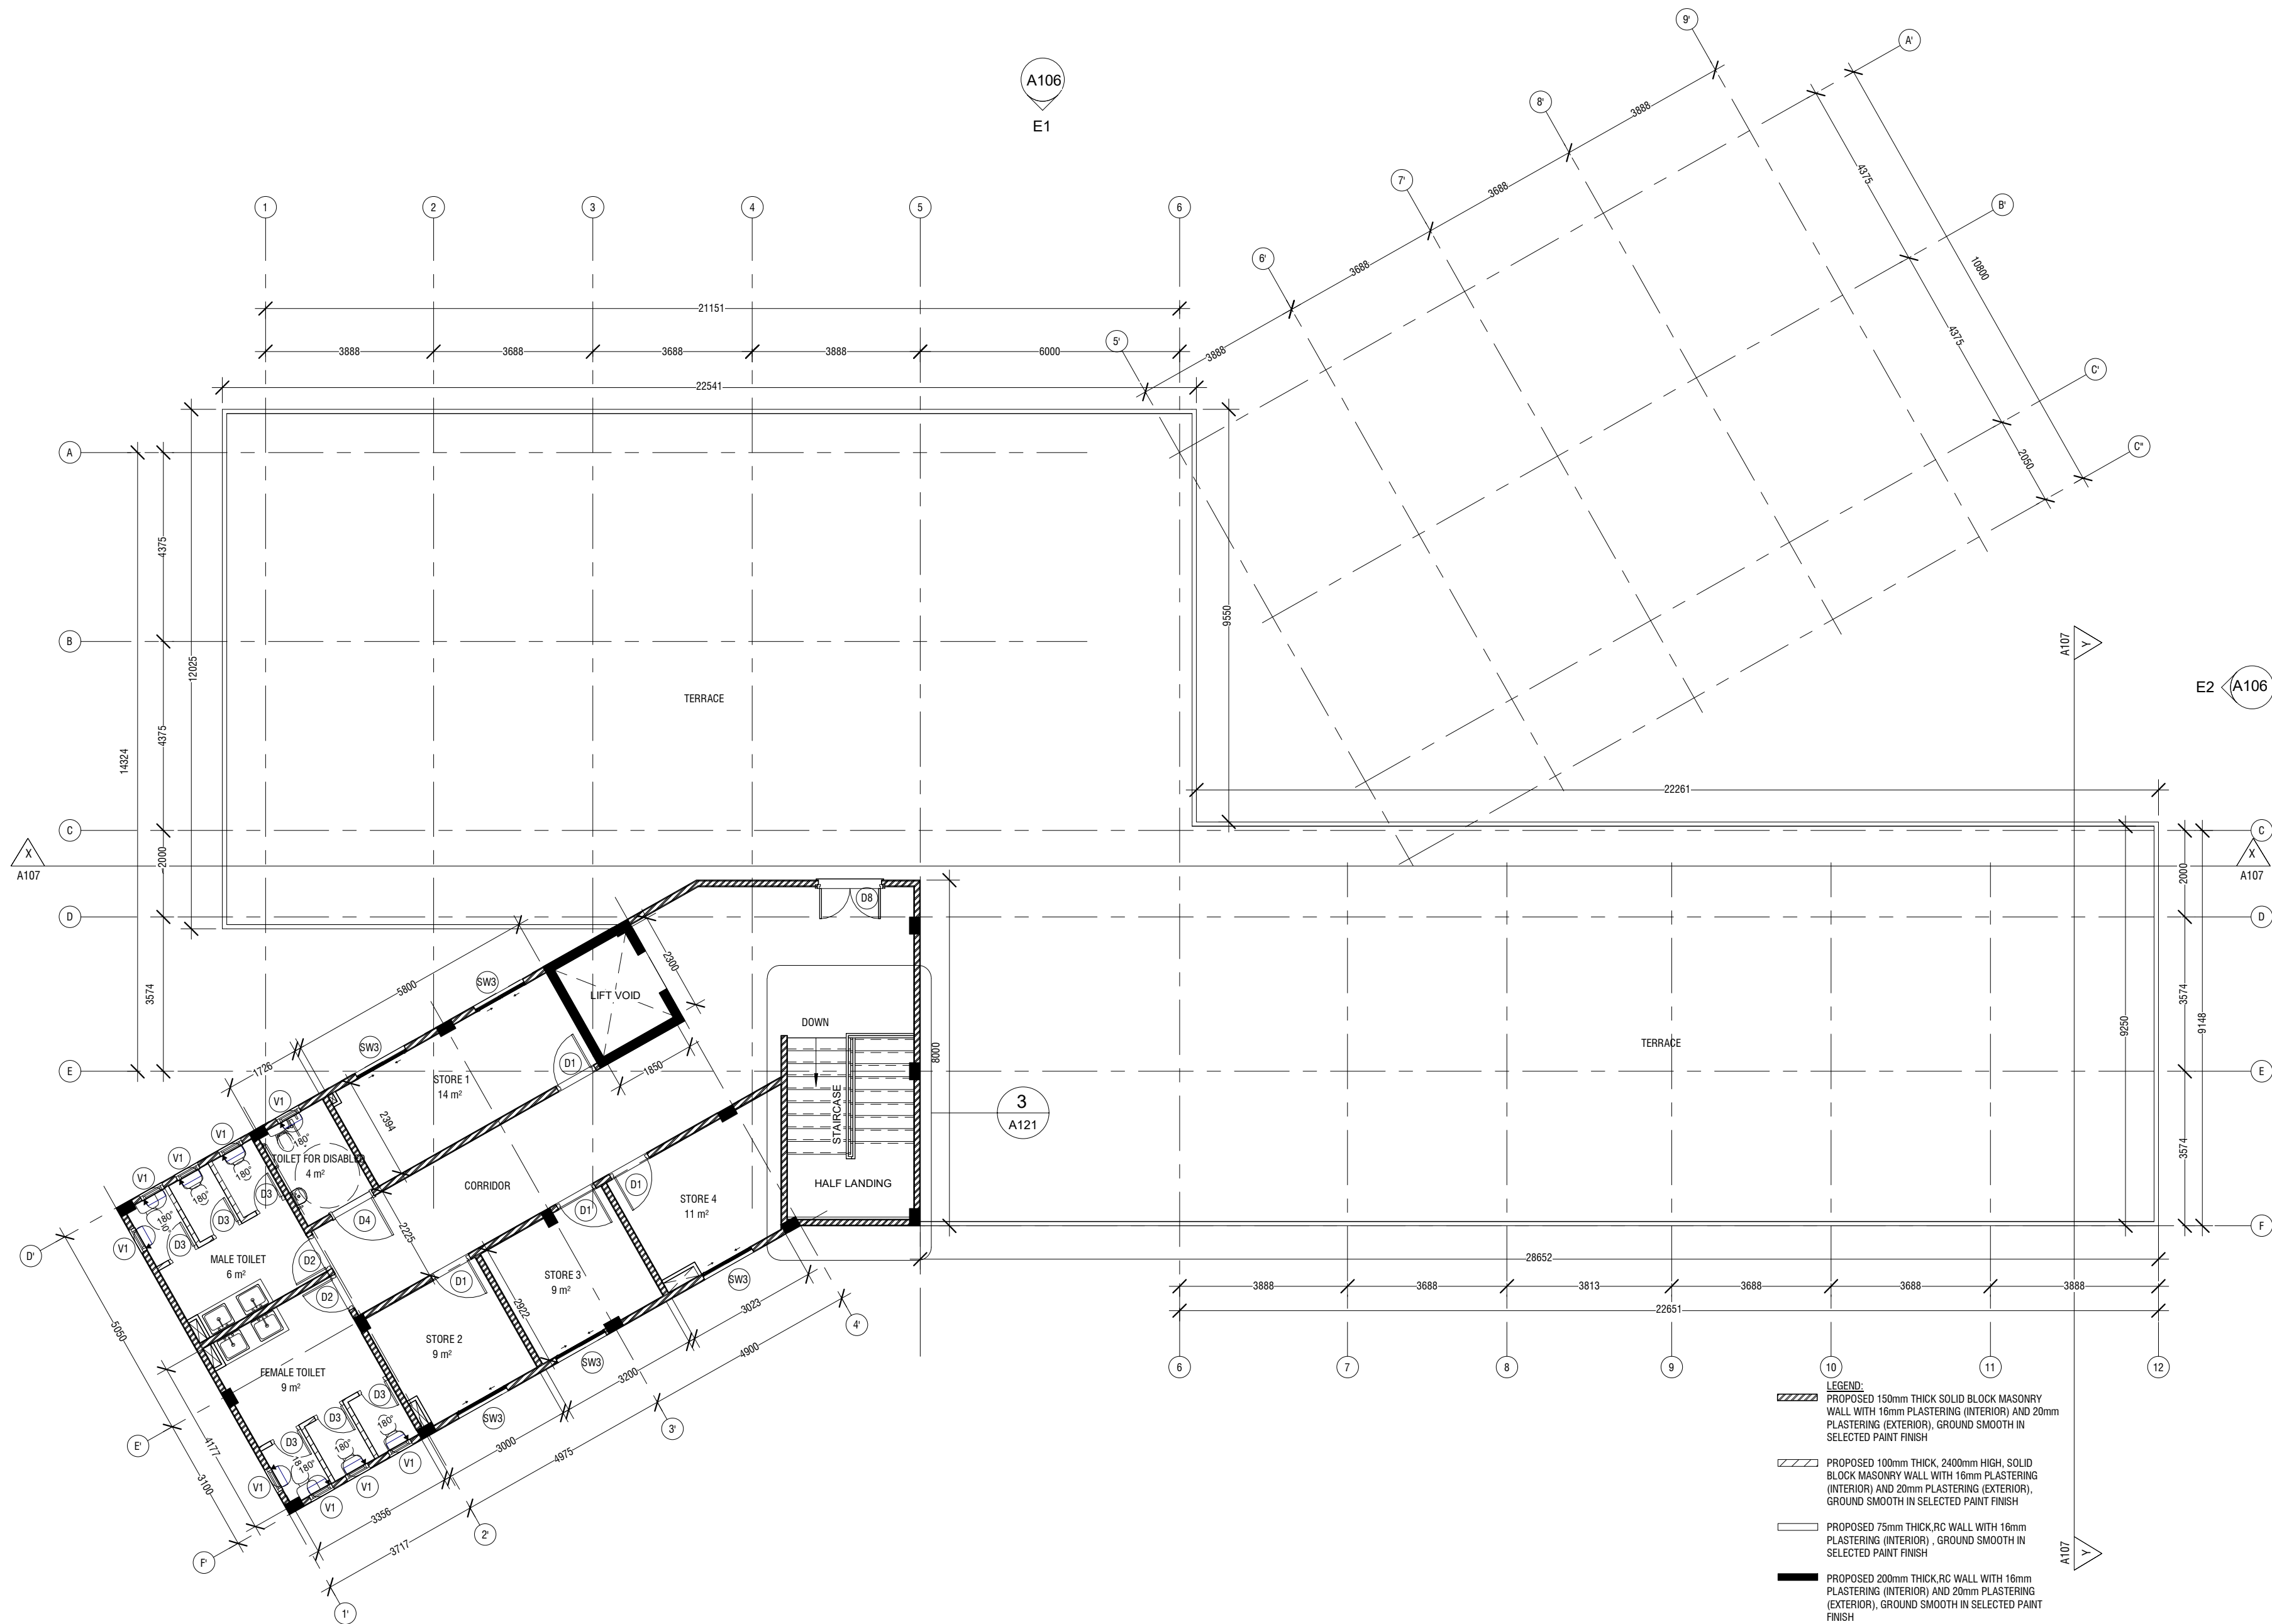


1 SECOND FLOOR PLAN  
1 : 100



GENERAL NOTES				
REVISIONS				
REV.NO	REV DATE	REV.DESCRPTION	REV BY	CHK BY





① TERRACE FLOOR PLAN  
1 : 100

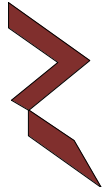


GENERAL NOTES

REVISIONS

REV.NO	REV DATE	REV DESCRIPTION	REV BY	CHK BY

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CONSULTANT PROJECT NO. **R21323MMNU**

ARCHITECT	<b>Mariyam Irasha Shareef</b>
CIVIL ENGINEER	<b>Zainal Abidheen</b>
MEP ENGINEER	-
INT. DESIGNER	-
INFRA. DESIGNER	-
DRAWN BY	<b>Mariyam Leevan Jaleel</b>
CHECKED BY	<b>Zunabath Abdul Majid</b>
APPROVED BY	-

PROJECT NAME  
**Preparation of Drawings for Gn. Fuvahmulah Campus (Main Block)**

CLIENT	<b>The Maldives National University</b>
DEVELOPER	-
ATOLL	<b>Gnaviyani Atoll (GN.)</b>
ISLAND	<b>Gn. Fuvahmulah</b>
LAGOON (GPS COORDINATES)	
ISSUED FOR	

BUILDING NAME  
**Gn. Fuvahmulah Campus**

BUILDING/STRUCTURE NO.	ISSUE DATE <b>02/22/23</b>
------------------------	-------------------------------

DRAWING TITLES  
**TERRACE FLOOR PLAN**

SHEET SIZE	A2	SCALE	1 : 100
SHEET NO.	<b>A104</b>		

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E2  
ELEVATION - E2  
1 : 100

E1  
ELEVATION - E1  
1 : 100

GENERAL NOTES

REVISIONS

REV. NO.	REV. DATE	REV. DESCRIPTION	REV. BY	CHK. BY

CONSULTANT  
LEAD CONSULTANT

LANDSCAPE DESIGN

REGISTERED LOCAL CONSULTANT



CONSULTANT PROJECT NO. R21323MNU	
ARCHITECT	Mariyam Irasha Shareef
CIVIL ENGINEER	Zainal Abidheen
MEP ENGINEER	-
INT. DESIGNER	-
INFRA. DESIGNER	-
DRAWN BY	Mariyam Leevan Jaleel
CHECKED BY	Zunabath Abdul Majid
APPROVED BY	-

PROJECT NAME  
**Preparation of Drawings  
for Gn. Fuvahmulah  
Campus (Main Block)**

CLIENT	The Maldives National University
DEVELOPER	-
ATOLL	Gnaviyani Atoll (GN.)
ISLAND	Gn. Fuvahmulah
LAGOON (GPS COORDINATES)	
ISSUED FOR	

BUILDING NAME <b>Gn. Fuvahmulah Campus</b>	
BUILDING/STRUCTURE NO.	ISSUE DATE 02/22/23

DRAWING TITLES  
**ELEVATION - E1 & E2**

SHEET SIZE	A2	SCALE	1 : 100
SHEET NO.	<b>A106</b>		

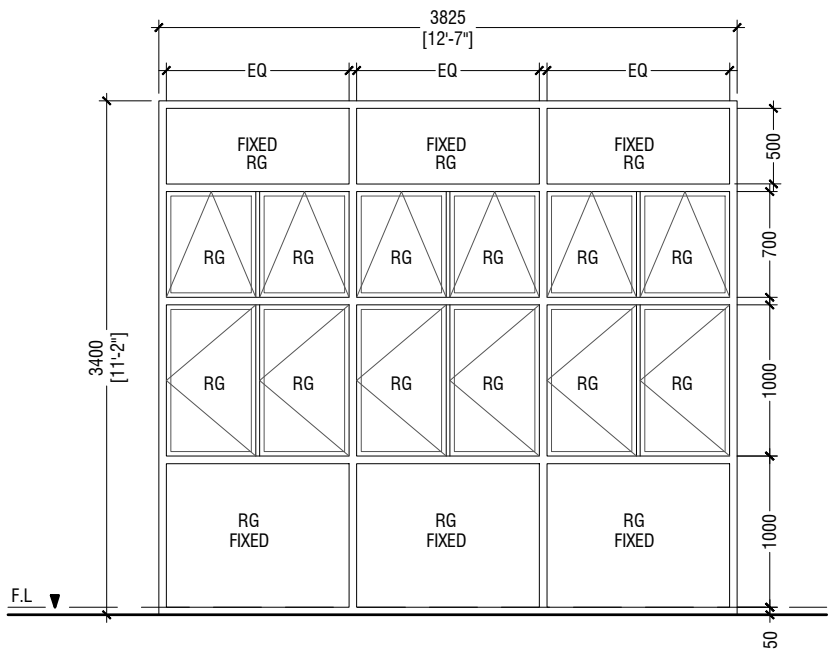
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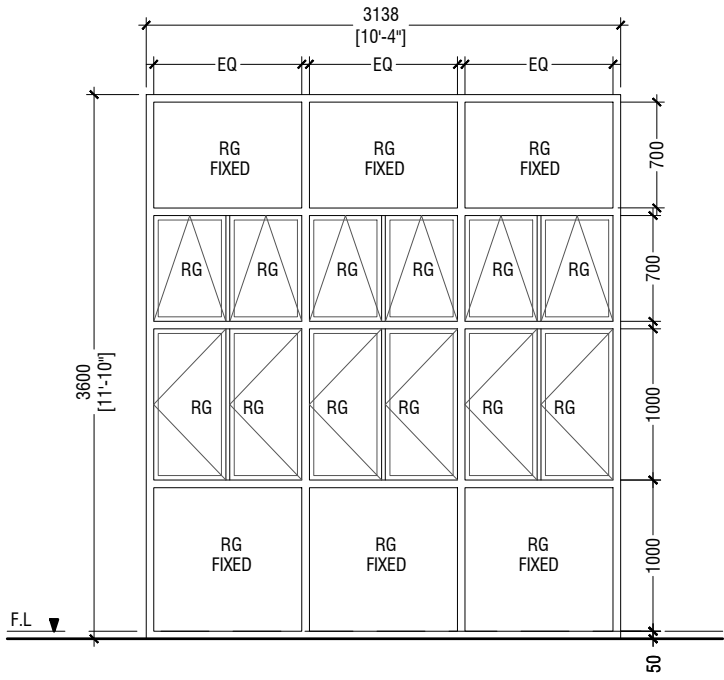




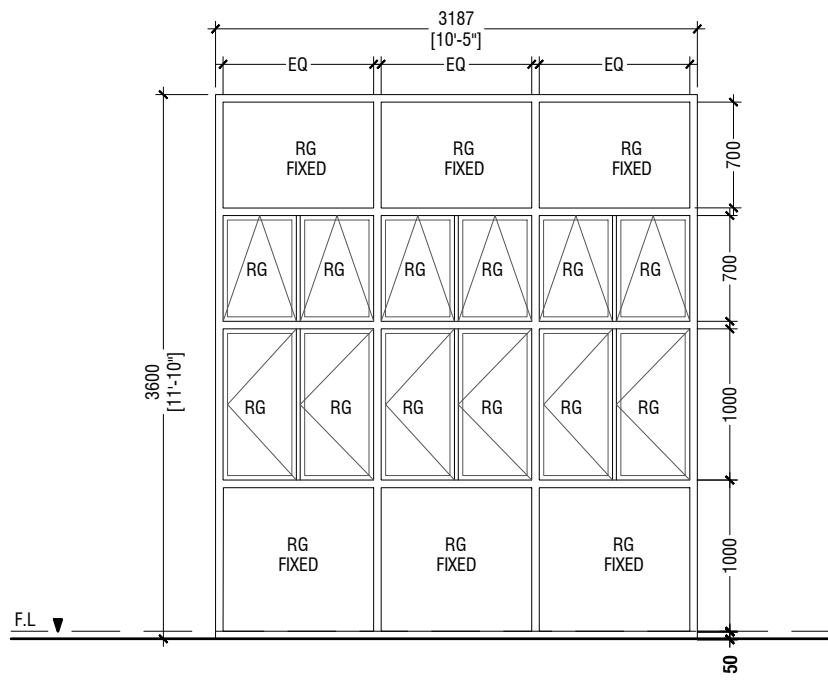
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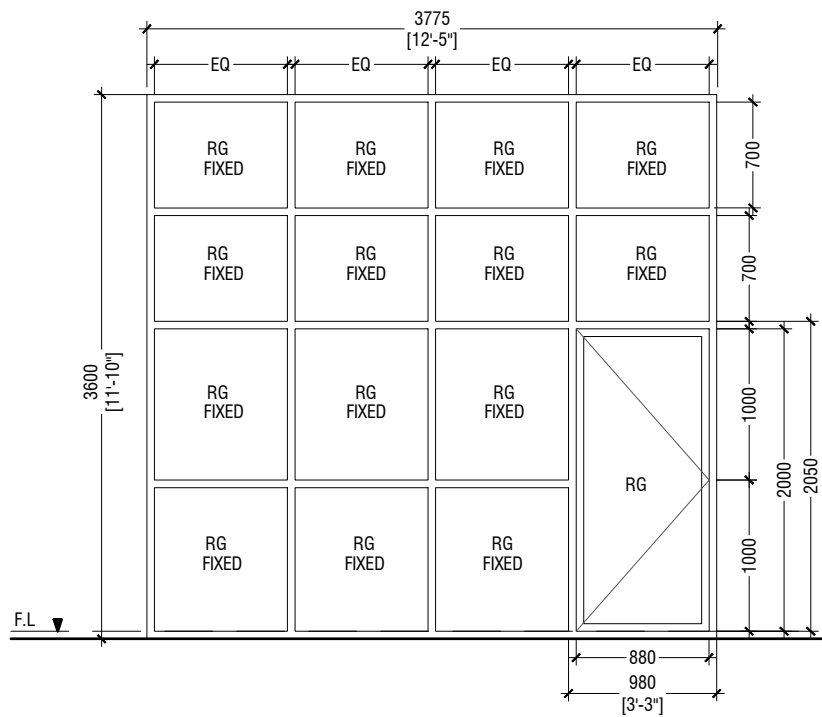
(CW1)	CURTAIN WALL WITH FIXED GLASS AND SWINGING WINDOWS
REMARKS	CURTAIN WALL WITH SWINGING WINDOWS.
LOCATION	FACADE
QUANTITY	02 NOS
OPEN AREA	6.06 sqm



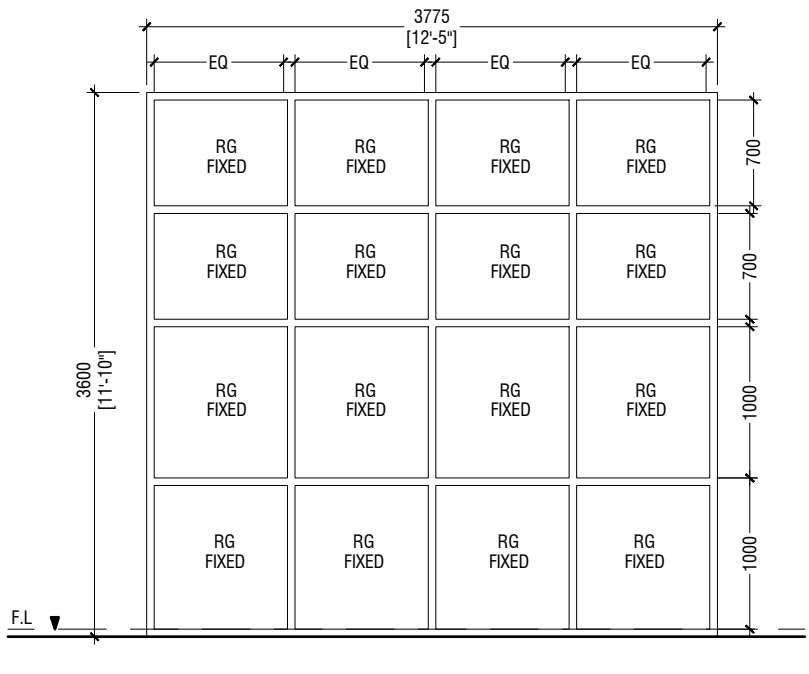
(CW2)	CURTAIN WALL WITH FIXED GLASS AND SWINGING WINDOWS
REMARKS	CURTAIN WALL WITH SWINGING WINDOWS.
LOCATION	FACADE
QUANTITY	01 NOS
OPEN AREA	4.86 sqm



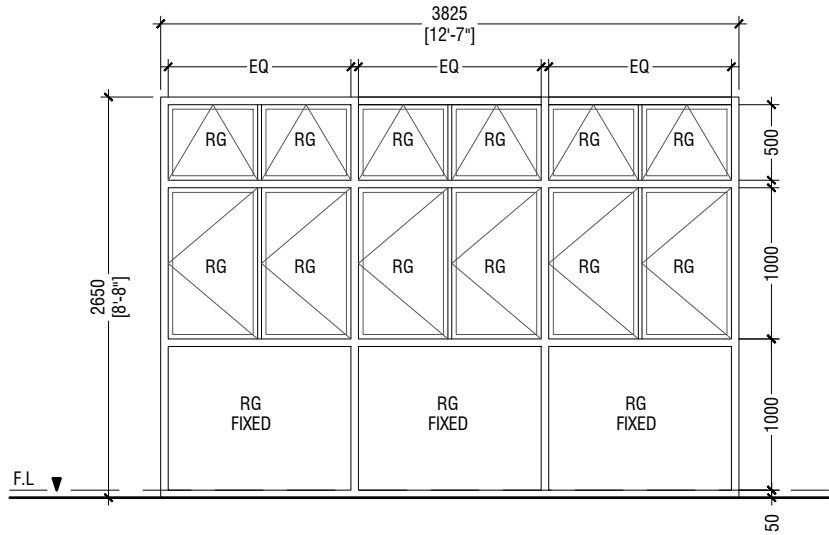
(CW3)	CURTAIN WALL WITH FIXED GLASS AND SWINGING WINDOWS
REMARKS	CURTAIN WALL WITH SWINGING WINDOWS.
LOCATION	FACADE
QUANTITY	03 NOS
OPEN AREA	4.98 sqm



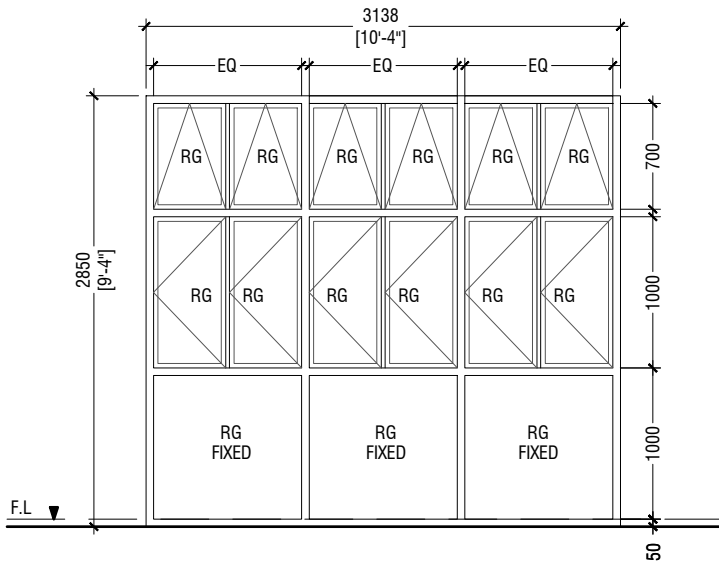
(CW4)	CURTAIN WALL WITH FIXED GLASS AND SWINGING DOOR
REMARKS	CURTAIN WALL WITH SWING DOOR AND FIXED GLASS.
LOCATION	FACADE
QUANTITY	01 NOS
OPEN AREA	1.83



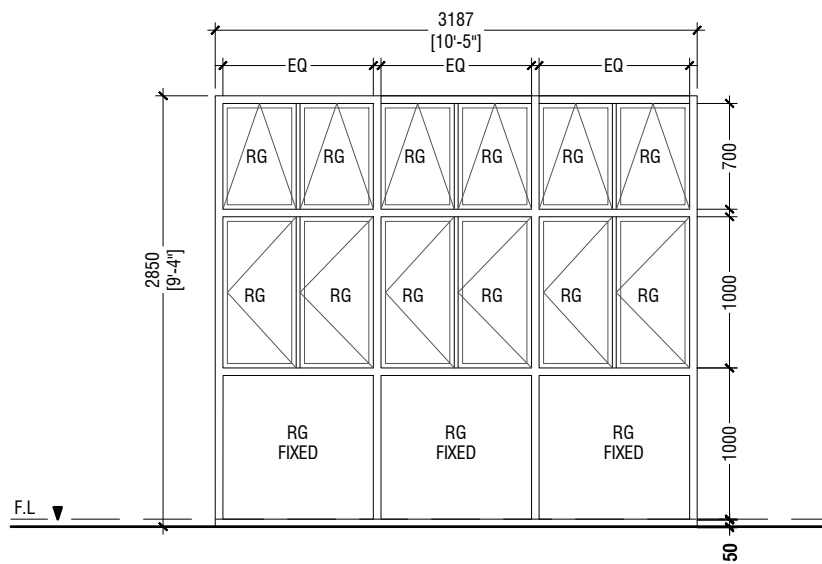
(CW5)	CURTAIN WALL WITH FIXED GLASS
REMARKS	CURTAIN WALL WITH FIXED GLASS.
LOCATION	FACADE
QUANTITY	01 NOS
OPEN AREA	0



(CW6)	CURTAIN WALL WITH FIXED GLASS AND SWINGING WINDOWS
REMARKS	CURTAIN WALL WITH SWINGING WINDOWS.
LOCATION	FACADE
QUANTITY	04 NOS
OPEN AREA	5.34 sqm



(CW7)	CURTAIN WALL WITH FIXED GLASS AND SWINGING WINDOWS
REMARKS	CURTAIN WALL WITH SWINGING WINDOWS.
LOCATION	FACADE
QUANTITY	02 NOS
OPEN AREA	4.86 sqm



(CW8)	CURTAIN WALL WITH FIXED GLASS AND SWINGING WINDOWS
REMARKS	CURTAIN WALL WITH SWINGING WINDOWS.
LOCATION	FACADE
QUANTITY	06 NOS
OPEN AREA	4.98 sqm

LEGEND:  
CG - CLEAR GLASS  
RG - REFLECTED GLASS  
AL - ALUMINIUM  
PVC - POLYVINYL CHLORIDE

NOTE:-  
1. MAINTAIN FLOOR TO WINDOW SILL STANDARD HEIGHT REGULATION OF 1M.  
2. ALL DOORS & WINDOWS TO BE CHECKED ON SITE BEFORE FABRICATION.  
3. ALL DOOR & WINDOWS VIEWED FROM EXTERIOR, FOR DOOR SWING, REFER TO FLOOR PLANS.  
4. THE DOORS / WINDOWS WHICH DO NOT TOUCH THE BEAM SHALL HAVE A LINTEL BEAM (LB) ABOVE THE DOOR / WINDOW.  
5. FOR ALL THE WINDOWS PUT A SILL BEAM BELOW THE WINDOW (SB)  
6. FOR SAFETY PURPOSES REFER TO TECHNICAL SPECIFICATIONS FOR GLASS THICKNESS.

## ① CURTAIN WALL SCHEDULE

1 : 50

## GENERAL NOTES

## REVISIONS

REV.NO	REV DATE	REV DESCRIPTION	REV BY	CHK BY

CONSULTANT  
LEAD CONSULTANT

LANDSCAPE DESIGN

REGISTERED LOCAL CONSULTANT



CONSULTANT PROJECT NO. <b>R21323MMNU</b>	
ARCHITECT	<b>Mariyam Irasha Shareef</b>
CIVIL ENGINEER	<b>Zainal Abiddeen</b>
MEP ENGINEER	-
INT. DESIGNER	-
INFRA. DESIGNER	-
DRAWN BY	<b>Mariyam Leevan Jaleel</b>
CHECKED BY	<b>Zunabath Abdul Majid</b>
APPROVED BY	-

## PROJECT NAME Preparation of Drawings for Gn. Fuvahmulah Campus (Main Block)

CLIENT	<b>The Maldives National University</b>
DEVELOPER	-
ATOLL	<b>Gnaviyani Atoll (GN.)</b>
ISLAND	<b>Gn. Fuvahmulah</b>
LAGOON (GPS COORDINATES)	
ISSUED FOR	

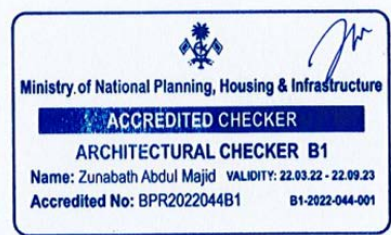
BUILDING NAME <b>Gn. Fuvahmulah Campus</b>	
BUILDING/STRUCTURE NO.	ISSUE DATE <b>02/22/23</b>

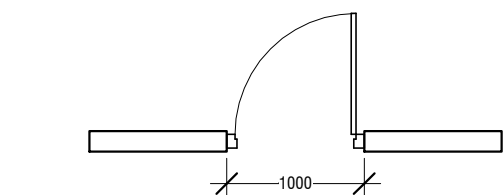
## DRAWING TITLES CURTAIN WALL SCHEDULE

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SHEET NO.			

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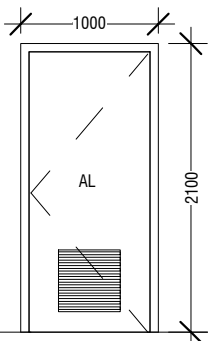
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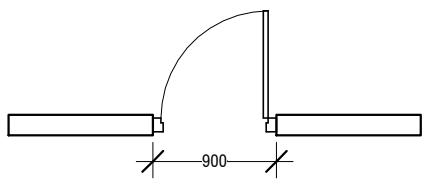
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B.B.L



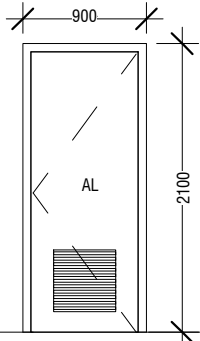
F.F.L

(D1)	SWING DOOR
REMARKS	50mm THICK WHITE POWDER COATED (60 MICRONS) ALUMINUM FRAMED WITH ALUMINIUM PANEL AND ALUMINIUM LOUVERS
LOCATION	SERVICES ROOM
QUANTITY	15
AREA	1.85 M <sup>2</sup>



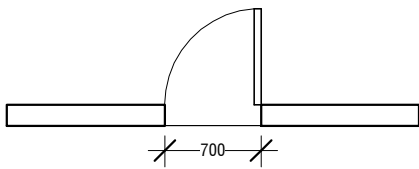
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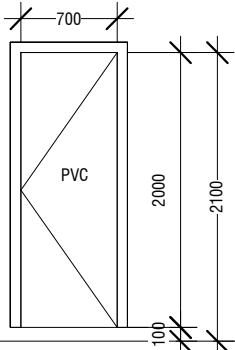
F.F.L

(D2)	SWING DOOR
REMARKS	50mm THICK WHITE POWDER COATED (60 MICRONS) ALUMINUM FRAMED WITH ALUMINIUM PANEL AND ALUMINIUM LOUVERS
LOCATION	TOILET ENTRANCES
QUANTITY	08
AREA	1.64 M <sup>2</sup>



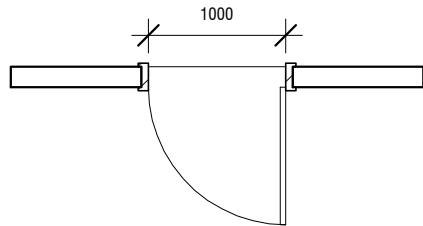
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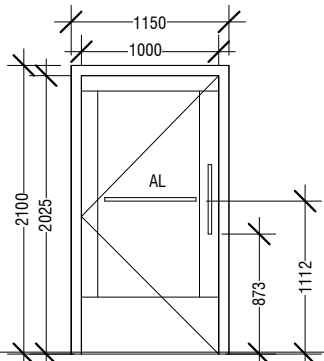
F.F.L

(D3)	SWING DOOR
REMARKS	PVC WHITE FRAME AND PANEL
LOCATION	TOILET STALLS
QUANTITY	26
AREA	1.17 M <sup>2</sup>



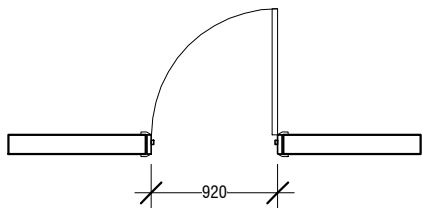
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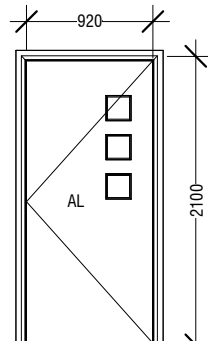
F.F.L

(D4)	SWING DOOR
REMARKS	50mm THICK WHITE POWDER COATED (60 MICRONS) ALUMINUM FRAMED WITH ALUMINIUM PANEL WITH SUPPORTING GRAB RAILS
LOCATION	TOILET FOR DISABLED
QUANTITY	04
AREA	1.78 M <sup>2</sup>



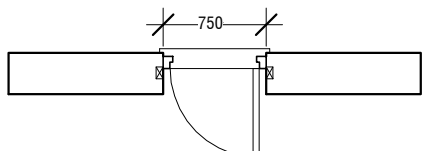
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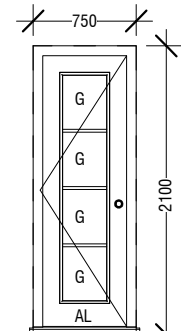
F.F.L

(D5)	SWING DOOR
REMARKS	50mm THICK WHITE POWDER COATED (60 MICRONS) ALUMINUM FRAMED WITH ALUMINIUM PANEL GLASS ON PANEL : 6mm THK CLEAR GLASS
LOCATION	ROOMS
QUANTITY	15
AREA	1.68 M <sup>2</sup>



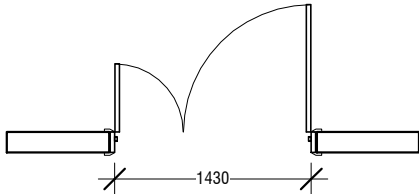
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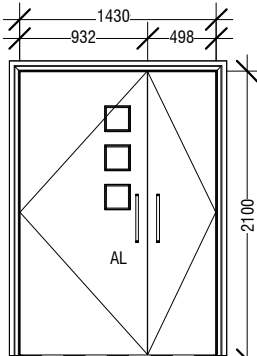
F.F.L

(D6)	SWING DOOR
REMARKS	50mm THICK WHITE POWDER COATED (60 MICRONS) ALUMINUM FRAMED WITH ALUMINIUM PANEL GLASS ON PANEL : 6mm THK CLEAR GLASS
LOCATION	KIOSK
QUANTITY	05
AREA	1.33 M <sup>2</sup>



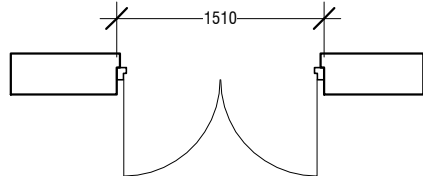
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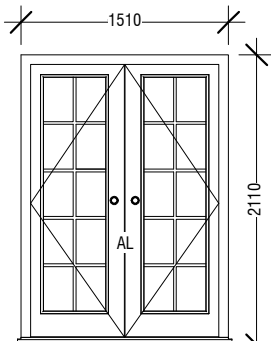
F.F.L

(D7)	SWING DOOR
REMARKS	50mm THICK WHITE POWDER COATED (60 MICRONS) ALUMINUM FRAMED WITH ALUMINIUM PANEL GLASS ON PANEL : 6mm THK CLEAR GLASS
LOCATION	TRAINING ROOM
QUANTITY	03
AREA	2.73 M <sup>2</sup>



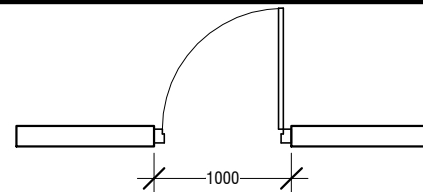
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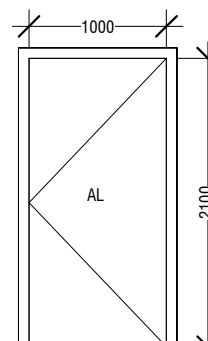
F.F.L

(D8)	SWING DOOR
REMARKS	50mm THICK WHITE POWDER COATED (60 MICRONS) ALUMINUM FRAMED WITH ALUMINIUM PANEL GLASS ON PANEL : 6mm THK CLEAR GLASS
LOCATION	TERRACE ENTRANCE
QUANTITY	01
AREA	2.91 M <sup>2</sup>



S.B.L

B.B.L



F.F.L

(D1A)	SWING DOOR
REMARKS	50mm THICK WHITE POWDER COATED (60 MICRONS) ALUMINUM FRAMED WITH ALUMINIUM PANEL
LOCATION	SERVICES ROOM
QUANTITY	02
AREA	1.85 M <sup>2</sup>

DOOR SCHEDULE  
1 : 50

LEGEND:  
CG - CLEAR GLASS  
RG - REFLECTED GLASS  
AL - ALUMINIUM  
PVC - POLYVINYL CHLORIDE

NOTE:-  
1. MAINTAIN FLOOR TO WINDOW SILL STANDARD HEIGHT REGULATION OF 1M.  
2. ALL DOORS & WINDOWS TO BE CHECKED ON SITE BEFORE FABRICATION.  
3. ALL DOOR & WINDOWS VIEWED FROM EXTERIOR, FOR DOOR SWING, REFER TO FLOOR PLANS.  
4. THE DOORS / WINDOWS WHICH DO NOT TOUCH THE BEAM SHALL HAVE A LINTEL BEAM (LB) ABOVE THE DOOR / WINDOW.  
5. FOR ALL THE WINDOWS PUT A SILL BEAM BELOW THE WINDOW (SB)



GENERAL NOTES

REVISIONS

REV.NO	REV DATE	REV DESCRIPTION	REV BY	CHK BY

CONSULTANT  
LEAD CONSULTANT

LANDSCAPE DESIGN

REGISTERED LOCAL CONSULTANT



CONSULTANT PROJECT NO. R21323MNU	
ARCHITECT	Mariyam Irasha Shareef
CIVIL ENGINEER	Zainal Abidheen
MEP ENGINEER	-
INT. DESIGNER	-
INFRA. DESIGNER	-
DRAWN BY	Mariyam Leevan Jaleel
CHECKED BY	Zunabath Abdul Majid
APPROVED BY	-

PROJECT NAME  
**Preparation of Drawings  
for Gn. Fuvahmulah  
Campus (Main Block)**

CLIENT	The Maldives National University
DEVELOPER	-
ATOLL	Gnaviyani Atoll (GN.)
ISLAND	Gn. Fuvahmulah
LAGOON (GPS COORDINATES)	
ISSUED FOR	

BUILDING NAME <b>Gn. Fuvahmulah Campus</b>	
BUILDING/STRUCTURE NO.	ISSUE DATE 02/22/23

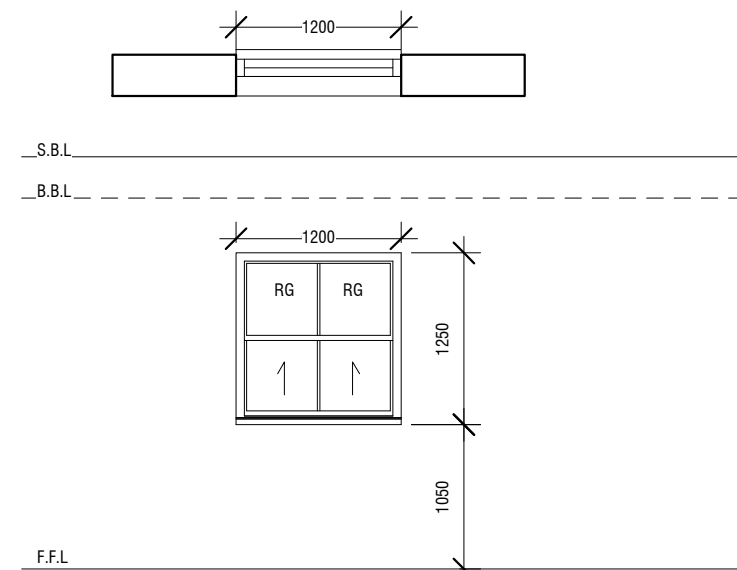
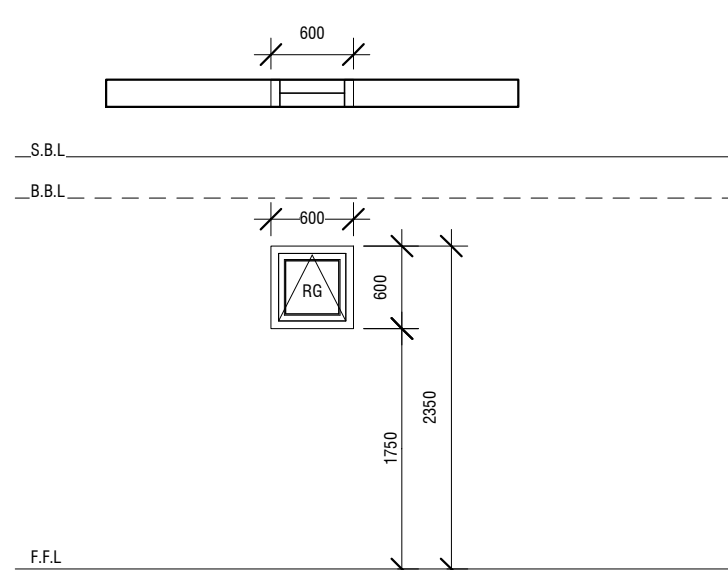
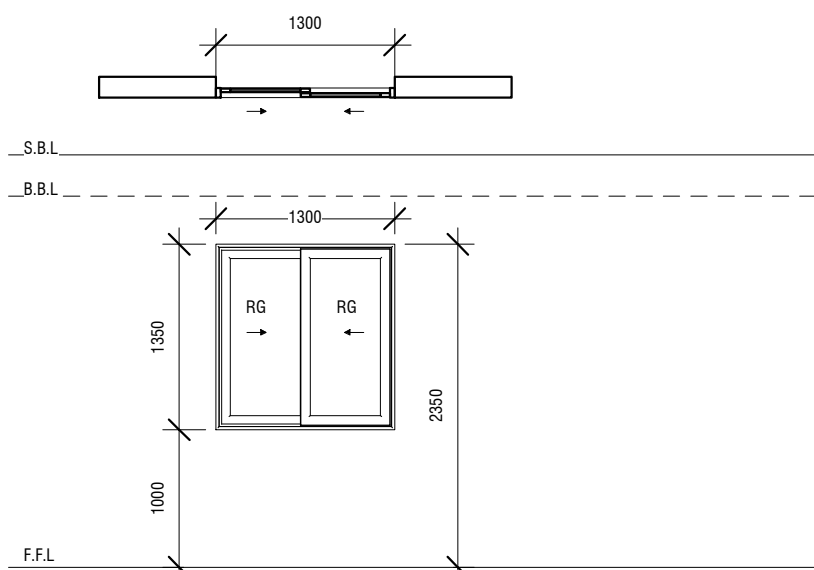
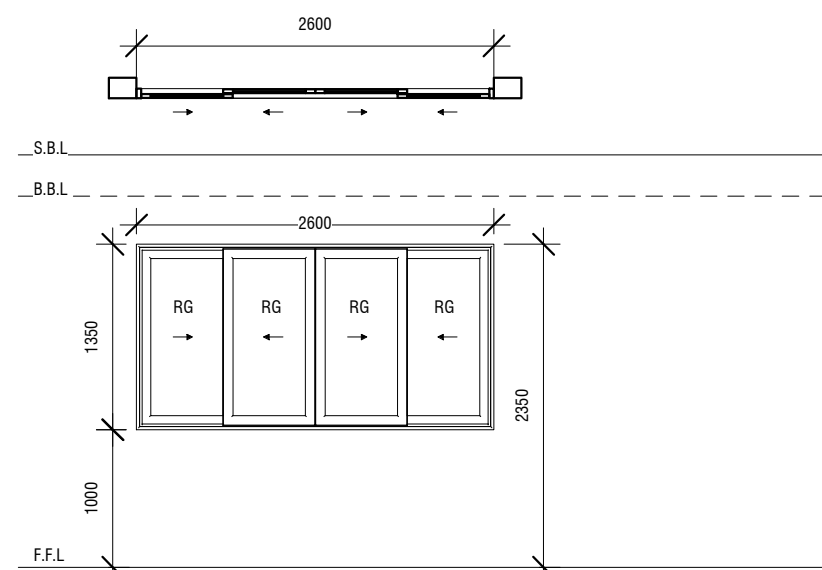
DRAWING TITLES  
**DOOR SCHEDULE**

SHEET SIZE	A2	SCALE	1 : 50
SHEET NO.			

A109

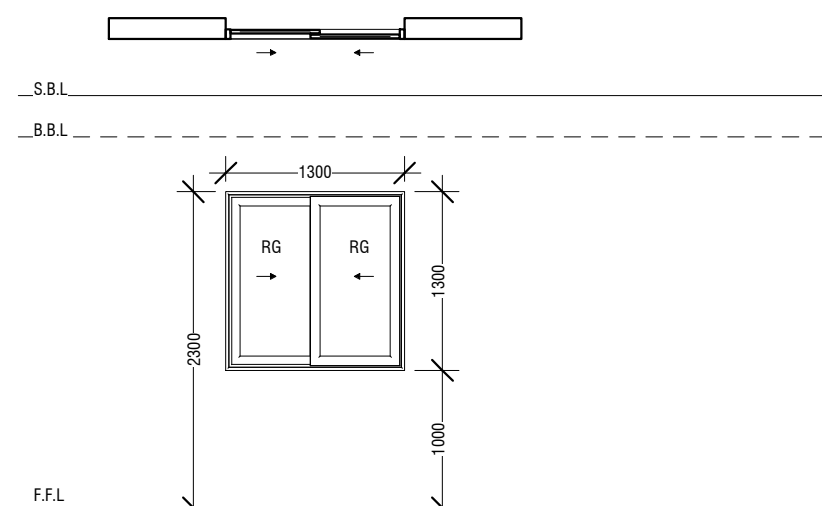
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




**NOTE:-**

1. MAINTAIN FLOOR TO WINDOW SILL STANDARD HEIGHT REGULATION OF 1M.
2. ALL DOORS & WINDOWS TO BE CHECKED ON SITE BEFORE FABRICATION.
3. ALL DOOR & WINDOWS VIEWED FROM EXTERIOR, FOR DOOR SWING, REFERS TO FLOOR PLANS.
4. THE DOORS / WINDOWS WHICH DO NOT TOUCH THE BEAM SHALL HAVE A LINTEL BEAM (LB) ABOVE THE DOOR / WINDOW.
5. FOR ALL THE WINDOWS PUT A SILL BEAM BELOW THE WINDOW (SB)
6. FOR SAFETY PURPOSES REFER TO TECHNICAL SPECIFICATIONS FOR GLASS THICKNESS.




GENERAL NOTES				
REVISIONS				
REV.NO.	REV.DATE	REV.DESCRPTION	REV.BY	CHK.BY
CONSULTANT				
LEAD CONSULTANT				
LANDSCAPE DESIGN				
REGISTERED LOCAL CONSULTANT				
<div><p><b>RIYANI PRIVATE LIMITED</b> www.riyani.com.mv</p></div>				
CONSULTANT PROJECT NO. <b>R21323MNU</b>				
ARCHITECT	<b>Mariyam irasha Shareef</b>			
CIVIL ENGINEER	<b>Zainal Abidtheen</b>			
MEP ENGINEER	-			
INT. DESIGNER	-			
INFRA. DESIGNER	-			
DRAWN BY	<b>Mariyam Leevan Jaleel</b>			
CHECKED BY	<b>Zunabath Abdul Majid</b>			
APPROVED BY	-			
PROJECT NAME				
<b>Preparation of Drawings for Gn. Fuvahmulah Campus (Main Block)</b>				
CLIENT	<b>The Maldives National University</b>			
DEVELOPER	-			
ATOLL	<b>Gnaviyani Atoll (Gn.)</b>			
ISLAND	<b>Gn. Fuvahmulah</b>			
LAGOON (GPS COORDINATES)				
ISSUED FOR				
BUILDING NAME				
<b>Gn. Fuvahmulah Campus</b>				
BUILDING/STRUCTURE NO.		ISSUE DATE		
		<b>02/22/23</b>		
DRAWING TITLES				
<b>WINDOW SCHEDULE</b>				
SHEET SIZE		A2	SCALE <b>1 : 60</b>	
SHEET NO.				
<b>A110</b>				
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## VENTILATION SCHEDULE

	ROOM NAME/ NUMBER	ROOM AREA(sq m) (specify centre to centre or clear)	WINDOW (opening) NUMBER	REQUIRED OPENING AREA (sq m)	DESIGNED OPEN AREA (sq m)	OPEN %
<b>GROUND FLOOR</b>						
1	OFFICE 1	31	CW1,CW2,CW3,SW2	3.1	18.24	58.8%
2	OFFICE 2 AND WAITING AREA	188	SW2*3,CW4*3,CW5	18.8	19.29	10.3%
3	SENIOR STAFF OFFICE	77	SW2*3,SW1*5	7.7	9.66	12.5%
4	DEAN'S ROOM	27	SW1,SW2,D5	2.7	3.9	14.4%
5	EXECUTIVE MEETING ROOM	42	SW1*3,SW2	4.2	5.22	12.4%
<b>FIRST FLOOR</b>						
1	TRAINING ROOM 01	62	CW1,CW2,CW3,CW4,SW2*2	6.2	24.06	38.8%
2	TRAINING ROOM 02	62	SW2*2,CW4*2	6.2	11.64	18.8%
3	TRAINING ROOM 03	62	SW*2,SW1*2,D5	6.2	6.23	10.0%
4	TRAINING ROOM 04	62	SW2*2,SW1*4	6.2	7.44	12.0%
5	TRAINING ROOM 05	50	SW*2,SW1*2,D5	5	6.23	12.5%
6	TRAINING ROOM 06	50	SW*2,SW1*2,D5	5	6.23	12.5%
7	TRAINING ROOM 07	50	SW*2,SW1*4	5	7.44	14.9%
<b>SECOND FLOOR</b>						
1	TRAINING ROOM / HALL	178	CW1,CW2,CW3,CW4*3,SW2*2	17.8	31.38	17.6%
2	TRAINING ROOM 08	50	SW*2,SW1*2,D5	5	6.23	12.5%
3	TRAINING ROOM 09	50	SW*2,SW1*2,D5	5	6.23	12.5%
4	TRAINING ROOM 10	50	SW*2,SW1*4	5	7.44	14.9%

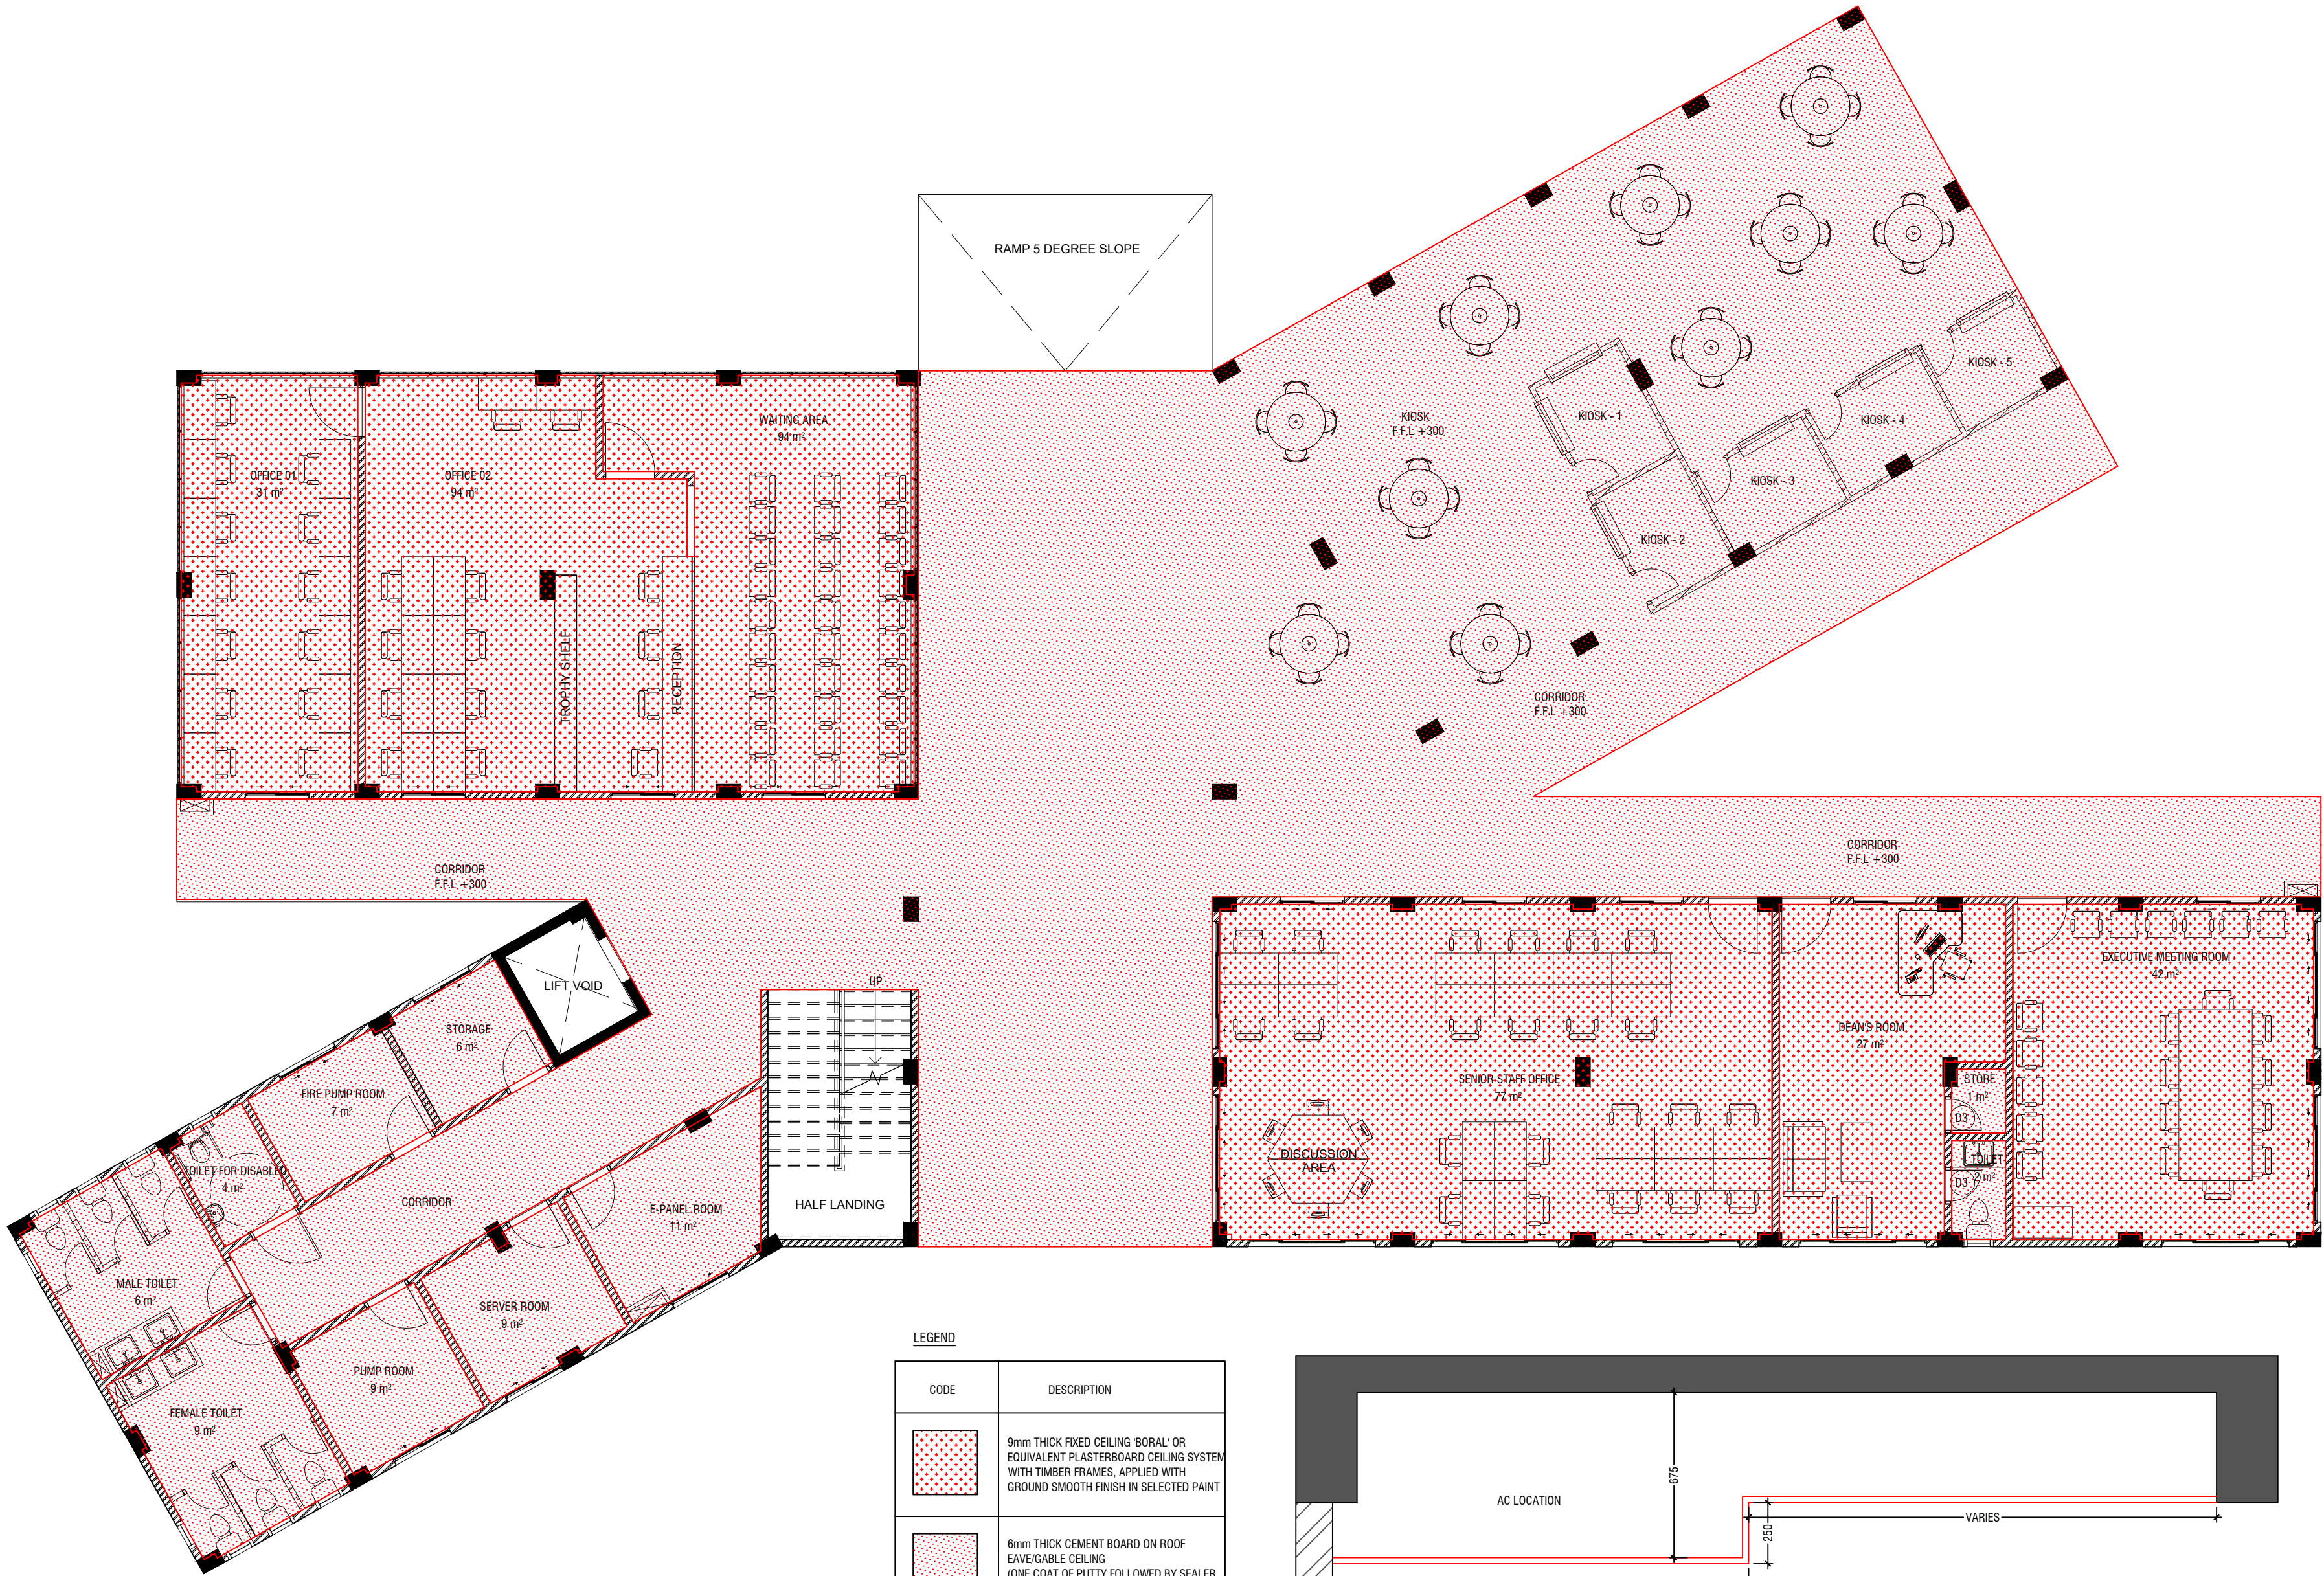
Note: All Toilets, Services Room and Store are mechanically Ventilated

GENERAL NOTES				
REVISIONS				
REV NO.	REV DATE	REV DESCRIPTION	REV BY	CHK BY
CONSULTANT				
LEAD CONSULTANT				
LANDSCAPE DESIGN				
REGISTERED LOCAL CONSULTANT				
 <p><b>RIYAH PRIVATE LIMITED</b> www.riyah.com.mv</p>				
CONSULTANT PROJECT NO. <b>R21323MNU</b>				
ARCHITECT	<b>Mariyam Irasha Shareef</b>			
CIVIL ENGINEER	<b>Zainal Abidheem</b>			
MEP ENGINEER	-			
INT. DESIGNER	-			
INFRA. DESIGNER	-			
DRAWN BY	<b>Mariyam Leevan Jaleel</b>			
CHECKED BY	<b>Zunabath Abdul Majid</b>			
APPROVED BY	-			
PROJECT NAME				
<b>Preparation of Drawings for Gn. Fuvahmulah Campus (Main Block)</b>				
CLIENT	<b>The Maldives National University</b>			
DEVELOPER	-			
ATOLL	<b>Gnaviyani Atoll (GN.)</b>			
ISLAND	<b>Gn. Fuvahmulah</b>			
LAGOON (SPS COORDINATES)				
ISSUED FOR				
BUILDING NAME				
<b>Gn. Fuvahmulah Campus</b>				
BUILDING/STRUCTURE NO.	ISSUE DATE <b>02/22/23</b>			
DRAWING TITLES				
<b>VENTILATION SCHEDULE</b>				
SHEET SIZE		<b>A2</b>	SCALE	
SHEET NO.				
<b>A11</b>				

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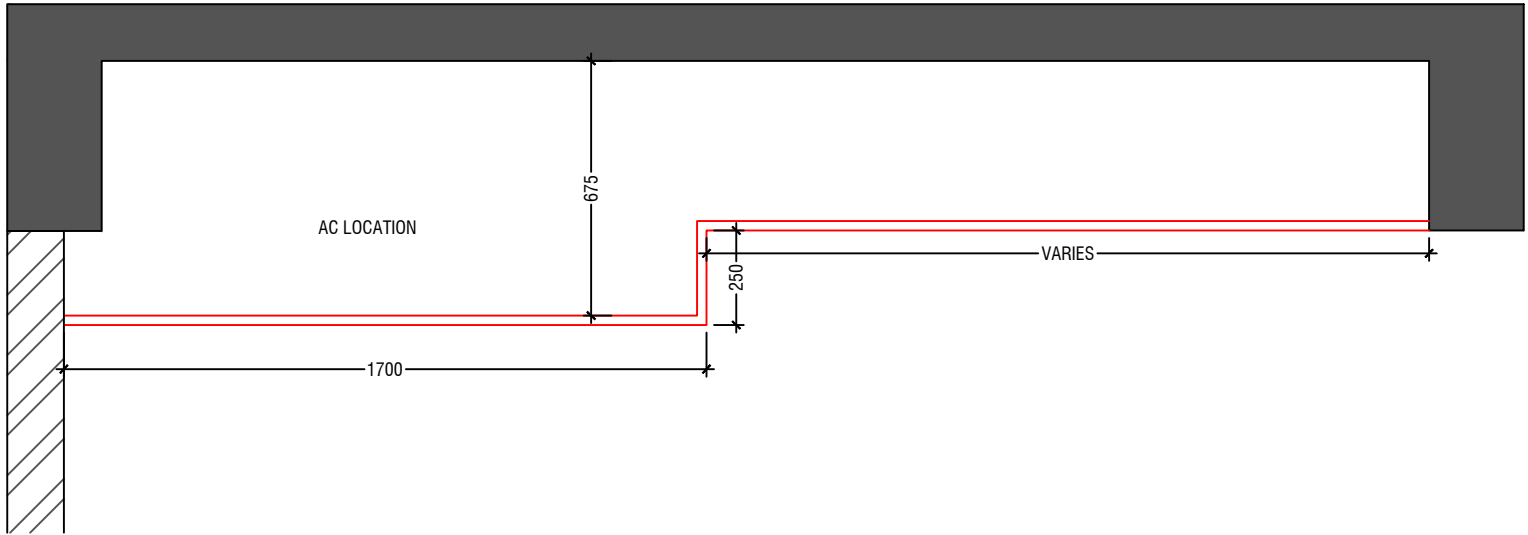


① GROUND FLOOR REFLECTED CEILING PLAN  
1 : 100



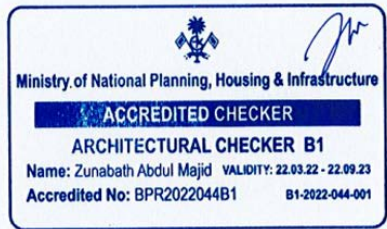
LEGEND	
CODE	DESCRIPTION
	9mm THICK FIXED CEILING 'BORAL' OR EQUIVALENT PLASTERBOARD CEILING SYSTEM WITH TIMBER FRAMES, APPLIED WITH GROUND SMOOTH FINISH IN SELECTED PAINT
	6mm THICK CEMENT BOARD ON ROOF EAVE/GABLE CEILING (ONE COAT OF PUTTY FOLLOWED BY SEALER AND 2 COATS OF PAINT)

NOTE: ANY UNIDENTIFIED AREAS TO HAVE EXPOSED SLAB SOFFIT TO BE GROUND SMOOTH IN SELECT PAINT FINISH (ONE COAT OF PUTTY FOLLOWED BY SEALER AND 2 COATS OF PAINT)



NOTE:  
ALL CEILING LEVEL TO BE AT BEAM BOTTOM LEVEL (UNLESS SPECIFIED)  
AREAS WHERE THE CASSETTE AC IS LOCATED, THE CEILING SHALL BE BELOW BEAM LEVEL (REFER TO THE CEILING DETAILS)

① CEILING DETAILS  
NOT TO SCALE



#### GENERAL NOTES

#### REVISIONS

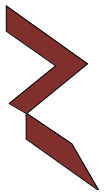
REV. NO.	REV. DATE	REV. DESCRIPTION	REV. BY	CHK. BY

#### CONSULTANT

#### LEAD CONSULTANT

#### LANDSCAPE DESIGN

#### REGISTERED LOCAL CONSULTANT



RIYAN PRIVATE LIMITED

www.riyan.com.mv

CONSULTANT PROJECT NO. R21323MNU

ARCHITECT	Mariyam Irasha Shareef
CIVIL ENGINEER	Zainal Abidheen
MEP ENGINEER	-
INT. DESIGNER	-
INFRA. DESIGNER	-
DRAWN BY	Mariyam Leevan Jaleel
CHECKED BY	Zunabath Abdul Majid
APPROVED BY	-

#### PROJECT NAME

Preparation of Drawings  
for Gn. Fuvahmulah  
Campus (Main Block)

CLIENT	The Maldives National University
DEVELOPER	-
ATOLL	Gnaviyani Atoll (GN.)
ISLAND	Gn. Fuvahmulah
LAGOON (GPS COORDINATES)	
ISSUED FOR	

#### BUILDING NAME

Gn. Fuvahmulah Campus

BUILDING/STRUCTURE NO.	ISSUE DATE
	02/22/23

#### DRAWING TITLES

#### GROUND FLOOR REFLECTED CEILING PLAN

SHEET SIZE	A2	SCALE
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#### SHEET NO.

#### A112

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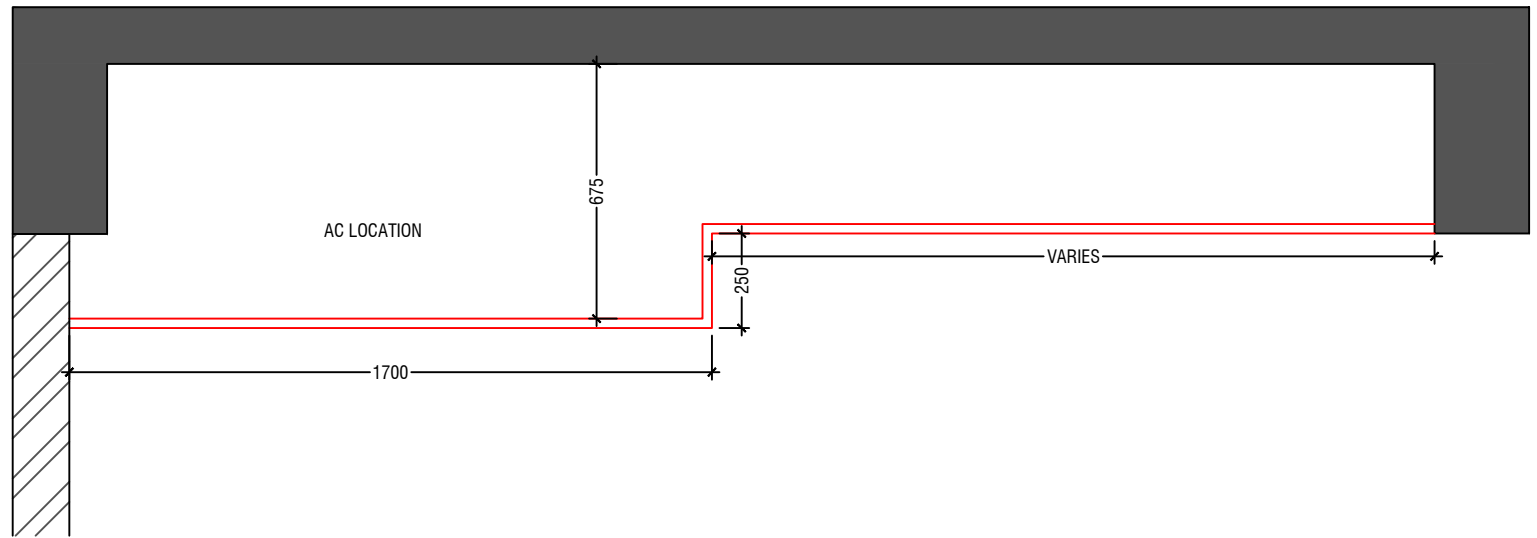
① FIRST FLOOR REFLECTED CEILING PLAN  
1 : 100



LEGEND

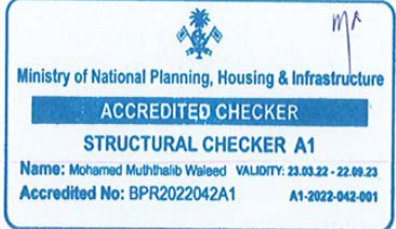
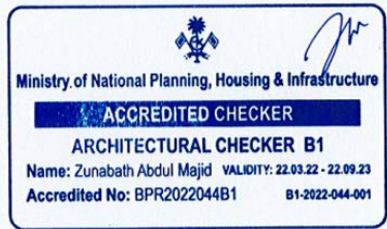
CODE	DESCRIPTION
	9mm THICK FIXED CEILING 'BORAL' OR EQUIVALENT PLASTERBOARD CEILING SYSTEM WITH TIMBER FRAMES, APPLIED WITH GROUND SMOOTH FINISH IN SELECTED PAINT
	6mm THICK CEMENT BOARD ON ROOF EAVE/GABLE CEILING (ONE COAT OF PUTTY FOLLOWED BY SEALER AND 2 COATS OF PAINT)

NOTE: ANY UNIDENTIFIED AREAS TO HAVE EXPOSED SLAB SOFFIT TO BE GROUND SMOOTH IN SELECT PAINT FINISH (ONE COAT OF PUTTY FOLLOWED BY SEALER AND 2 COATS OF PAINT)



NOTE:  
ALL CEILING LEVEL TO BE AT BEAM BOTTOM LEVEL (UNLESS SPECIFIED)  
AREAS WHERE THE CASSETTE AC IS LOCATED, THE CEILING SHALL BE BELOW BEAM LEVEL (REFER TO THE CEILING DETAILS)

① CEILING DETAILS  
NOT TO SCALE



GENERAL NOTES

REVISIONS

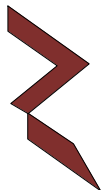
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CONSULTANT

LEAD CONSULTANT

LANDSCAPE DESIGN

REGISTERED LOCAL CONSULTANT



RIYAN PRIVATE LIMITED

www.riyan.com.mv

CONSULTANT PROJECT NO. R21323MNU

ARCHITECT	Mariyam Irasha Shareef
CIVIL ENGINEER	Zainal Abidheen
MEP ENGINEER	-
INT. DESIGNER	-
INFRA. DESIGNER	-
DRAWN BY	Mariyam Leevan Jaleel
CHECKED BY	Zunabath Abdul Majid
APPROVED BY	-

PROJECT NAME  
Preparation of Drawings  
for Gn. Fuvahmulah  
Campus (Main Block)

CLIENT	The Maldives National University
DEVELOPER	-
ATOLL	Gnaviyani Atoll (GN.)
ISLAND	Gn. Fuvahmulah
LAGOON (GPS COORDINATES)	
ISSUED FOR	

BUILDING NAME  
Gn. Fuvahmulah Campus

BUILDING/STRUCTURE NO.	ISSUE DATE 02/22/23
------------------------	------------------------

DRAWING TITLES  
FIRST FLOOR  
REFLECTED CEILING  
PLAN


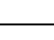
SHEET SIZE	A2	SCALE
SHEET NO.		

A113

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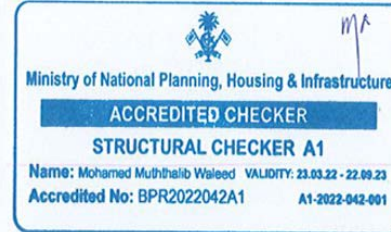
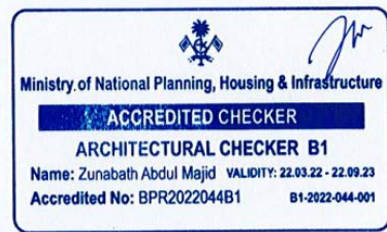




CODE	DESCRIPTION
	9mm THICK FIXED CEILING 'BORAL' OR EQUIVALENT PLASTERBOARD CEILING SYSTEM WITH TIMBER FRAMES, APPLIED WITH GROUND SMOOTH FINISH IN SELECTED PAINT
	6mm THICK CEMENT BOARD ON ROOF EAVE/GABLE CEILING (ONE COAT OF PUTTY FOLLOWED BY SEALER AND 2 COATS OF PAINT)

**NOTE:**  
ALL CEILING LEVEL TO BE AT BEAM BOTTOM LEVEL (UNLESS SPECIFIED)  
AREAS WHERE THE CASSETTE AC IS LOCATED, THE CEILING SHALL BE  
BELOW BEAM LEVEL (REFER TO THE CEILING DETAILS)

① CEILING DETAILS  
NOT TO SCALE



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GENERAL NOTES

REVISIONS

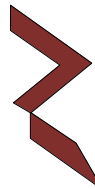
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CONSULTANT

LEAD CONSULTANT

LANDSCAPE DESIGN

REGISTERED LOCAL CONSULTANT



RIYAN PRIVATE LIMITED

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CONSULTANT PROJECT NO. R21323MNU

ARCHITECT	Mariyam Irasha Shareef
CIVIL ENGINEER	Zainal Abidheem
MEP ENGINEER	-
INT. DESIGNER	-
INFRA. DESIGNER	-
DRAWN BY	Mariyam Leevan Jaleel
CHECKED BY	Zunabath Abdul Majid
APPROVED BY	-

PROJECT NAME

Preparation of Drawings  
for Gn. Fuvahmulah  
Campus (Main Block)

CLIENT	The Maldives National University
DEVELOPER	-
ATOLL	Gnaviyani Atoll (GN.)
ISLAND	Gn. Fuvahmulah
LAGOON (GPS COORDINATES)	
ISSUED FOR	

BUILDING NAME

Gn. Fuvahmulah Campus

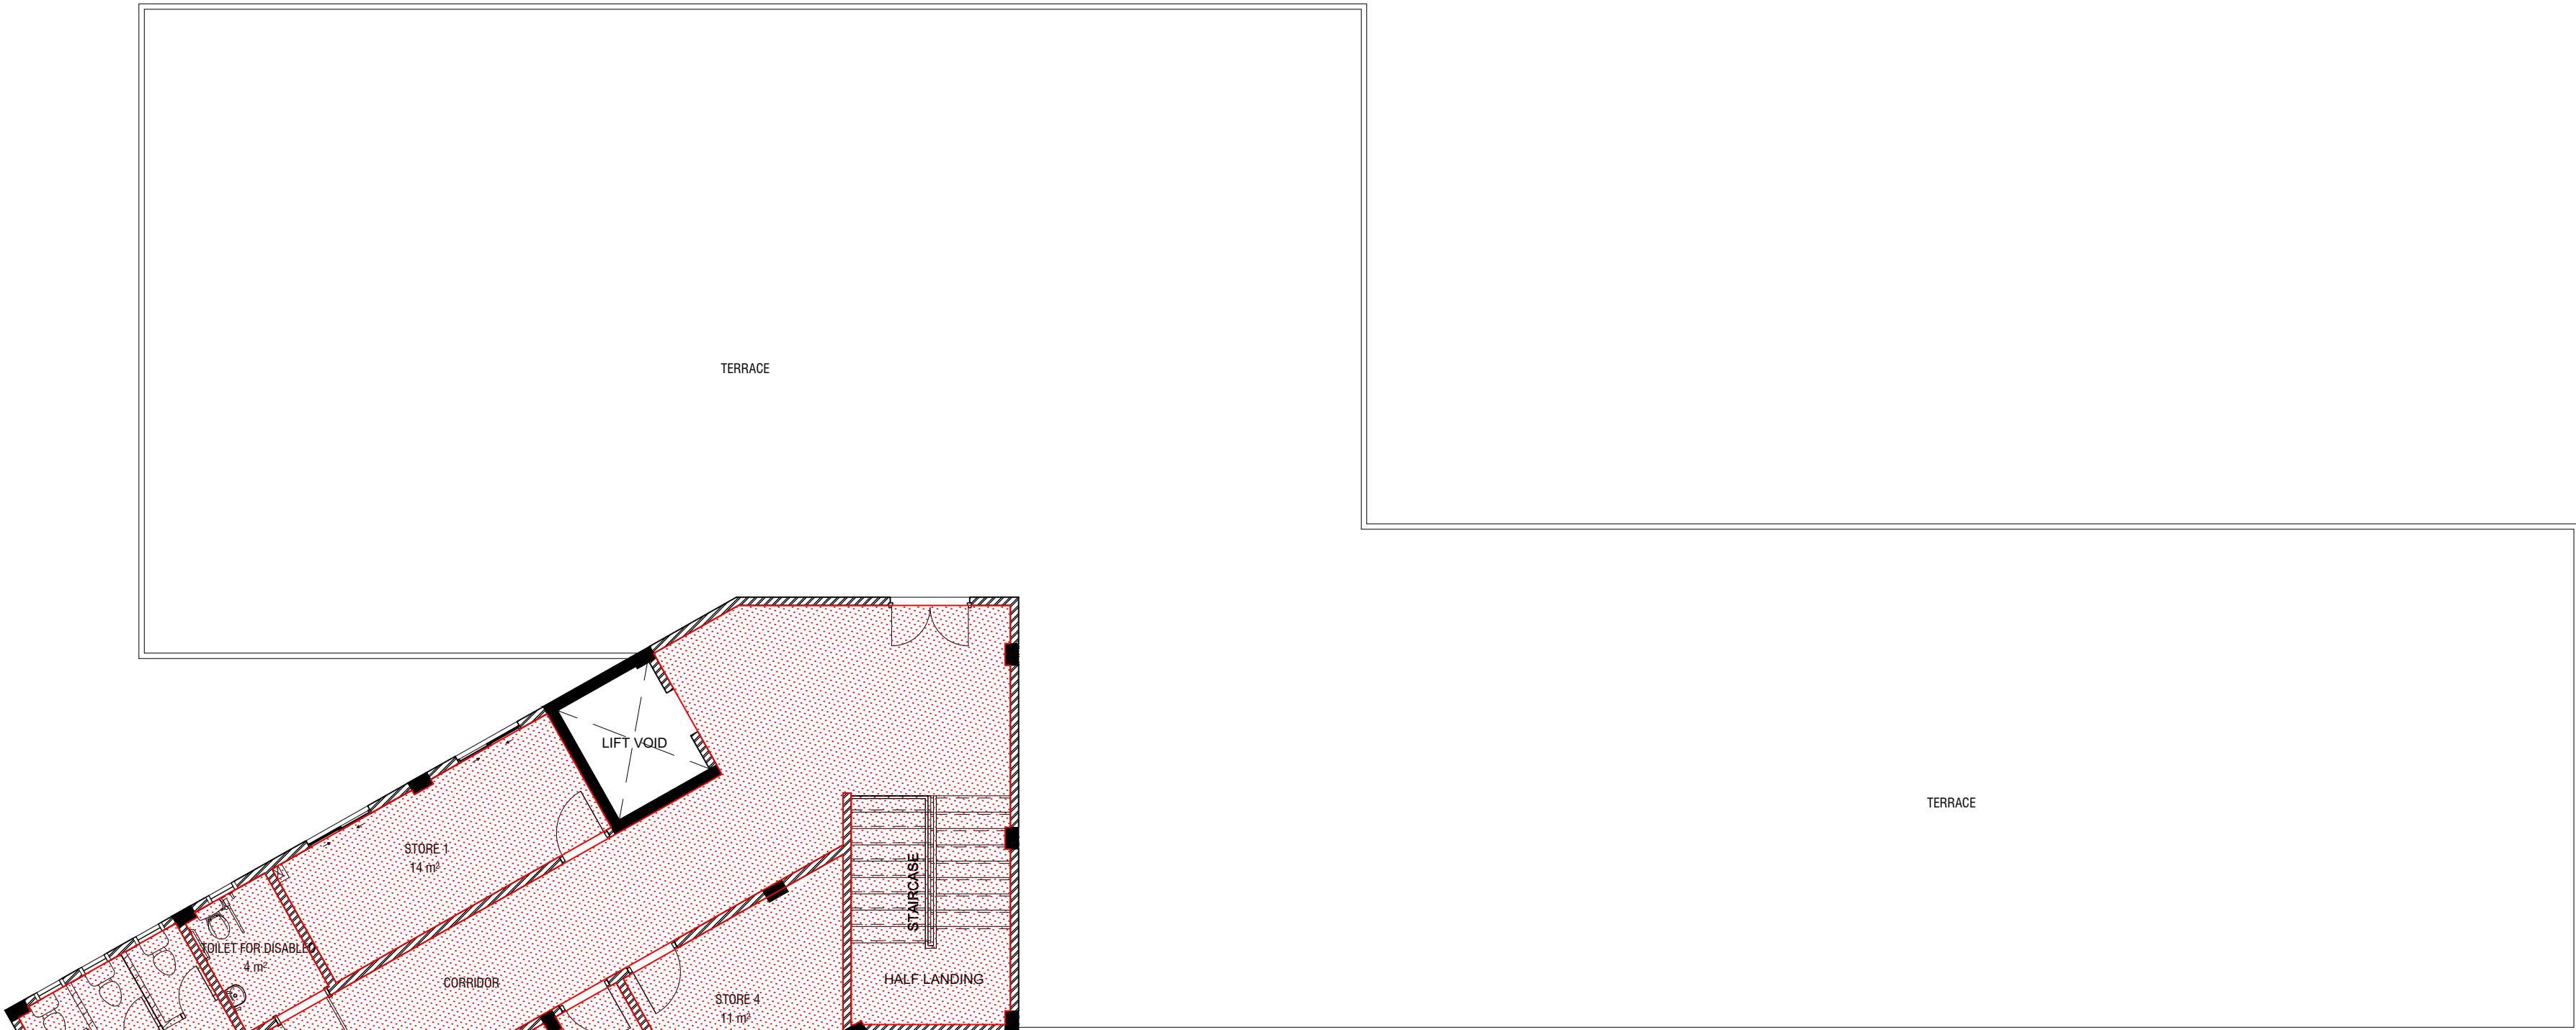
BUILDING/STRUCTURE NO.	ISSUE DATE
	02/22/23

DRAWING TITLES

TERRACE FLOOR  
REFLECTED CEILING  
PLAN

SHEET SIZE	A2	SCALE
SHEET NO.	A115	

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① TERRACE FLOOR REFLECTED CEILING PLAN  
1 : 100

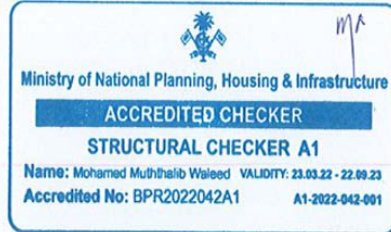
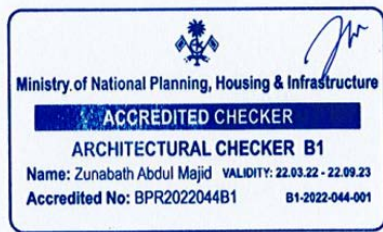
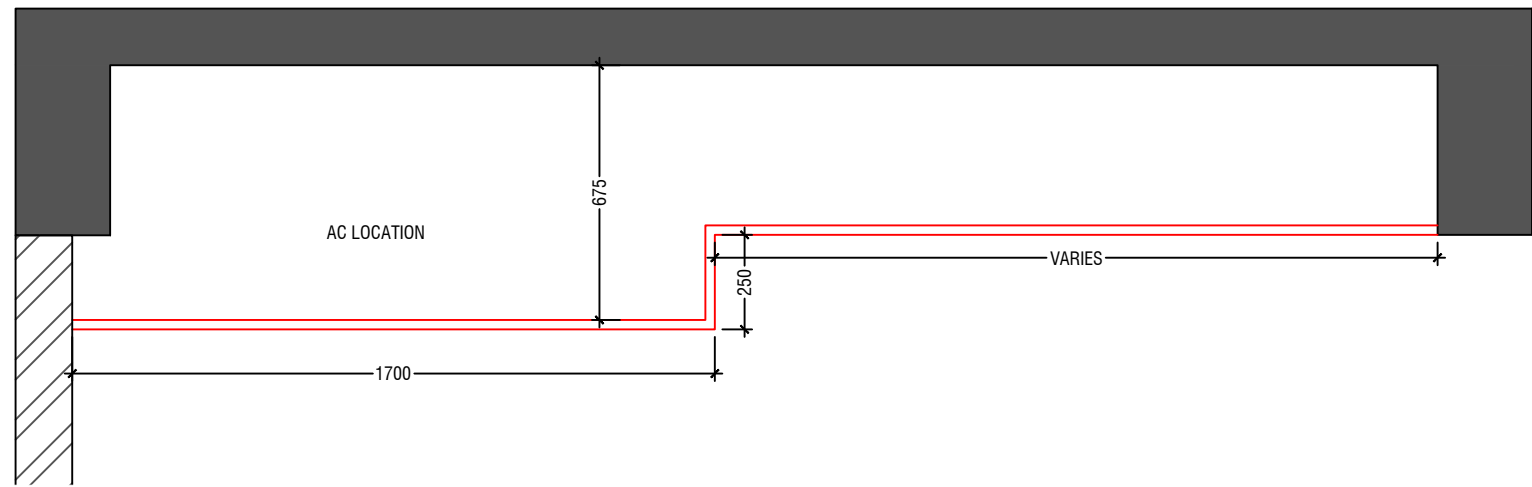
LEGEND

CODE	DESCRIPTION
	9mm THICK FIXED CEILING 'BORAL' OR EQUIVALENT PLASTERBOARD CEILING SYSTEM WITH TIMBER FRAMES, APPLIED WITH GROUND SMOOTH FINISH IN SELECTED PAINT
	6mm THICK CEMENT BOARD ON ROOF EAVE/CABLE CEILING (ONE COAT OF PUTTY FOLLOWED BY SEALER AND 2 COATS OF PAINT)

NOTE: ANY UNIDENTIFIED AREAS TO HAVE EXPOSED SLAB SOFFIT TO BE GROUND SMOOTH IN SELECT PAINT FINISH (ONE COAT OF PUTTY FOLLOWED BY SEALER AND 2 COATS OF PAINT)

NOTE:  
ALL CEILING LEVEL TO BE AT BEAM BOTTOM LEVEL (UNLESS SPECIFIED).  
AREAS WHERE THE CASSETTE AC IS LOCATED, THE CEILING SHALL BE BELOW BEAM LEVEL (REFER TO THE CEILING DETAILS)

① CEILING DETAILS  
NOT TO SCALE





① GROUND FLOOR, FLOOR FINISHES PLAN  
1 : 100



Ministry of National Planning, Housing & Infrastructure  
**ACCREDITED CHECKER**  
**ARCHITECTURAL CHECKER B1**  
Name: Zunabath Abdul Majid VALIDITY: 22.03.22 - 22.09.23  
Accredited No: BPR2022044B1 01-2022-044-001

Ministry of National Planning, Housing & Infrastructure  
**ACCREDITED CHECKER**  
**STRUCTURAL CHECKER A1**  
Name: Mohamed Muhsinib Waleed VALIDITY: 22.03.22 - 22.09.23  
Accredited No: BPR2022042A1 A1-2022-042-001

LEGEND

CODE	DESCRIPTION
	35mm NORMAL SCREEDING WITH 2.5mm SELF LEVELING CEMENT WITH EPOXY FLOOR PAINT (2 COATS OF EPOXY)
	600X600mm HOMOGENOUS NON-SLIP TILES OVER 25mm SCREEDING

NOTE: STAIRCASE TO HAVE HOMOGENOUS NON-SLIP TILES OVER 50mm SCREEDING (STEP TILE WITH GROOVE)

CODE	DESCRIPTION
	600X600mm HOMOGENOUS NON-SLIP TILES OVER 50mm SCREEDING
	SELF LEVELLING CEMENT FLOOR SCREED WITH BITUMINOUS WATERPROOFING AGENT

GENERAL NOTES

REVISIONS

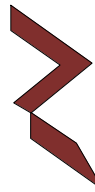
REV. NO.	REV. DATE	REV. DESCRIPTION	REV. BY	CHK. BY

CONSULTANT

LEAD CONSULTANT

LANDSCAPE DESIGN

REGISTERED LOCAL CONSULTANT



RYAN PRIVATE LIMITED

www.ryan.com.mv

CONSULTANT PROJECT NO: R21323MNU

ARCHITECT	Mariyam Irasha Shareef
CIVIL ENGINEER	Zainal Abidheem
MEP ENGINEER	-
INT. DESIGNER	-
INFRA. DESIGNER	-
DRAWN BY	Mariyam Leevan Jaleel
CHECKED BY	Zunabath Abdul Majid
APPROVED BY	-

PROJECT NAME

**Preparation of Drawings  
for Gn. Fuvahmulah  
Campus (Main Block)**

CLIENT The Maldives National University

DEVELOPER -

ATOLL Gnaviyani Atoll (GN.)

ISLAND Gn. Fuvahmulah

LAGOON (GPS COORDINATES)

ISSUED FOR

BUILDING NAME

**Gn. Fuvahmulah Campus**

BUILDING/STRUCTURE NO.

ISSUE DATE

02/22/23

DRAWING TITLES

**GROUND FLOOR FLOOR  
FINISHES PLAN**

SHEET SIZE A2

SCALE

SHEET NO.

**A116**

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① FIRST FLOOR, FLOOR FINISHES PLAN  
1 : 100

Ministry of National Planning, Housing & Infrastructure  
**ACCREDITED CHECKER**  
ARCHITECTURAL CHECKER B1  
Name: Zunabath Abdul Majid VALIDITY: 22.03.22 - 22.09.23  
Accredited No: BPR2022044B1 01-2022-044-001

Ministry of National Planning, Housing & Infrastructure  
**ACCREDITED CHECKER**  
STRUCTURAL CHECKER A1  
Name: Mohamed Muhiyiddin Waleed VALIDITY: 23.03.22 - 22.09.23  
Accredited No: BPR2022042A1 A1-2022-042-001

LEGEND

CODE	DESCRIPTION
	35mm NORMAL SCREEDING WITH 2.5mm SELF LEVELLING CEMENT WITH EPOXY FLOOR PAINT (2 COATS OF EPOXY)
	600X600mm HOMOGENOUS NON-SLIP TILES OVER 25mm SCREEDING

NOTE: STAIRCASE TO HAVE HOMOGENOUS NON-SLIP TILES OVER 50mm SCREEDING (STEP TILE WITH GROOVE)

CODE	DESCRIPTION
	600X600mm HOMOGENOUS NON-SLIP TILES OVER 50mm SCREEDING
	SELF LEVELLING CEMENT FLOOR SCREED WITH BITUMINOUS WATERPROOFING AGENT

GENERAL NOTES

REVISIONS

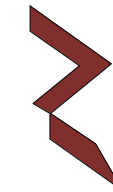
REV. NO.	REV. DATE	REV. DESCRIPTION	REV. BY	CHK. BY

CONSULTANT

LEAD CONSULTANT

LANDSCAPE DESIGN

REGISTERED LOCAL CONSULTANT



RYAN PRIVATE LIMITED

www.ryan.com.mv

CONSULTANT PROJECT NO: R21323MNU

ARCHITECT	Mariyam Irasha Shareef
CIVIL ENGINEER	Zainal Abidheen
MEP ENGINEER	-
INT. DESIGNER	-
INFRA. DESIGNER	-
DRAWN BY	Mariyam Leevan Jaleel
CHECKED BY	Zunabath Abdul Majid
APPROVED BY	-

PROJECT NAME

**Preparation of Drawings  
for Gn. Fuvahmulah  
Campus (Main Block)**

CLIENT The Maldives National University

DEVELOPER -

ATOLL Gnaviyani Atoll (GNL)

ISLAND Gn. Fuvahmulah

LAGOON (GPS COORDINATES)

ISSUED FOR

BUILDING NAME

**Gn. Fuvahmulah Campus**

BUILDING/STRUCTURE NO.

ISSUE DATE

02/22/23

DRAWING TITLES

**FIRST FLOOR FLOOR  
FINISHES PLAN**

SHEET SIZE A2

SCALE

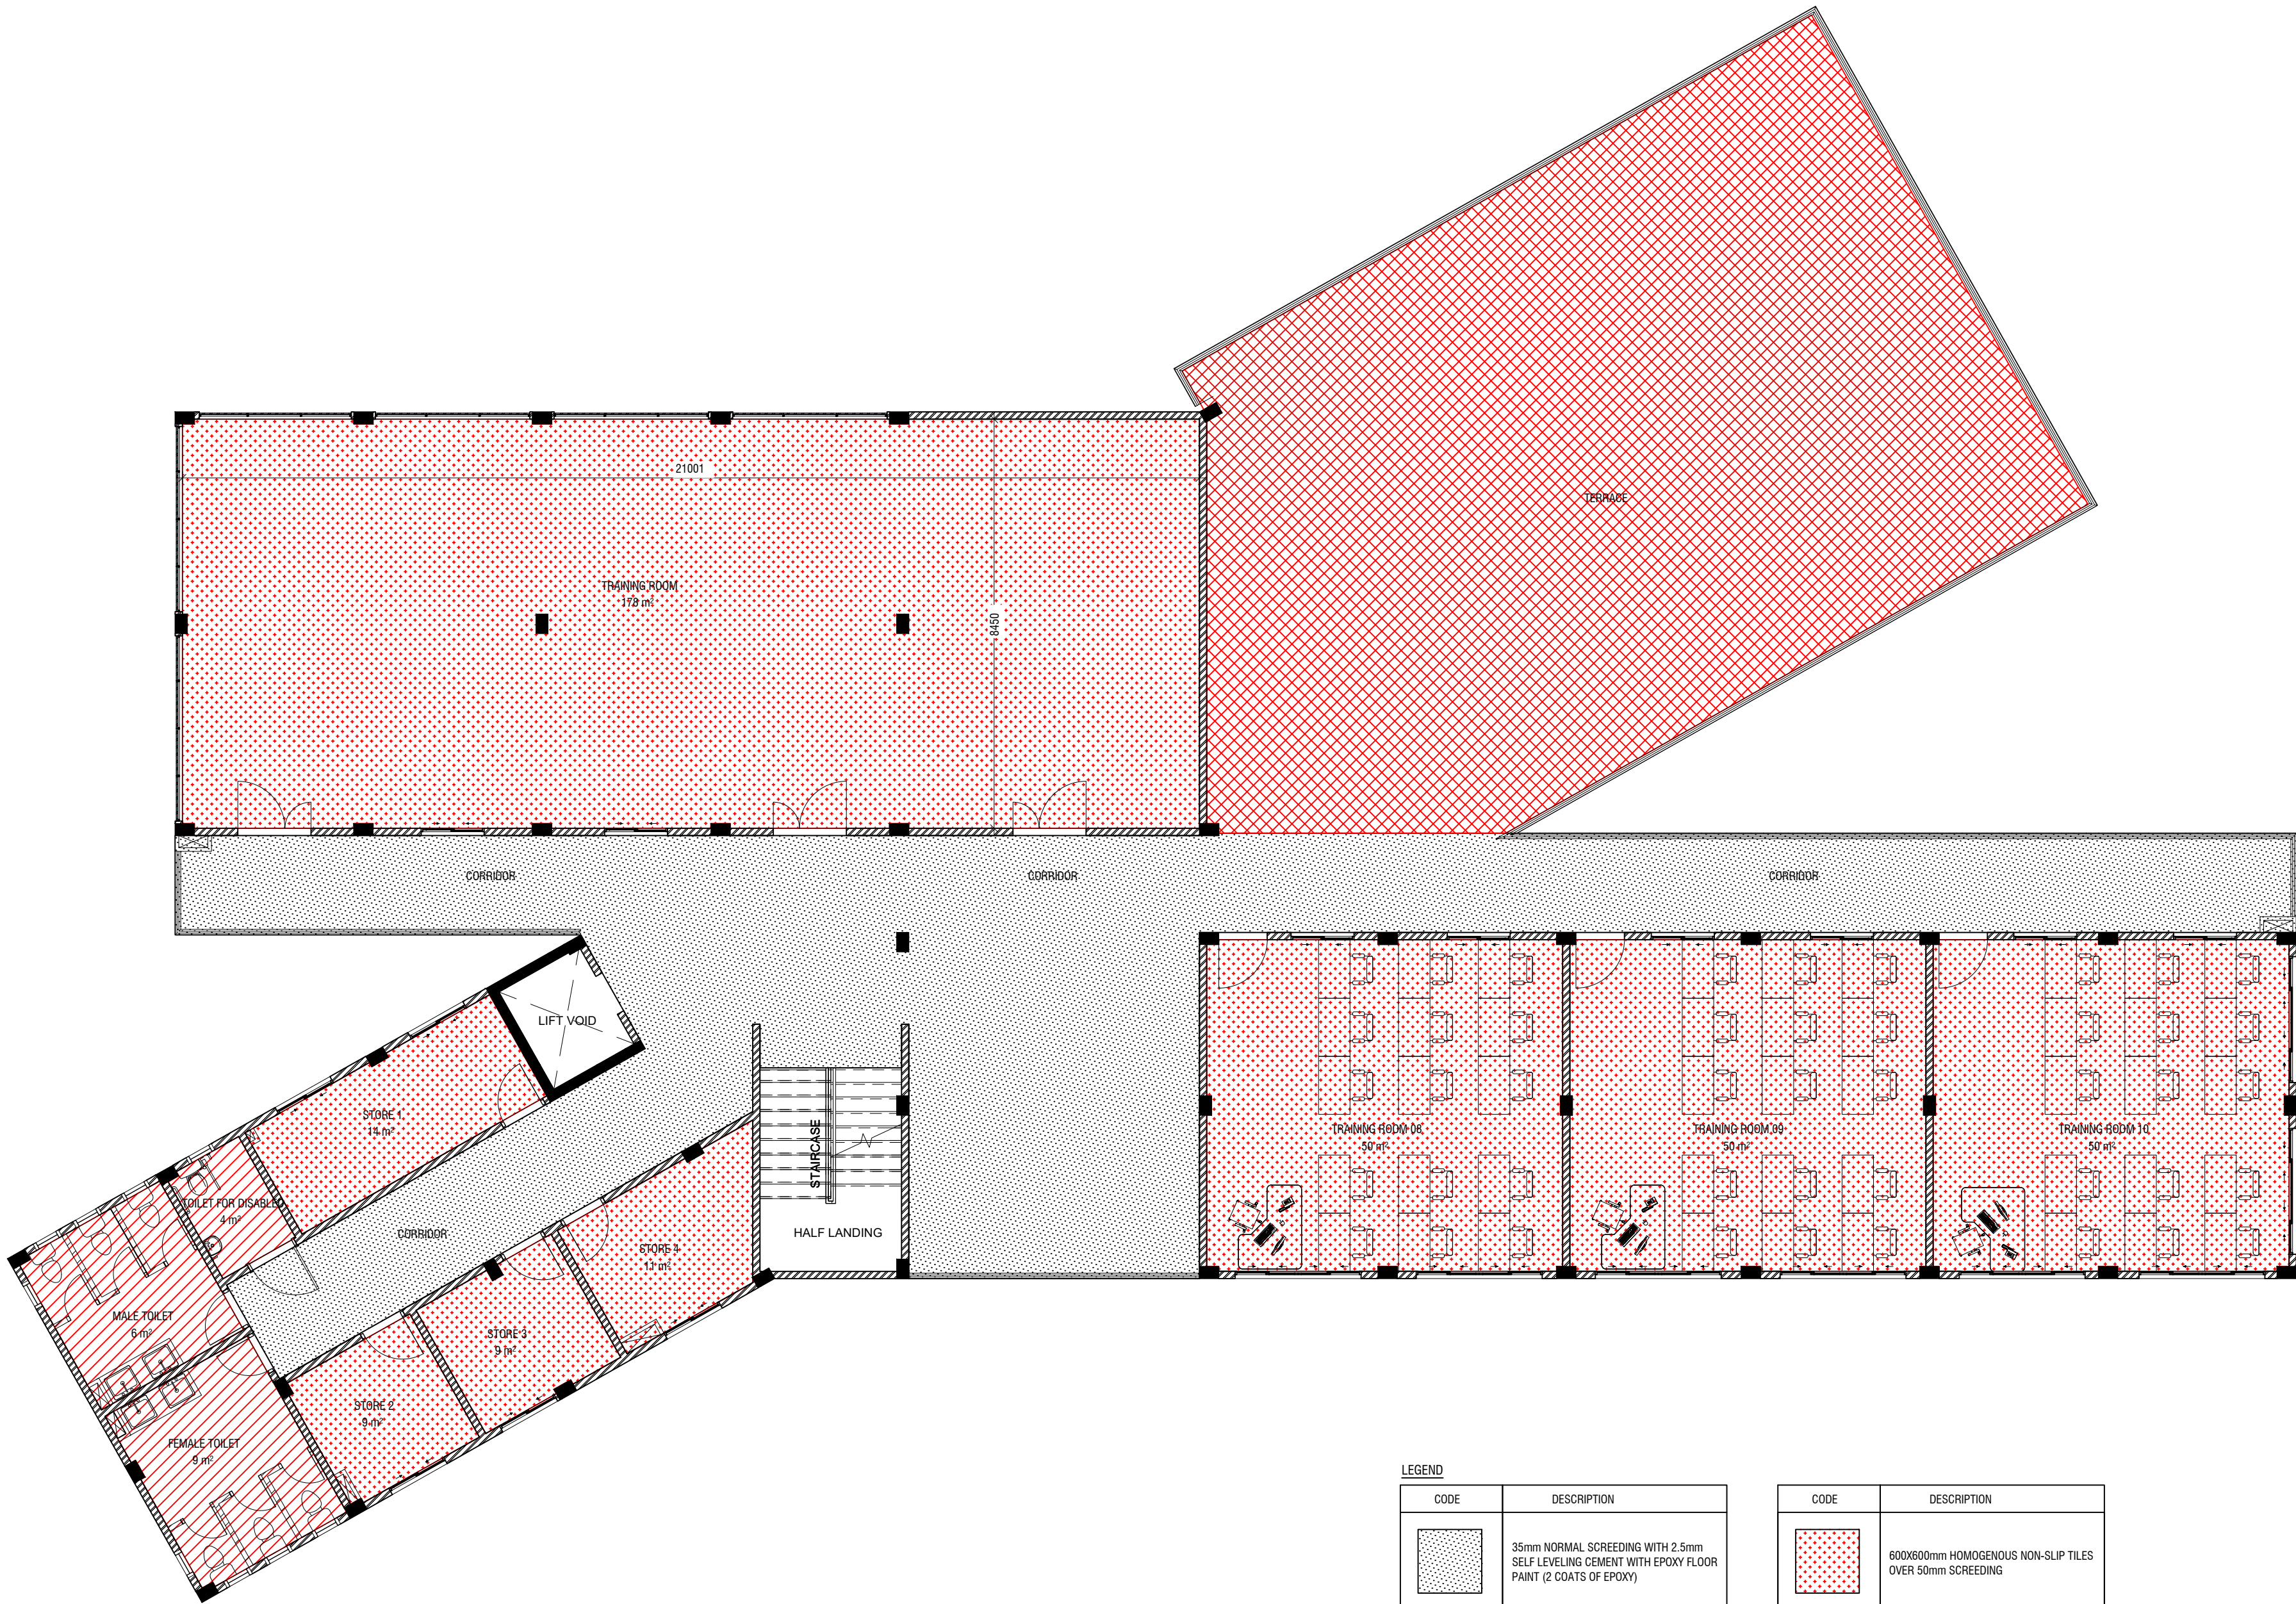
SHEET NO.

**A117**

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① SECOND FLOOR, FLOOR FINISHES PLAN  
1 : 100



Ministry of National Planning, Housing & Infrastructure  
**ACCREDITED CHECKER**  
**ARCHITECTURAL CHECKER B1**  
Name: Zunabath Abdul Majid    VALIDITY: 22.03.22 - 22.09.23  
Accredited No: BPR2022044B1    B1-2022-044-001

Ministry of National Planning, Housing & Infrastructure  
**ACCREDITED CHECKER**  
**STRUCTURAL CHECKER A1**  
Name: Mohamed Muhiathab Waheed    VALIDITY: 23.03.22 - 22.09.23  
Accredited No: BPR2022042A1    A1-2022-042-001

LEGEND

CODE	DESCRIPTION
	35mm NORMAL SCREEDING WITH 2.5mm SELF LEVELING CEMENT WITH EPOXY FLOOR PAINT (2 COATS OF EPOXY)
	600X600mm HOMOGENOUS NON-SLIP TILES OVER 25mm SCREEDING

NOTE: STAIRCASE TO HAVE HOMOGENOUS NON-SLIP TILES OVER 50mm SCREEDING (STEP TILE WITH GROOVE)

CODE	DESCRIPTION
	600X600mm HOMOGENOUS NON-SLIP TILES OVER 50mm SCREEDING
	SELF LEVELLING CEMENT FLOOR SCREED WITH BITUMINOUS WATERPROOFING AGENT

GENERAL NOTES

REVISIONS

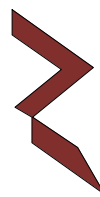
REV. NO.	REV. DATE	REV. DESCRIPTION	REV. BY	CHK. BY

CONSULTANT

LEAD CONSULTANT

LANDSCAPE DESIGN

REGISTERED LOCAL CONSULTANT



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CONSULTANT PROJECT NO. R21323MNU

ARCHITECT	Mariyam Irasha Shareef
CIVIL ENGINEER	Zainal Abiddeen
MEP ENGINEER	-
INT. DESIGNER	-
INFRA DESIGNER	-
DRAWN BY	Mariyam Leevan Jaleel
CHECKED BY	Zunabath Abdul Majid
APPROVED BY	-

PROJECT NAME

**Preparation of Drawings  
for Gn. Fuvahmulah  
Campus (Main Block)**

CLIENT The Maldives National University

DEVELOPER -

ATOLL Gnaviyani Atoll (GN.)

ISLAND Gn. Fuvahmulah

LAGOON (GPS COORDINATES)

ISSUED FOR

BUILDING NAME

**Gn. Fuvahmulah Campus**

BUILDING/STRUCTURE NO.

ISSUE DATE

02/22/23

DRAWING TITLES

**SECOND FLOOR FLOOR  
FINISHES PLAN**

SHEET SIZE A2

SCALE

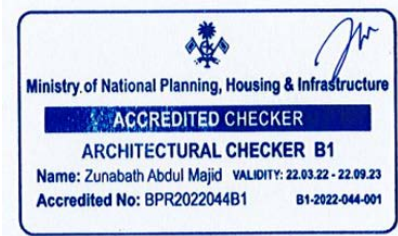
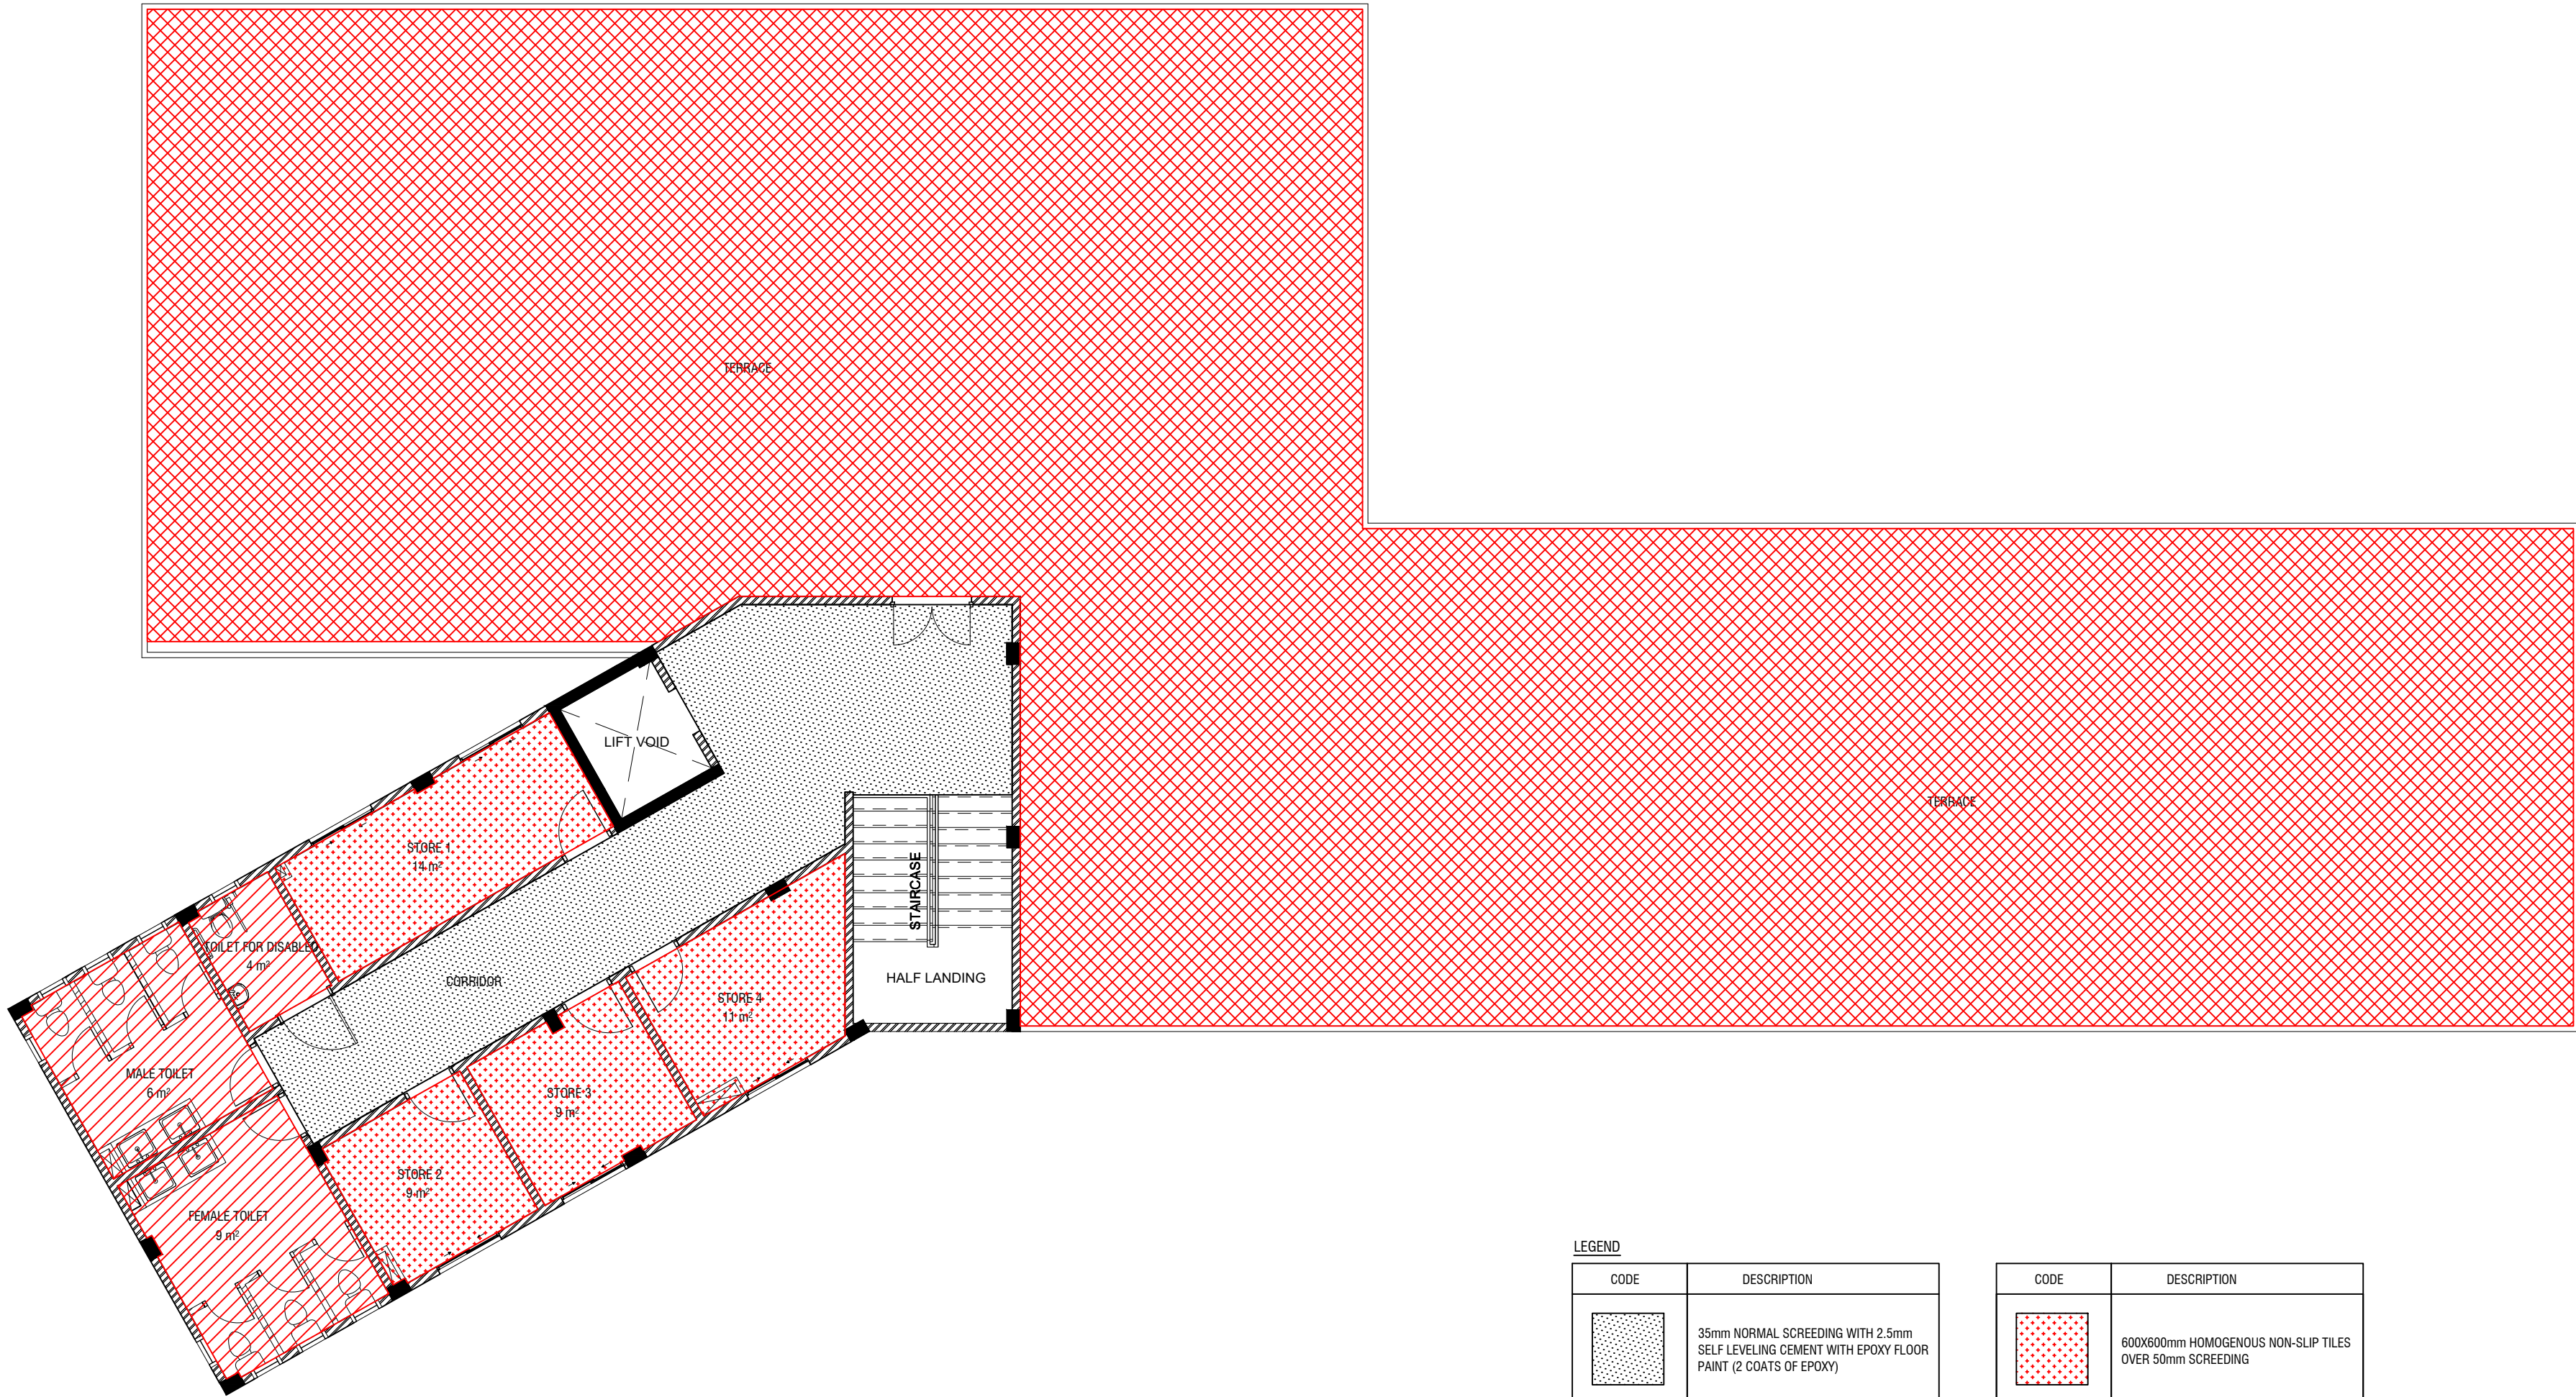
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**A118**

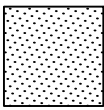
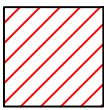
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
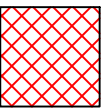
① TERRACE FLOOR, FLOOR FINISHES PLAN  
1 : 100



LEGEND

CODE	DESCRIPTION
	35mm NORMAL SCREEDING WITH 2.5mm SELF LEVELING CEMENT WITH EPOXY FLOOR PAINT (2 COATS OF EPOXY)
	600X600mm HOMOGENOUS NON-SLIP TILES OVER 25mm SCREEDING

NOTE: STAIRCASE TO HAVE HOMOGENOUS NON-SLIP TILES OVER 50mm SCREEDING (STEP TILE WITH GROOVE)

CODE	DESCRIPTION
	600X600mm HOMOGENOUS NON-SLIP TILES OVER 50mm SCREEDING
	SELF LEVELLING CEMENT FLOOR SCREED WITH BITUMINOUS WATERPROOFING AGENT

GENERAL NOTES

REVISIONS

REV. NO.	REV. DATE	REV. DESCRIPTION	REV. BY	CHK. BY

CONSULTANT

LEAD CONSULTANT

LANDSCAPE DESIGN

REGISTERED LOCAL CONSULTANT



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CONSULTANT PROJECT NO. R21323MNU

ARCHITECT Mariyam Irasha Shareef

CIVIL ENGINEER Zainal Abidheem

MEP ENGINEER -

INT. DESIGNER -

INFRA DESIGNER -

DRAWN BY Mariyam Leevan Jaleel

CHECKED BY Zunabath Abdul Majid

APPROVED BY -

PROJECT NAME

Preparation of Drawings  
for Gn. Fuvahmulah  
Campus (Main Block)

CLIENT The Maldives National University

DEVELOPER -

ATOLL Gnaviyani Atoll (GN.)

ISLAND Gn. Fuvahmulah

LAGOON (GPS COORDINATES)

ISSUED FOR

BUILDING NAME

Gn. Fuvahmulah Campus

BUILDING/STRUCTURE NO.

ISSUE DATE

02/22/23

DRAWING TITLES

TERRACE FLOOR  
FLOOR FINISHES PLAN

SHEET SIZE A2

SCALE



SHEET NO.

A119

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The stamp is from the Ministry of National Planning, Housing & Infrastructure. It features a central emblem with a gear and a sun. Below the emblem, the text reads "ACCREDITED CHECKER" and "STRUCTURAL CHECKER A1". The checker's name is "Mohamed Muhihib Waleed" and the accreditation number is "BPR2022042A1". The validity period is "23.03.22 - 22.09.23". There is a handwritten signature in the top right corner of the stamp.

CODE	DESCRIPTION
	600X600mm HOMOGENOUS NON-SLIP TILES OVER 50mm SCREEDING
	SELF LEVELLING CEMENT FLOOR SCREED WITH BITUMINOUS WATERPROOFING AGENT

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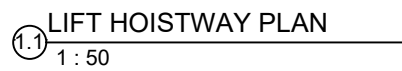


**A121**

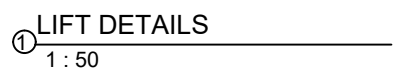
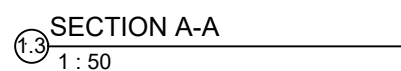
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1.2 ELEVATOR DETAILS  
1 : 50




ARCHITECTURAL DETAILS  
1 : 50



REVISIONS				
REV.NO	REV.DATE	REV.DESCRPTION	REV.BY	CHK.BY

CONSULTANT	
LEAD CONSULTANT	
LANDSCAPE DESIGN	
REGISTERED LOCAL CONSULTANT	
 <b>RIYAN PRIVATE LIMITED</b> <a href="http://www.riyan.com.mv">www.riyan.com.mv</a>	

CONSULTANT PROJECT NO. <b>R21323MNU</b>	
ARCHITECT	<b>Mariyam Irasha Shareef</b>
CIVIL ENGINEER	<b>Zainal Abidheen</b>
MEP ENGINEER	-
INT. DESIGNER	-
INFRA. DESIGNER	-
DRAWN BY	<b>Mariyam Loevan Jaleel</b>
CHECKED BY	<b>Zunabath Abdul Majid</b>
APPROVED BY	-

PROJECT NAME	
<b>Preparation of Drawings for Gn. Fuvahmulah Campus (Main Block)</b>	

CLIENT	<b>The Maldives National University</b>
DEVELOPER	-
ATOLL	<b>Gnaviyani Atoll (GN.)</b>
ISLAND	<b>Gn. Fuvahmulah</b>
LAGOON (GPS COORDINATES)	
ISSUED FOR	

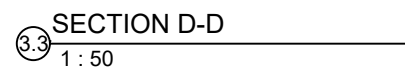
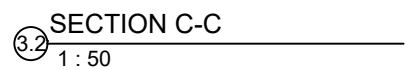
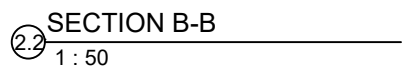
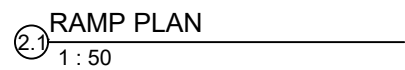
BUILDING NAME	
<b>Gn. Fuvahmulah Campus</b>	

BUILDING/STRUCTURE NO.	ISSUE DATE
	<b>03/01/23</b>

DRAWING TITLES	
<b>ARCHITECTURAL DETAILS</b>	

SHEET SIZE	A2	SCALE
SHEET NO.		
<b>A122</b>		

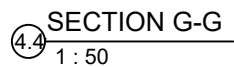
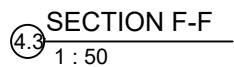
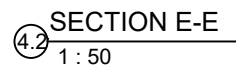
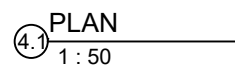
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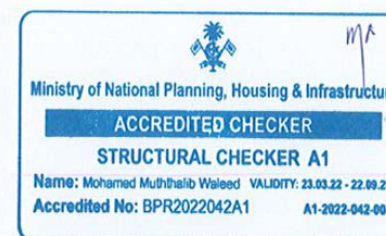
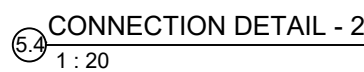
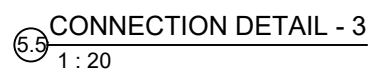
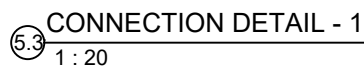
DRAWING TITLES		
<b>ARCHITECTURAL DETAILS</b>		
SHEET SIZE	A2	SCALE
SHEET NO.		
<b>A123</b>		

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④ DISA  
1 : 50



SHEET SIZE	A2	SCALE
SHEET NO.		
<b>A124</b>		

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