



NOTE:
 1. ALL DIMENSIONS ARE IN MILLIMETER
 2. ALL LEVELS SHOWN ARE IN METERS
 3. THIS DRAWING TO BE READ IN CONNECTION WITH ALL RELEVANT DRAWINGS, GENERAL NOTES AND SPECIFICATIONS

LEGEND:
 1.NGL - NATURAL GROUND LEVEL
 2.FFL - FINISHED FLOOR LEVEL
 3.PCC - PLAIN CEMENT CONCRETE
 4.FD - FLOOR DRAIN
 5.GEO - GROUND CLEAN OUT
 6.DWS - COLD WATER SUPPLY

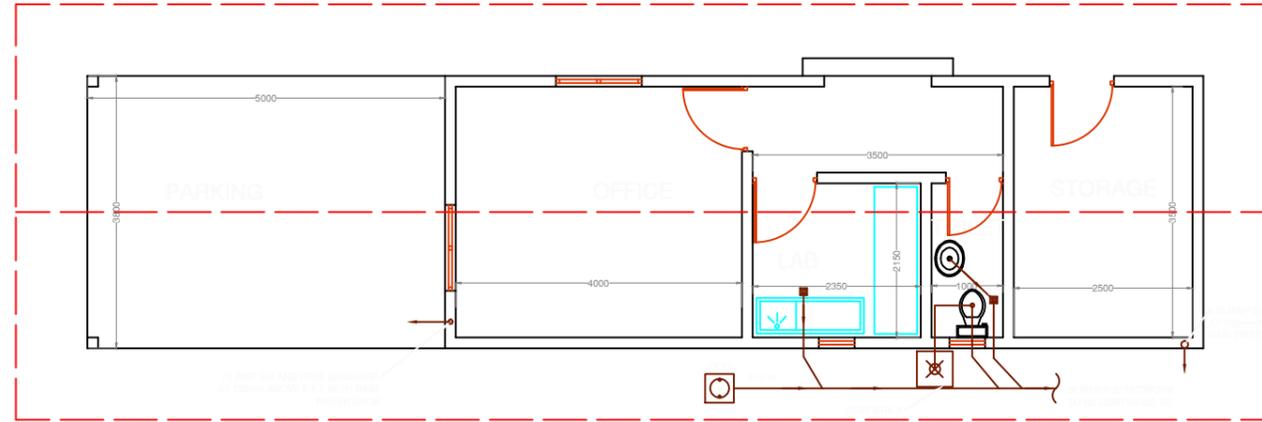

FLOOR PLAN

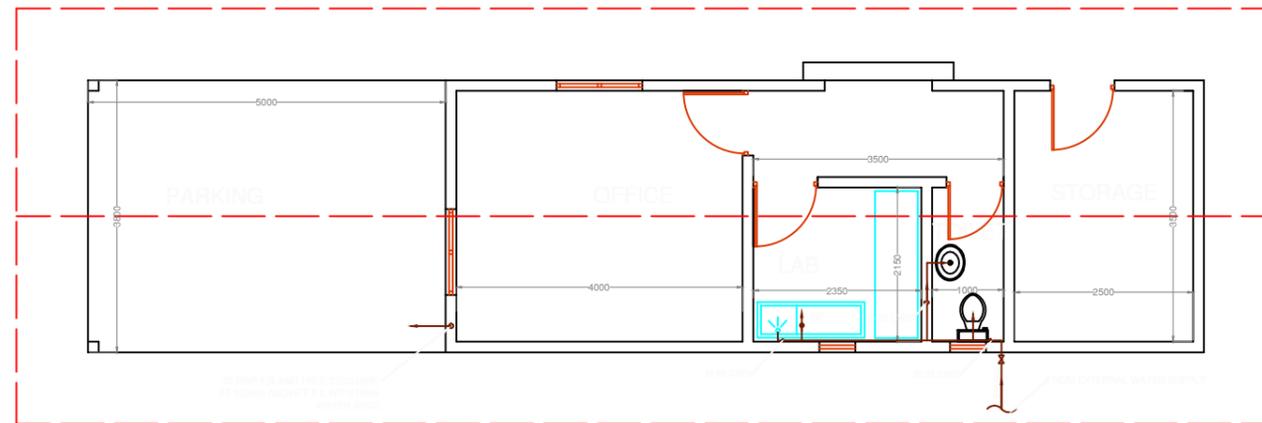

FLOOR PLAN

	<p>CLIENT: MINISTRY OF ENVIRONMENT AND ENERGY</p>	<p>CONSULTANCY SERVICES FOR DESIGN OF WATER SUPPLY FACILITIES IN Ha.HORAFUSHI, Hdh.HANIMAADHOO,Sh.MILANDHOO,R.UNGOOFAARU,Lh.NAIFARU,Dh,KUDAHUVADHOO ,Th.GURAI DHOO AND Ga.VILLINGILI , MALDIVES</p>	<p>DESIGN ENGINEER</p>	<p>DRAWN</p>	<p>CHECKED DESIGN CHIEF</p>	<p>APPROVED</p>	<p>SL.NO</p>	<p>DRWING NO</p>	<p>DESCRIPTION</p>
	<p>GREENTECH CONSULTANTS (Pvt.) Ltd IN ASSOCIATION WITH DEVELOPMENT COLLABORATION PARTNERSHIP (Pvt.) Ltd MALDIVES AND OPTIMUM SOLOUTIONS (Pvt) Ltd, MALDIVES</p>	<p>TITLE: RO PLANT ADMIN BUILDING SEWERAGE AND WATER SUPPLY LAYOUT</p>	<p>DATE</p>	<p>DRG.NO: NAIFARU/ADMIN/05 SCALE: 1:100</p>					