
CUSTOMS BUILDING CUSTOMS, HDH.KULHUDHUFFUSHI, MALDIVES

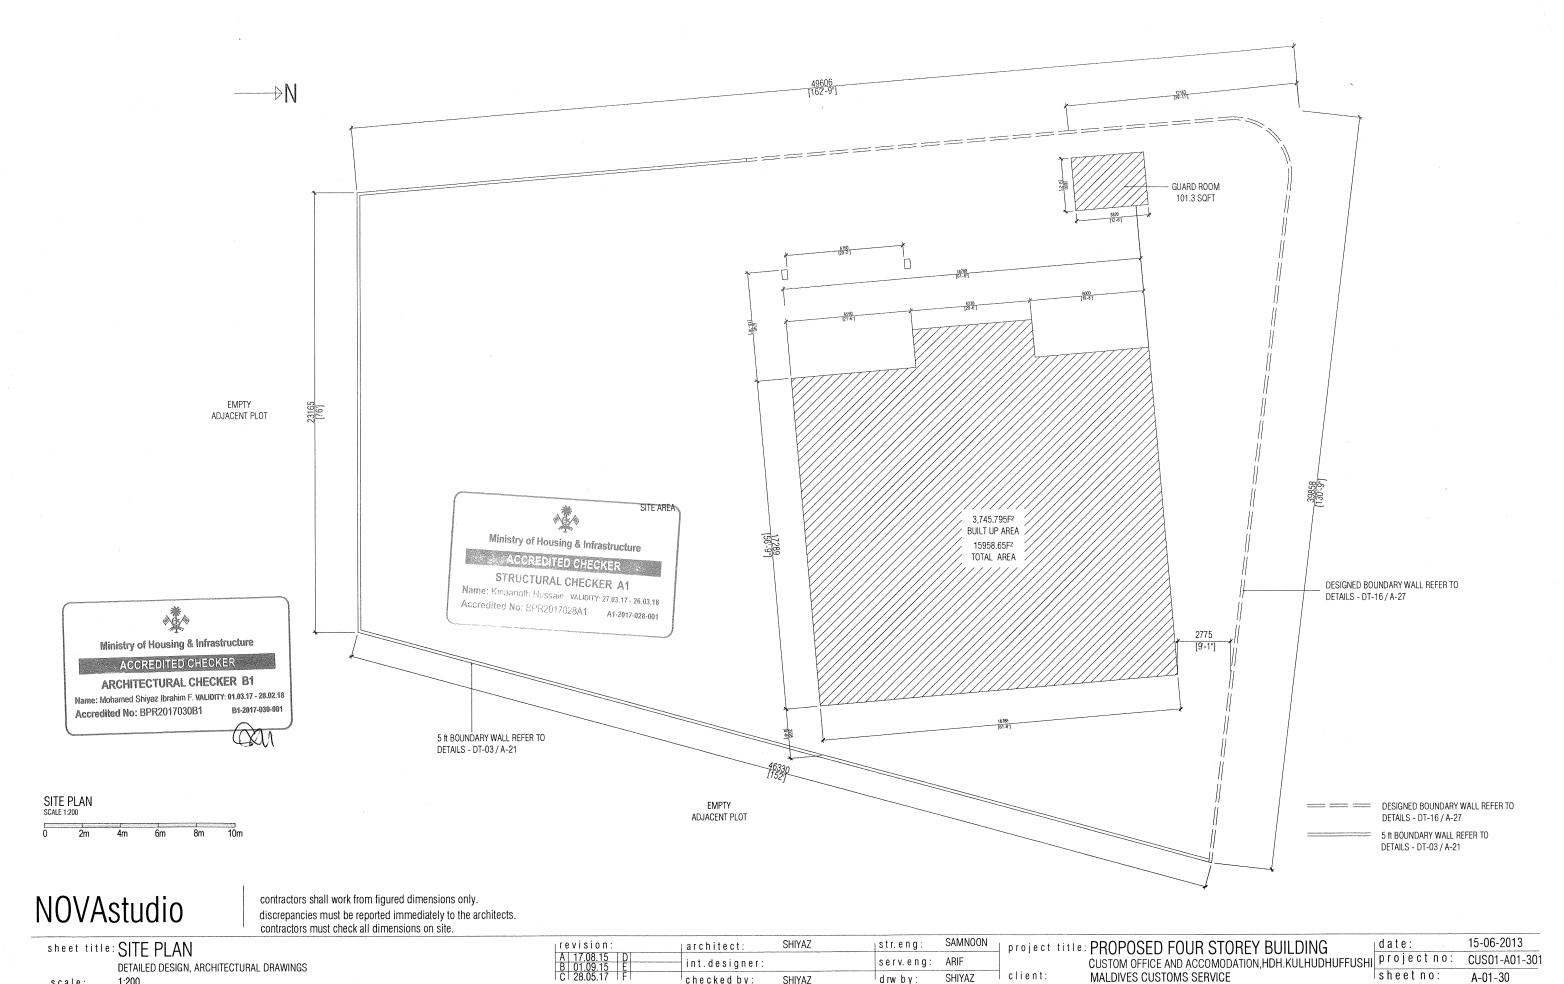

DETAILED DESIGN, ARCHITECTURAL DRAWINGS checked by:

COPYRIGHT: THE CONCEPT AND DESIGN IN THIS DRAWING ARE THE PROPERTIES OF NOVA STUDIO. UNAUTHORIZED USE OF ANY KIND OR COPYING OF WHOLE OR PART OF THIS DRAWING, CONCEPT OR DESIGN IN THIS DRAWING.


SHIYAZ

drw by

MALDIVES CUSTOMS SERVICE

sheet no:

A-01-30

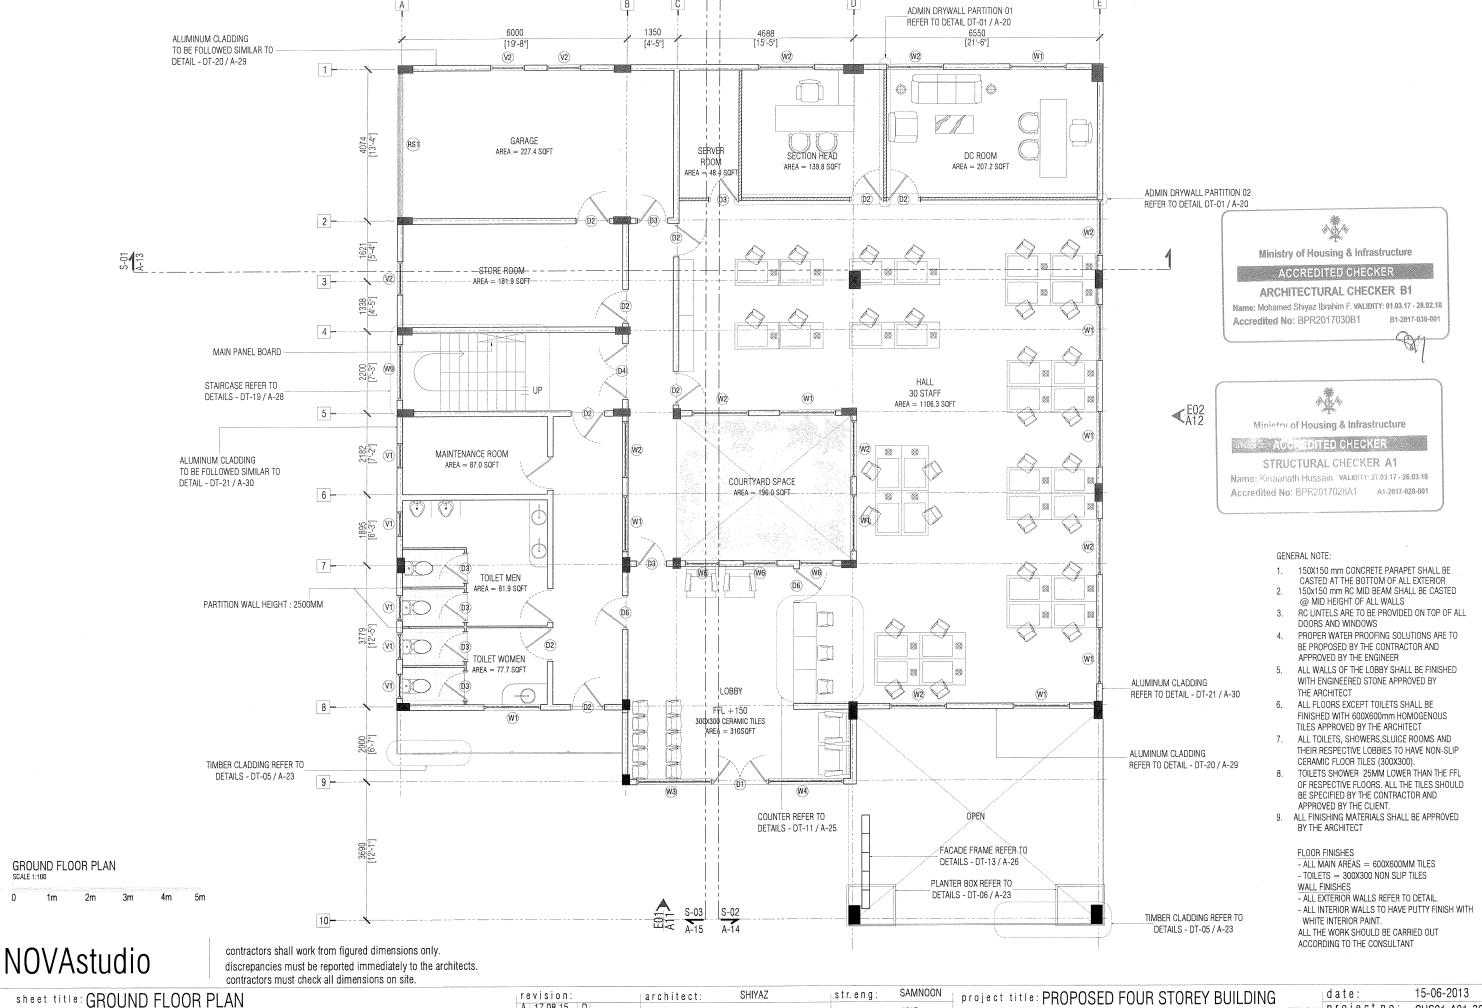


DETAILED DESIGN, ARCHITECTURAL DRAWINGS


scale: 1:100


A 17.08.15 D int.designer: serv.eng: ARIF CUSTOM OFFICE AND ACCOMOD C 28.05.17 F checked by: SHIYAZ drw by: SHIYAZ client: MALDIVES CUSTOMS SERVICE


CUSTOM OFFICE AND ACCOMODATION, HDH. KULHUDHUFFUSHI


date: 15-06-2013 projectno: CUS01-A01-301 sheetno: A-02-30

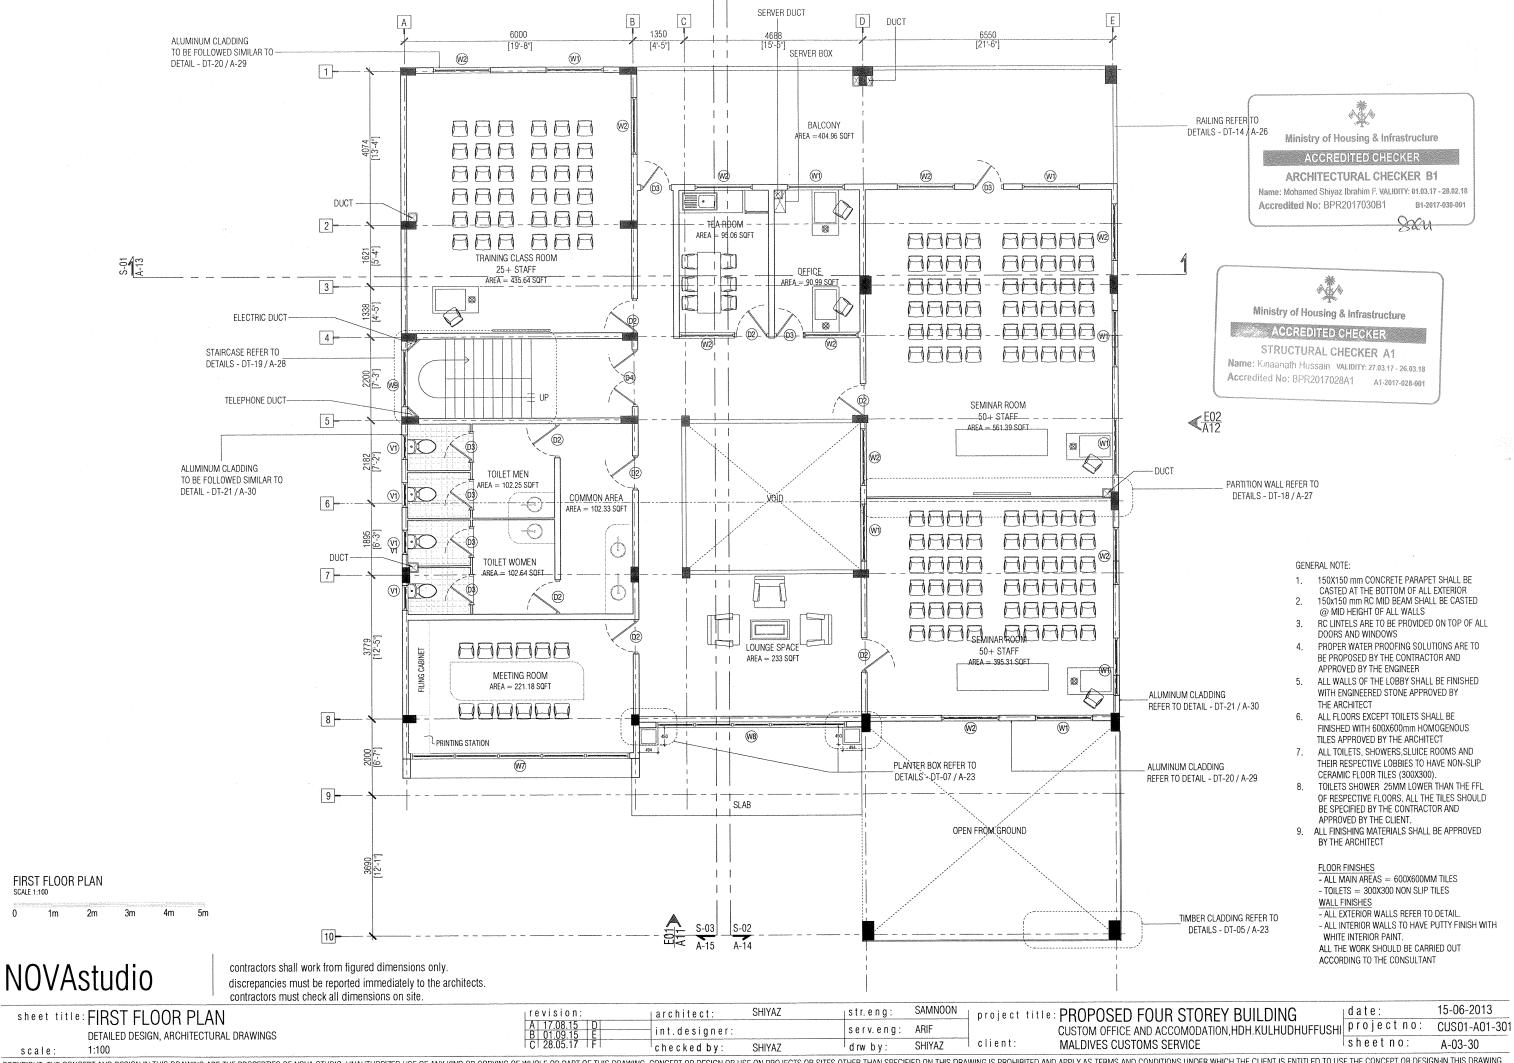

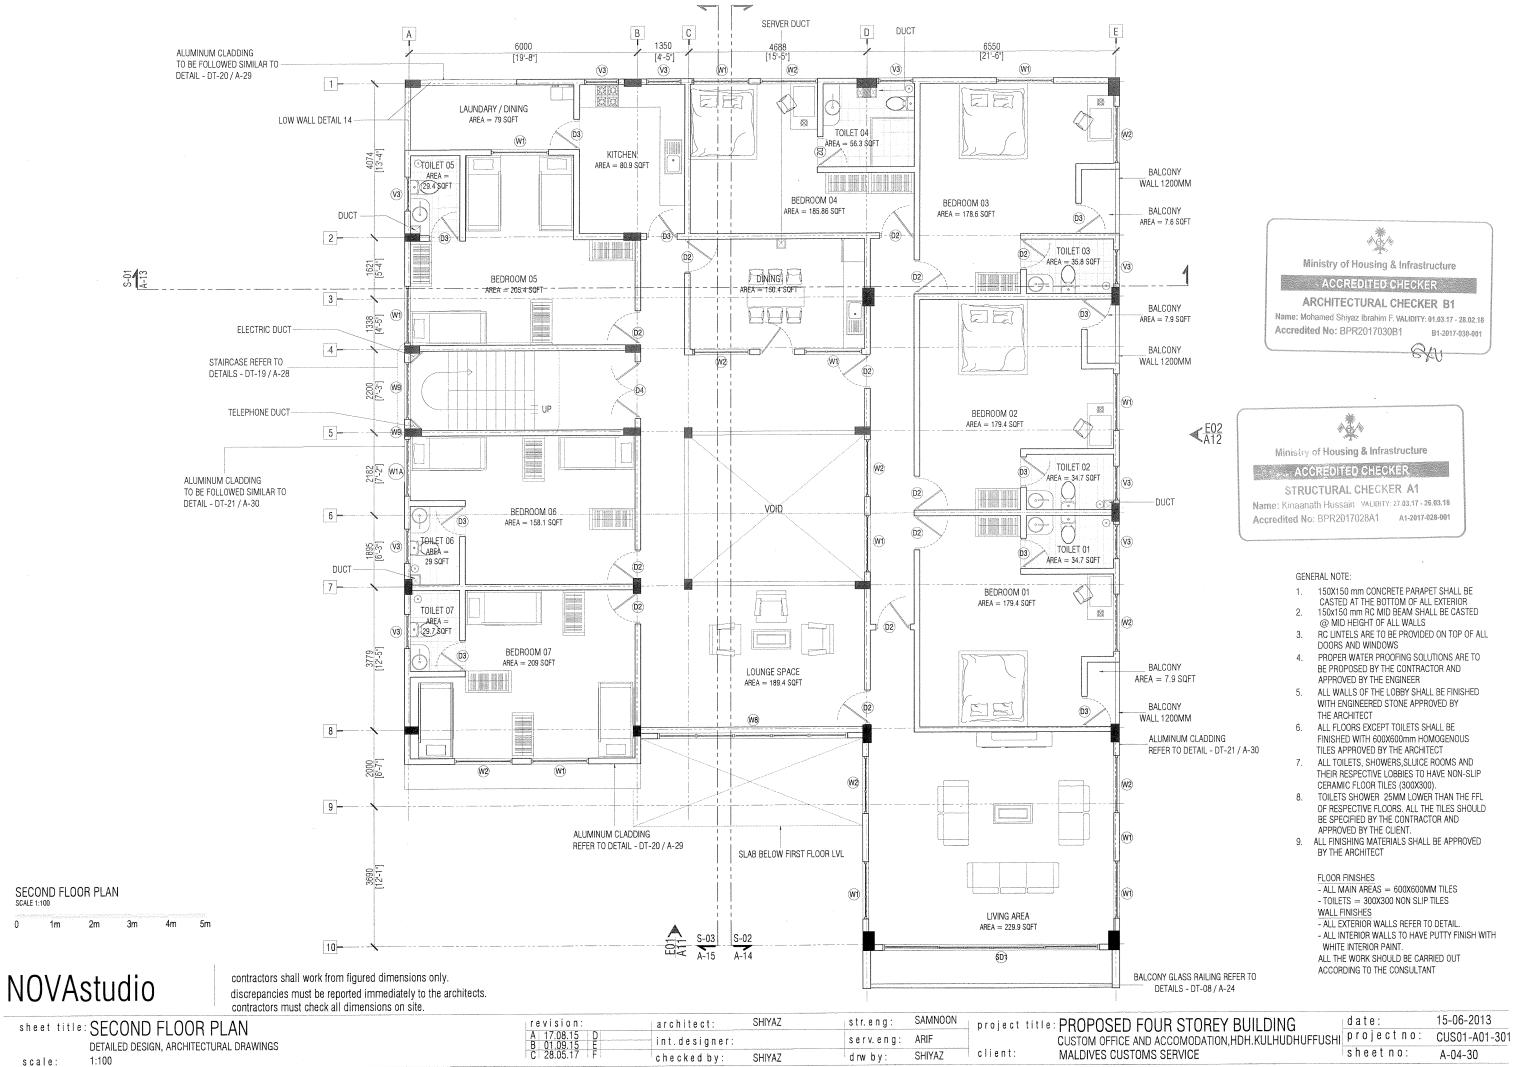

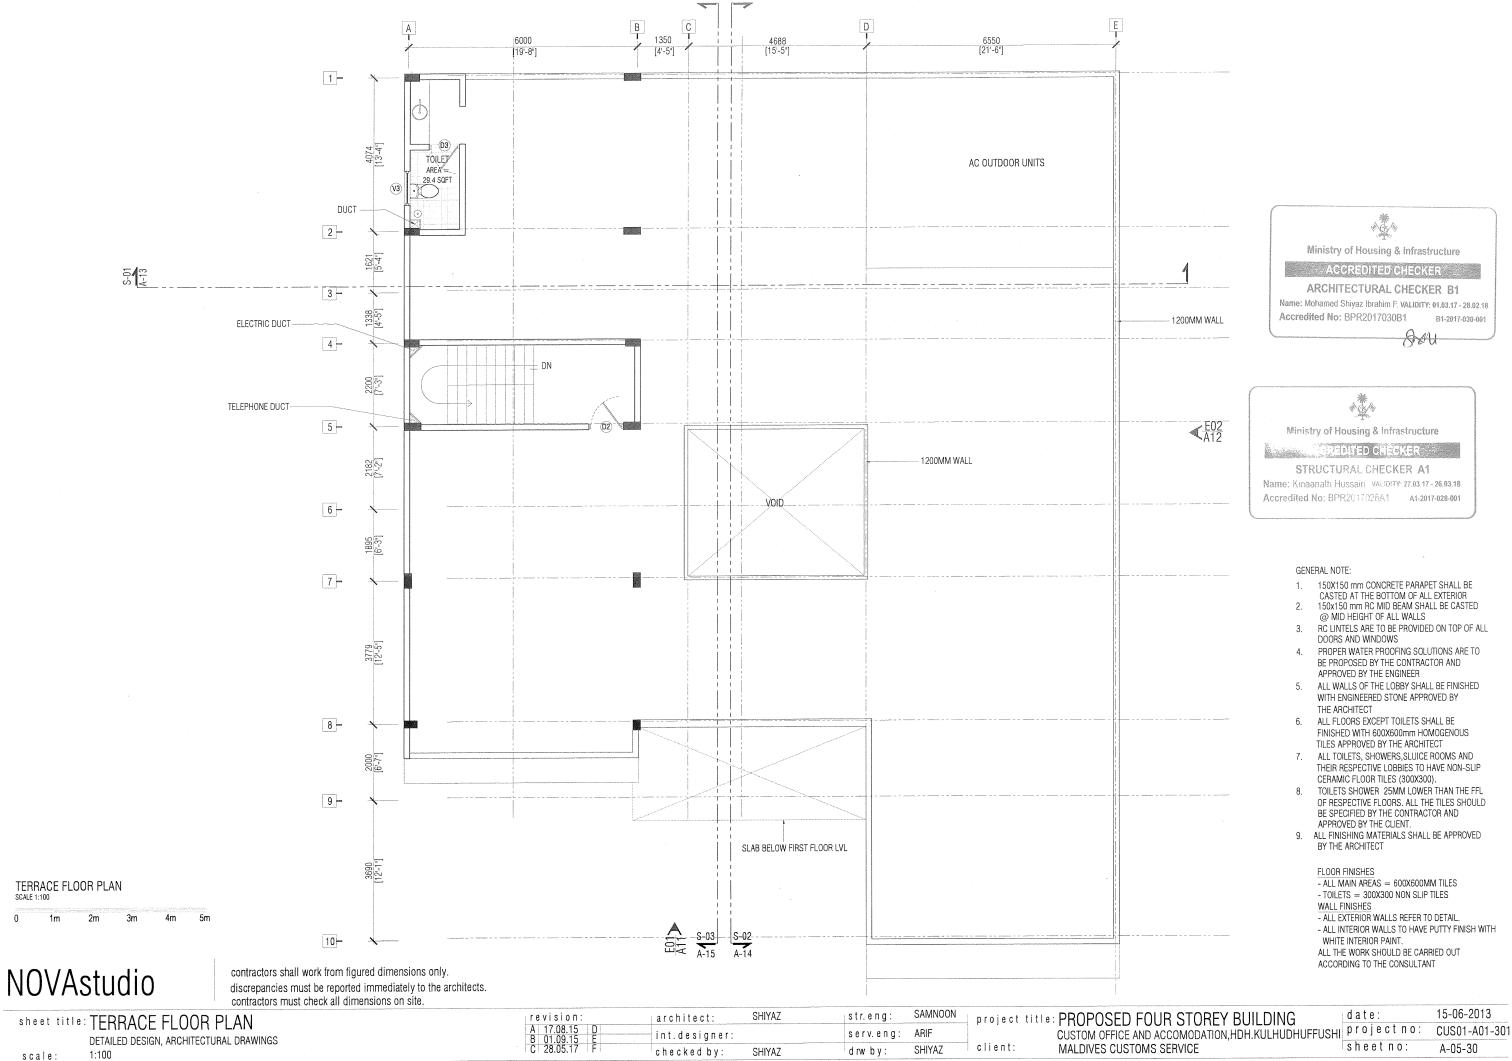

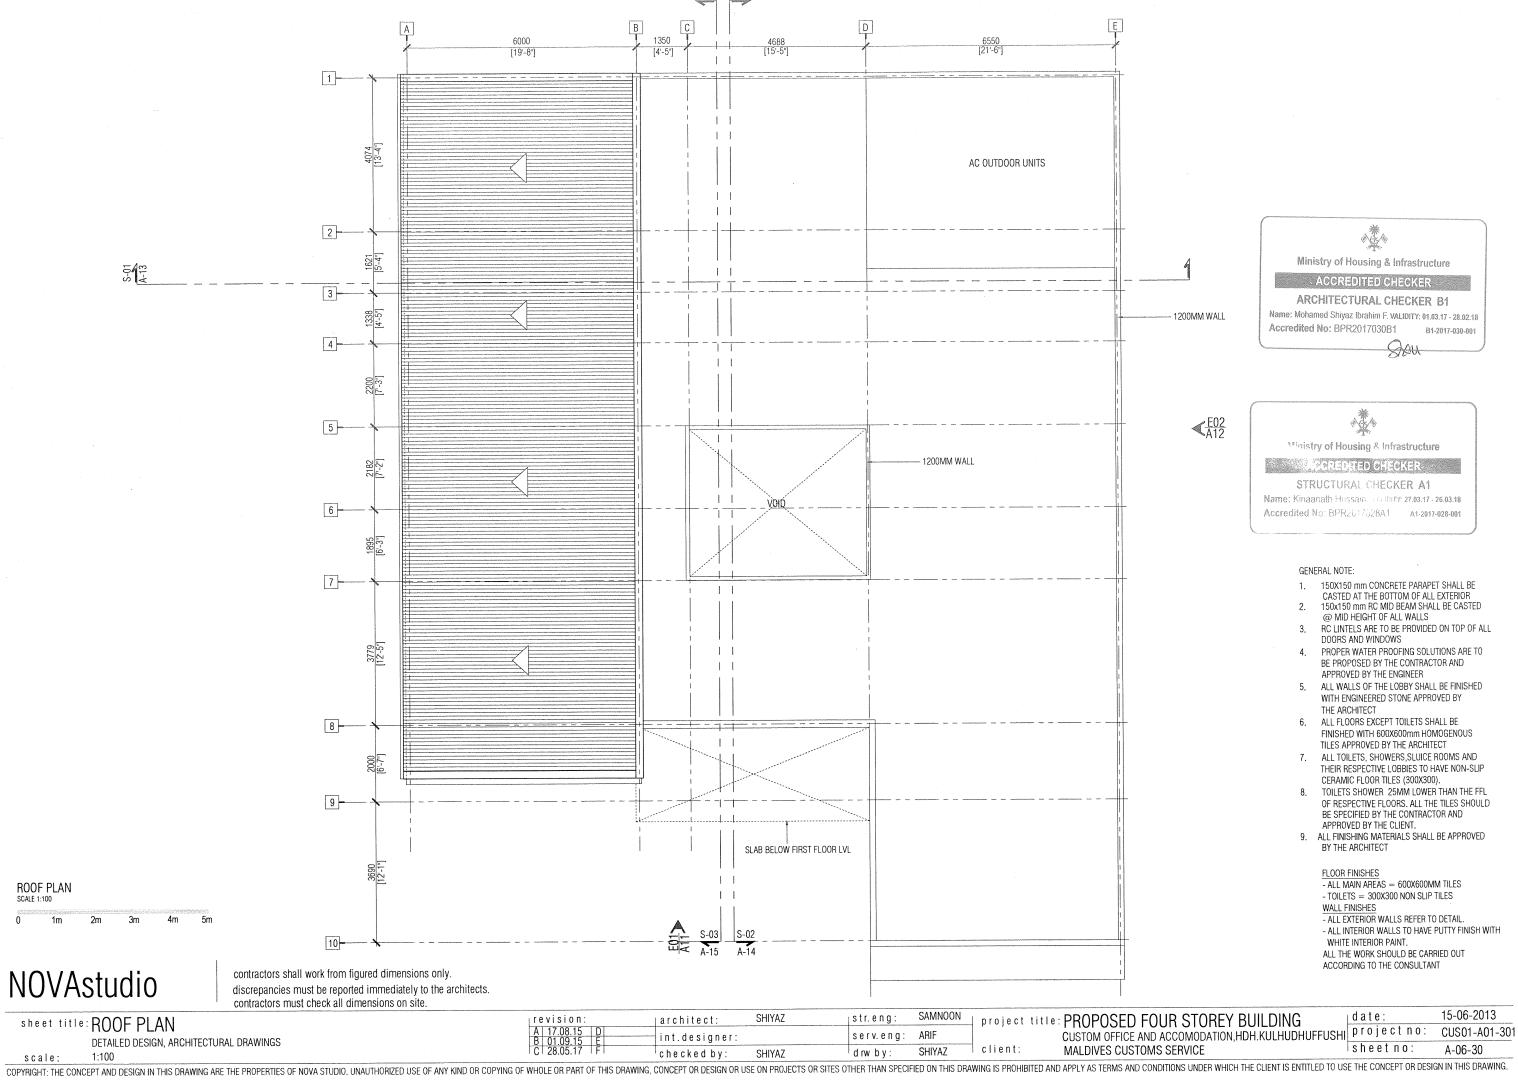

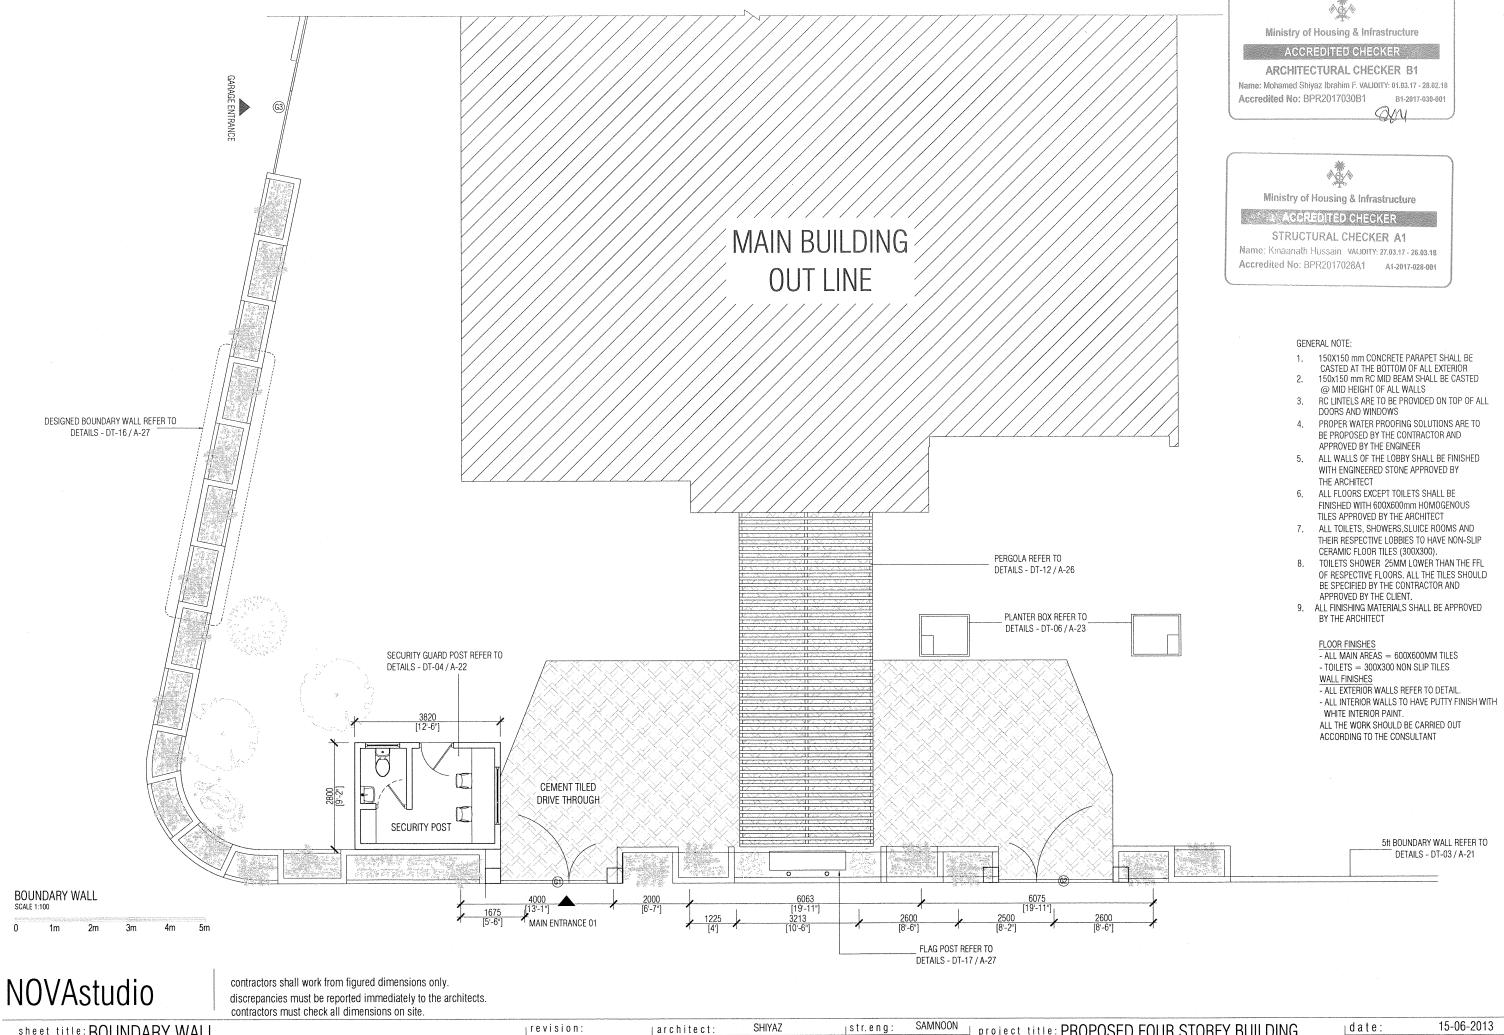


sheet title: BOUNDARY WALL int.designer: serv.eng: DETAILED DESIGN, ARCHITECTURAL DRAWINGS client: SHIYAZ ^ldrwby: SHIYAZ ^lchecked by: scale:

SHIYAZ str.eng:

project title: PROPOSED FOUR STOREY BUILDING CUSTOM OFFICE AND ACCOMODATION, HDH. KULHUDHUFFUSHI project no: MALDIVES CUSTOMS SERVICE

date: CUS01-A01-301 sheet no: A-07-30

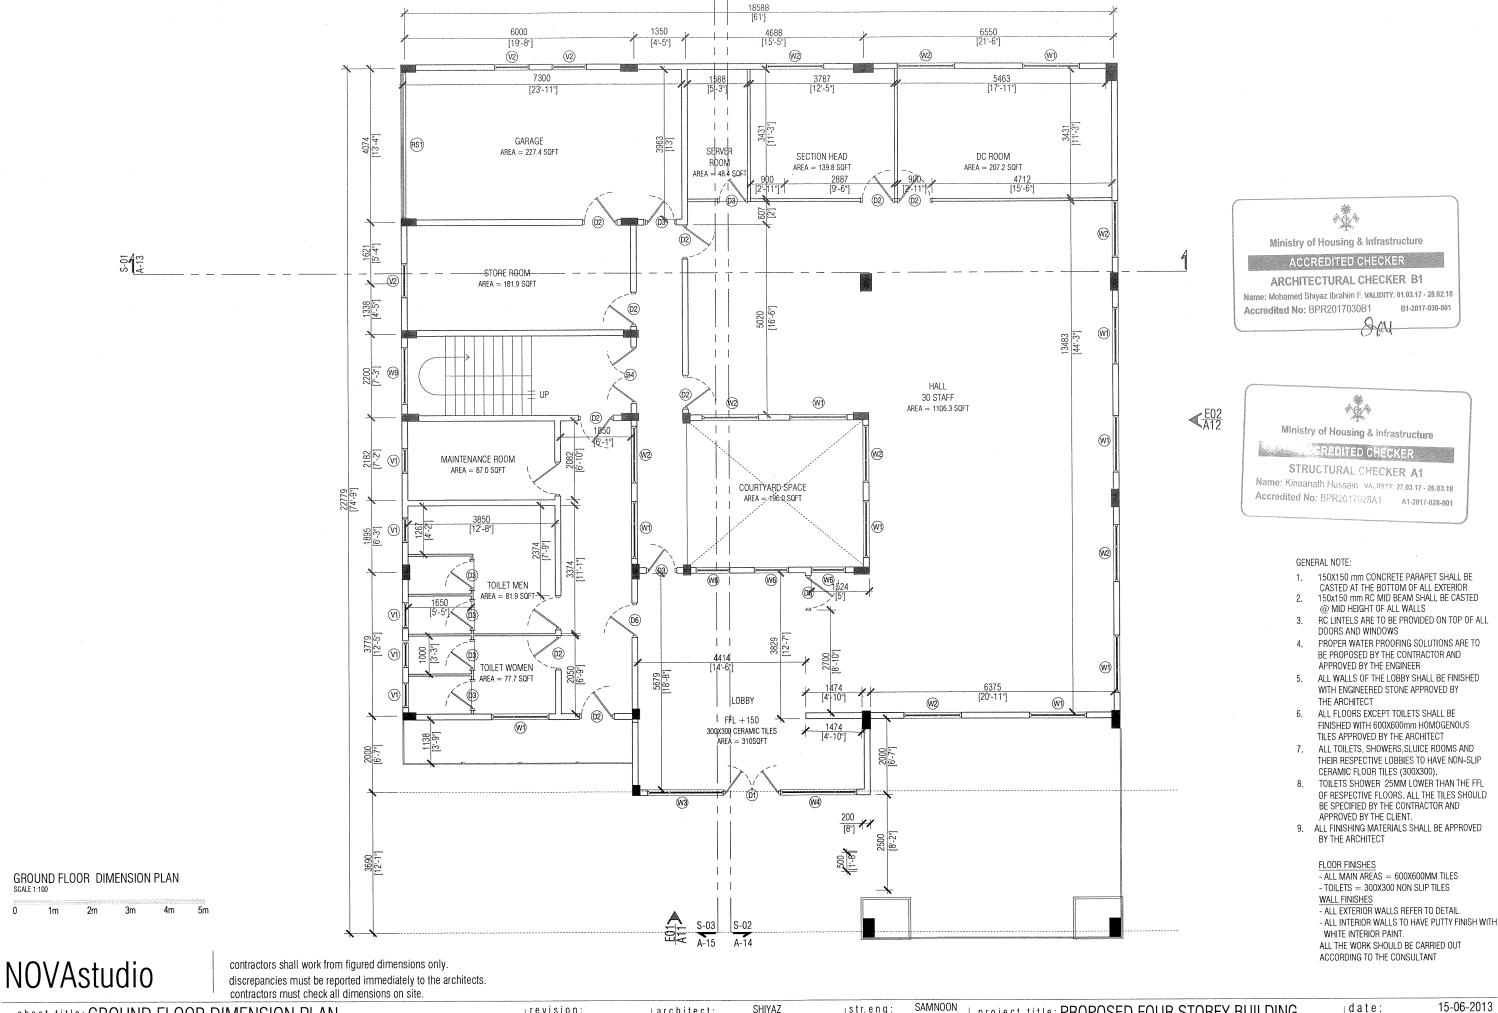

sheet title: GROUND FLOOR DIMENSION PLAN

scale:


DETAILED DESIGN, ARCHITECTURAL DRAWINGS

SHIYAZ str.eng revision architect: serv.eng: int.designer: SHIYAZ drw by checked by: SHIYAZ

project title: PROPOSED FOUR STOREY BUILDING

date: project no: CUS01-A01-301

CUSTOM OFFICE AND ACCOMODATION, HDH. KULHUDHUFFUSH sheet no: MALDIVES CUSTOMS SERVICE

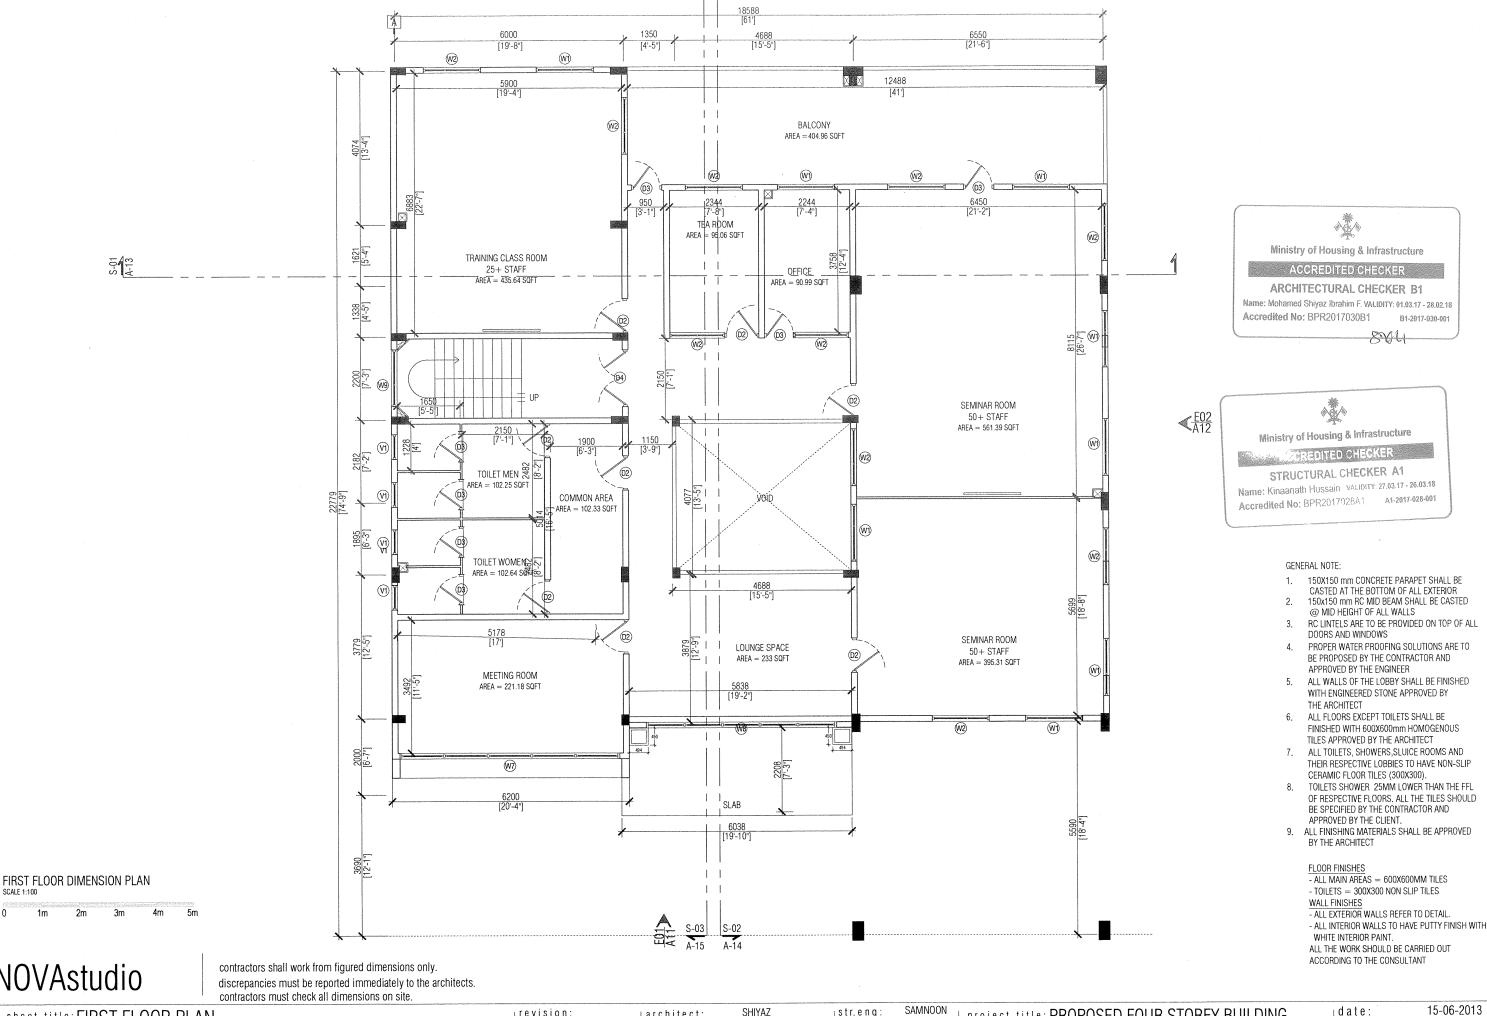


sheet title: FIRST FLOOR PLAN DETAILED DESIGN, ARCHITECTURAL DRAWINGS

revision SHIYAZ str.eng |architect: serv.eng: int.designer: SHIYAZ ^lchecked by: drw by

project title: PROPOSED FOUR STOREY BUILDING CUSTOM OFFICE AND ACCOMODATION, HDH. KULHUDHUFFUSHI Project no: MALDIVES CUSTOMS SERVICE

date: CUS01-A01-301 sheet no:

A-09-30 COPYRIGHT: THE CONCEPT AND DESIGN IN THIS DRAWING ARE THE PROPERTIES OF NOVA STUDIO. UNAUTHORIZED USE OF ANY KIND OR COPYING OF WHOLE OR PART OF THIS DRAWING, CONCEPT OR DESIGN IN THIS DRAWING.

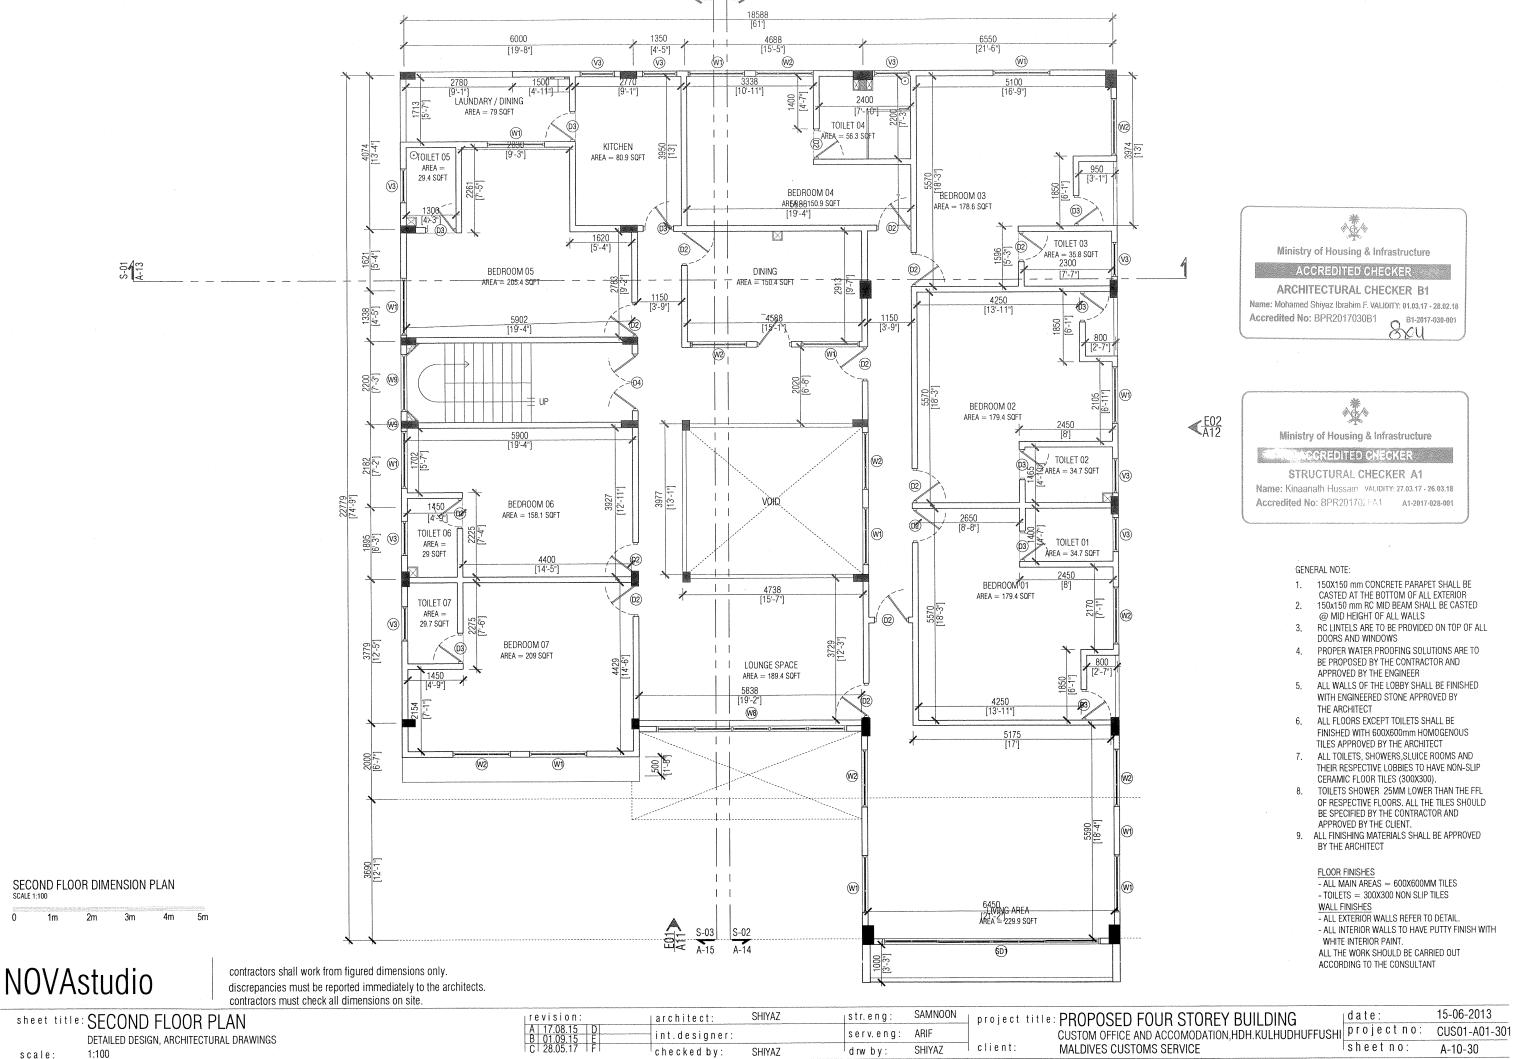

Ministry of Housing & Infrastructure


ACCREDITED CHECKES

ARCHITECTURAL CHECKER B1

Name: Mohamed Shiyaz Ibrahim F. VALIDITY: 01.03.17 - 28.02.18

Accredited No: BPR2017030B1

B1-2017-030-001

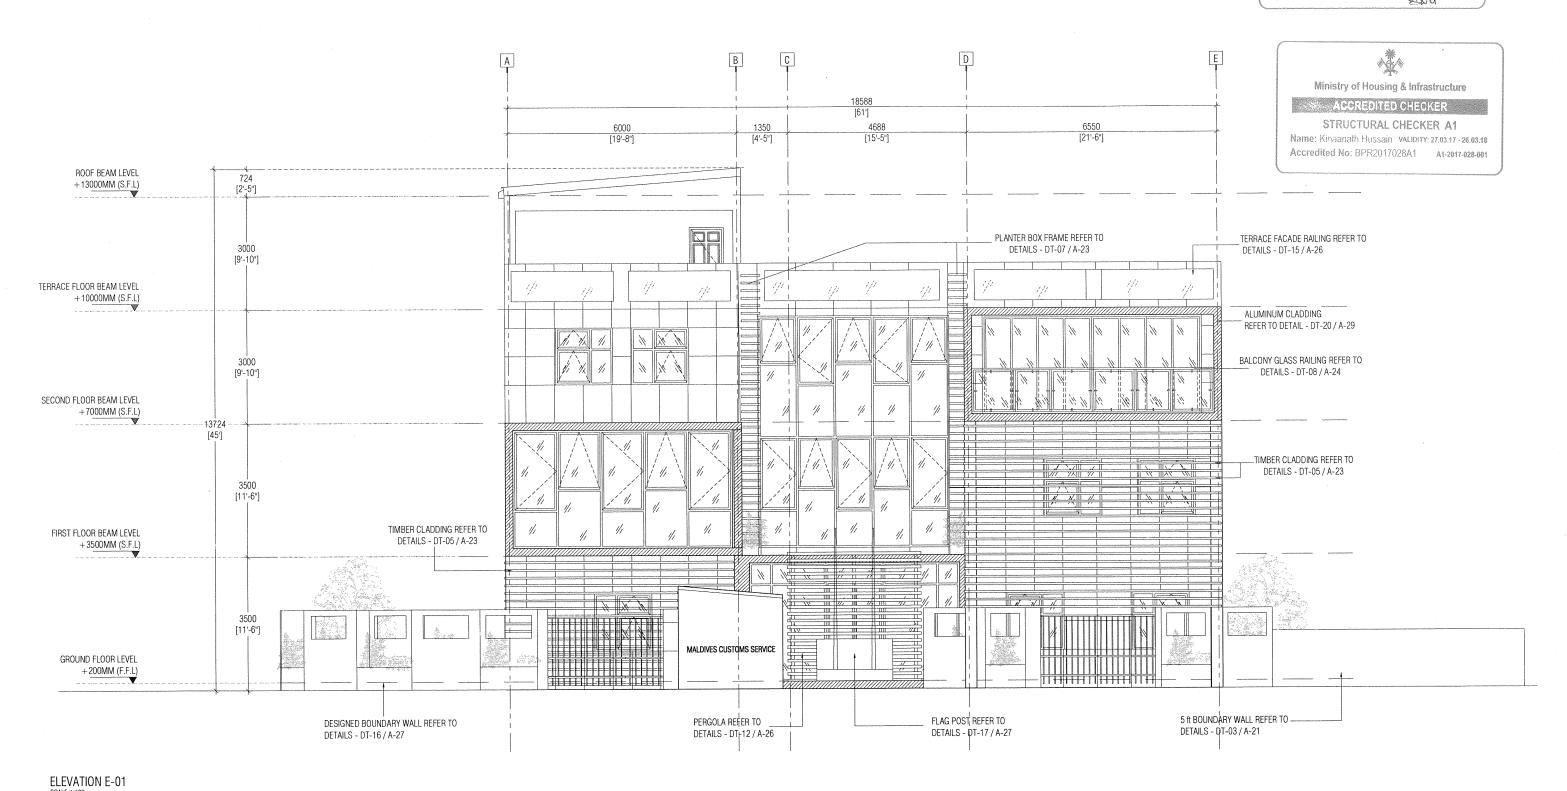

NOVAstudio

contractors shall work from figured dimensions only. discrepancies must be reported immediately to the architects. contractors must check all dimensions on site.


sheet title: ELEVATION

evision:	architect:	SHIYAZ	str.eng:	SAMMOON	project title
17.08.15 D	int.designer:	and the second of the second o	serv.eng:	ARIF	. ,
28.05.17 F	checked by:	SHIYAZ	drw by:	SHIYAZ	client:

Le: PROPOSED FOUR STOREY BUILDING
CUSTOM OFFICE AND ACCOMODATION, HDH. KULHUDHUFFUSHI
MALDIVES CUSTOMS SERVICE

date:
project no:
sheet no:

date: 15-06-2013 project no: CUS01-A01-301 sheet no: A-11-30

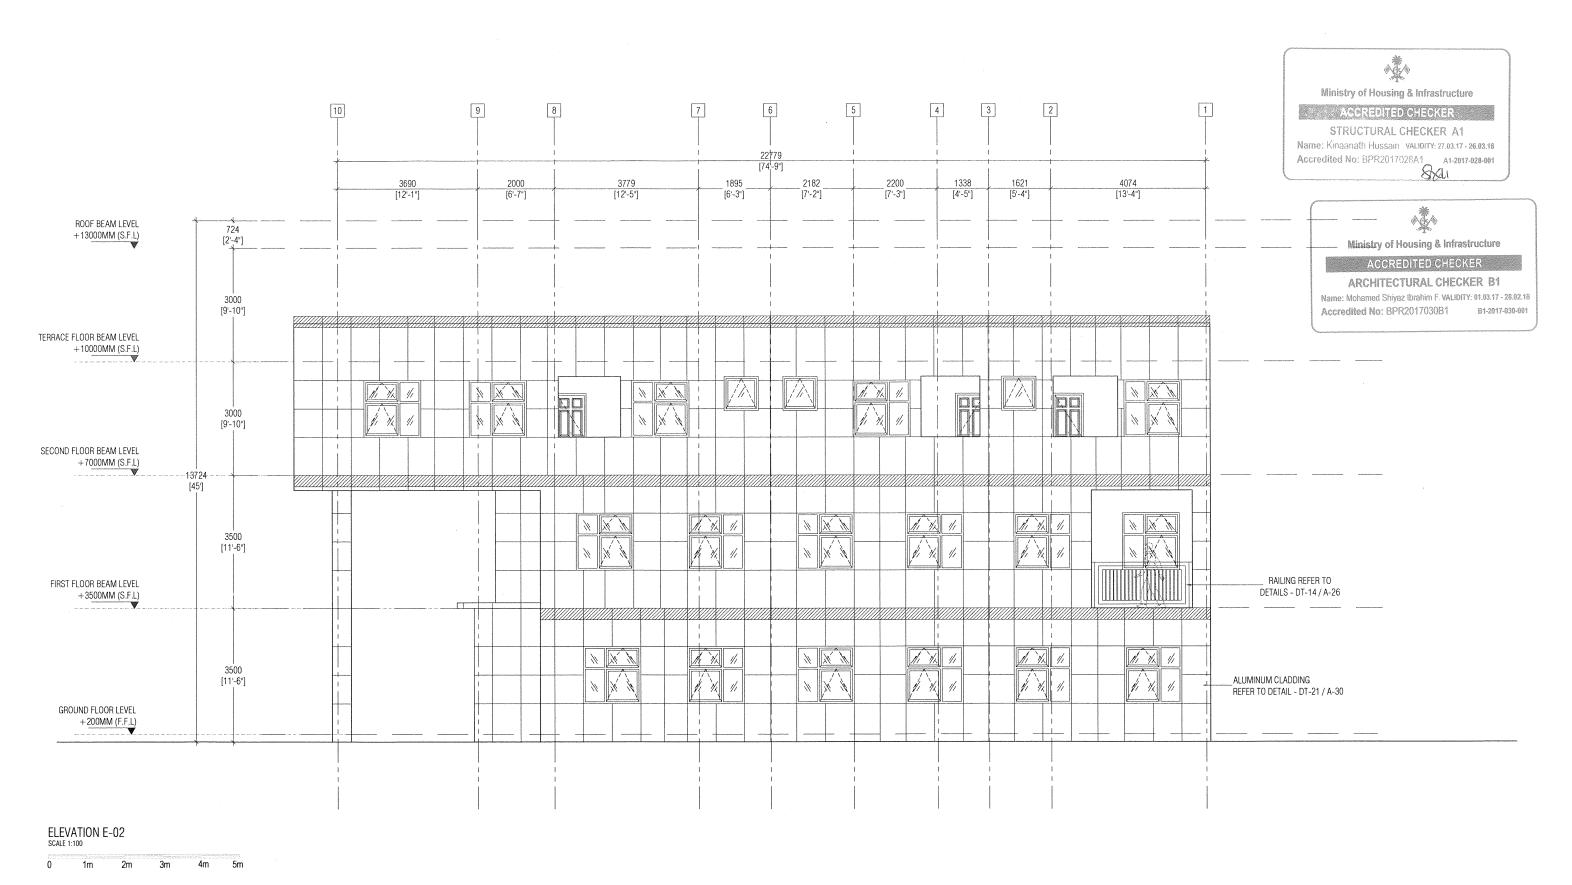


contractors shall work from figured dimensions only. discrepancies must be reported immediately to the architects. contractors must check all dimensions on site.

sheet title: ELEVATION DETAILED DESIGN, ARCHITECTURAL DRAWINGS

1	revision:	architect:	SHIYAZ	str.eng:	SAMNOON	g
F	A 17.08.15 D B 01.09.15 E	int.designer:		serv.eng:	ARIF	
ľ	C 28.05.17 F	checked by:	SHIYAZ	drw by:	SHIYAZ	С

project title: PROPOSED FOUR STOREY BUILDING CUSTOM OFFICE AND ACCOMODATION, HDH. KULHUDHUFFUSHI project no: client: MALDIVES CUSTOMS SERVICE

15-06-2013 |date: CUS01-A01-301 sheet no: A-12-30

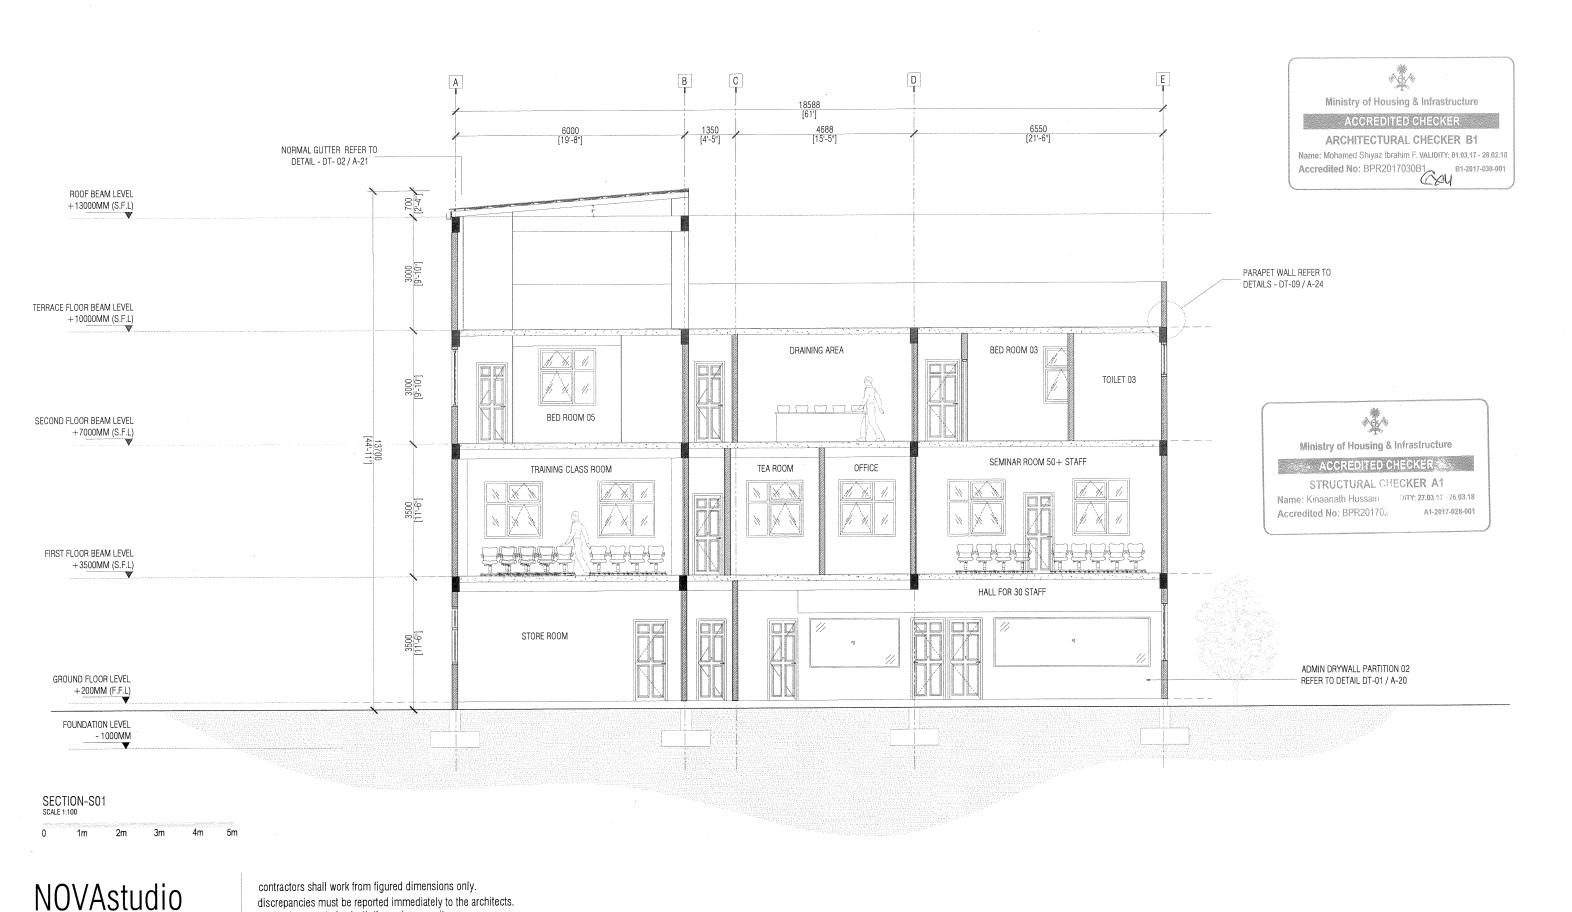

sheet title: SECTION DRAWINGS DETAILED DESIGN, ARCHITECTURAL DRAWINGS

discrepancies must be reported immediately to the architects.


contractors must check all dimensions on site.

SAMNOON revision: str.eng: architect: ARIF serv.eng: int.designer: drw by: checked by:

project title: PROPOSED FOUR STOREY BUILDING CUSTOM OFFICE AND ACCOMODATION, HDH. KULHUDHUFFUSHI project no:

date: 15-06-2013 CUS01-A01-301

sheet no: client: MALDIVES CUSTOMS SERVICE A-13-30

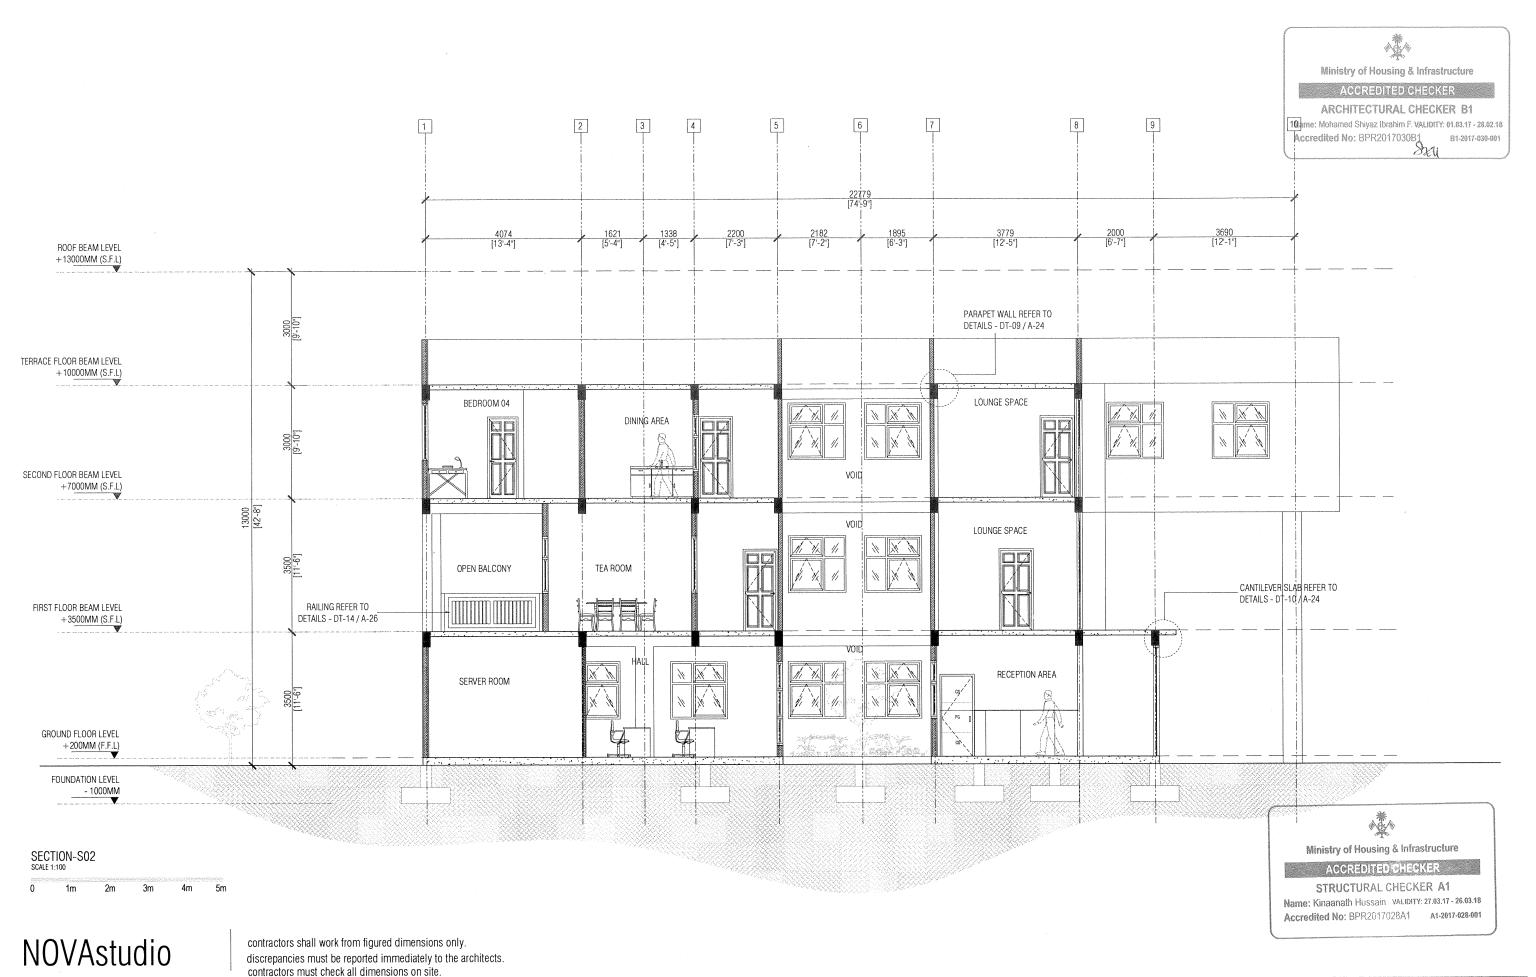

sheet title: SECTION DRAWINGS

DETAILED DESIGN, ARCHITECTURAL DRAWINGS

revision

SHIYAZ architect int.designer: ^lchecked by:

project title: PROPOSED FOUR STOREY BUILDING CUSTOM OFFICE AND ACCOMODATION, HDH. KULHUDHUFFUSHI Project no: MALDIVES CUSTOMS SERVICE


15-06-2013 date: CUS01-A01-301 sheet no:

[|]drw by: scale: COPYRIGHT: THE CONCEPT AND DESIGN IN THIS DRAWING ARE THE PROPERTIES OF NOVA STUDIO. UNAUTHORIZED USE OF ANY KIND OR COPYING OF WHOLE OR PART OF THIS DRAWING, CONCEPT OR DESIGN IN THIS DRAWING.

ıstr.eng:

serv.eng:

SHIYAZ

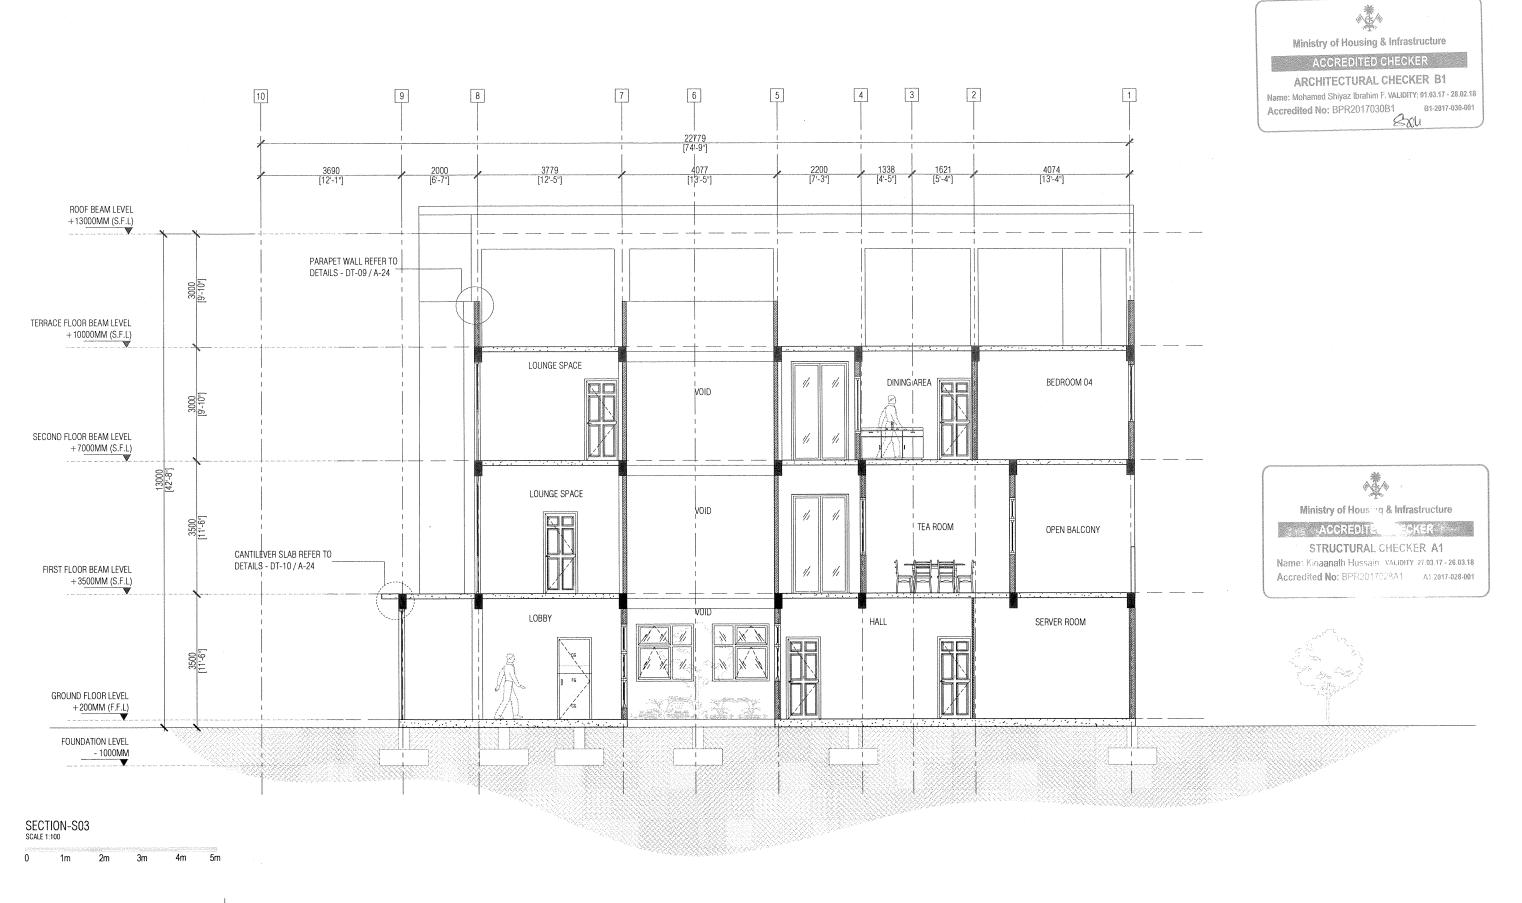

contractors shall work from figured dimensions only. discrepancies must be reported immediately to the architects. contractors must check all dimensions on site.


sheet title: SECTION DRAWINGS DETAILED DESIGN, ARCHITECTURAL DRAWINGS


revision:	architect:	SHIYAZ	str.eng:	SAMNOON	project
A 17.08.15 D B 01.09.15 E	int.designer:		serv.eng:	ARIF	, ,
C 28.05.17 F	checked by:	SHIYAZ	drw by:	SHIYAZ	client:

project title: PROPOSED FOUR STOREY BUILDING CUSTOM OFFICE AND ACCOMODATION, HDH. KULHUDHUFFUSHI

MALDIVES CUSTOMS SERVICE

15-06-2013 date: CUS01-A01-301 sheet no: A-15-30

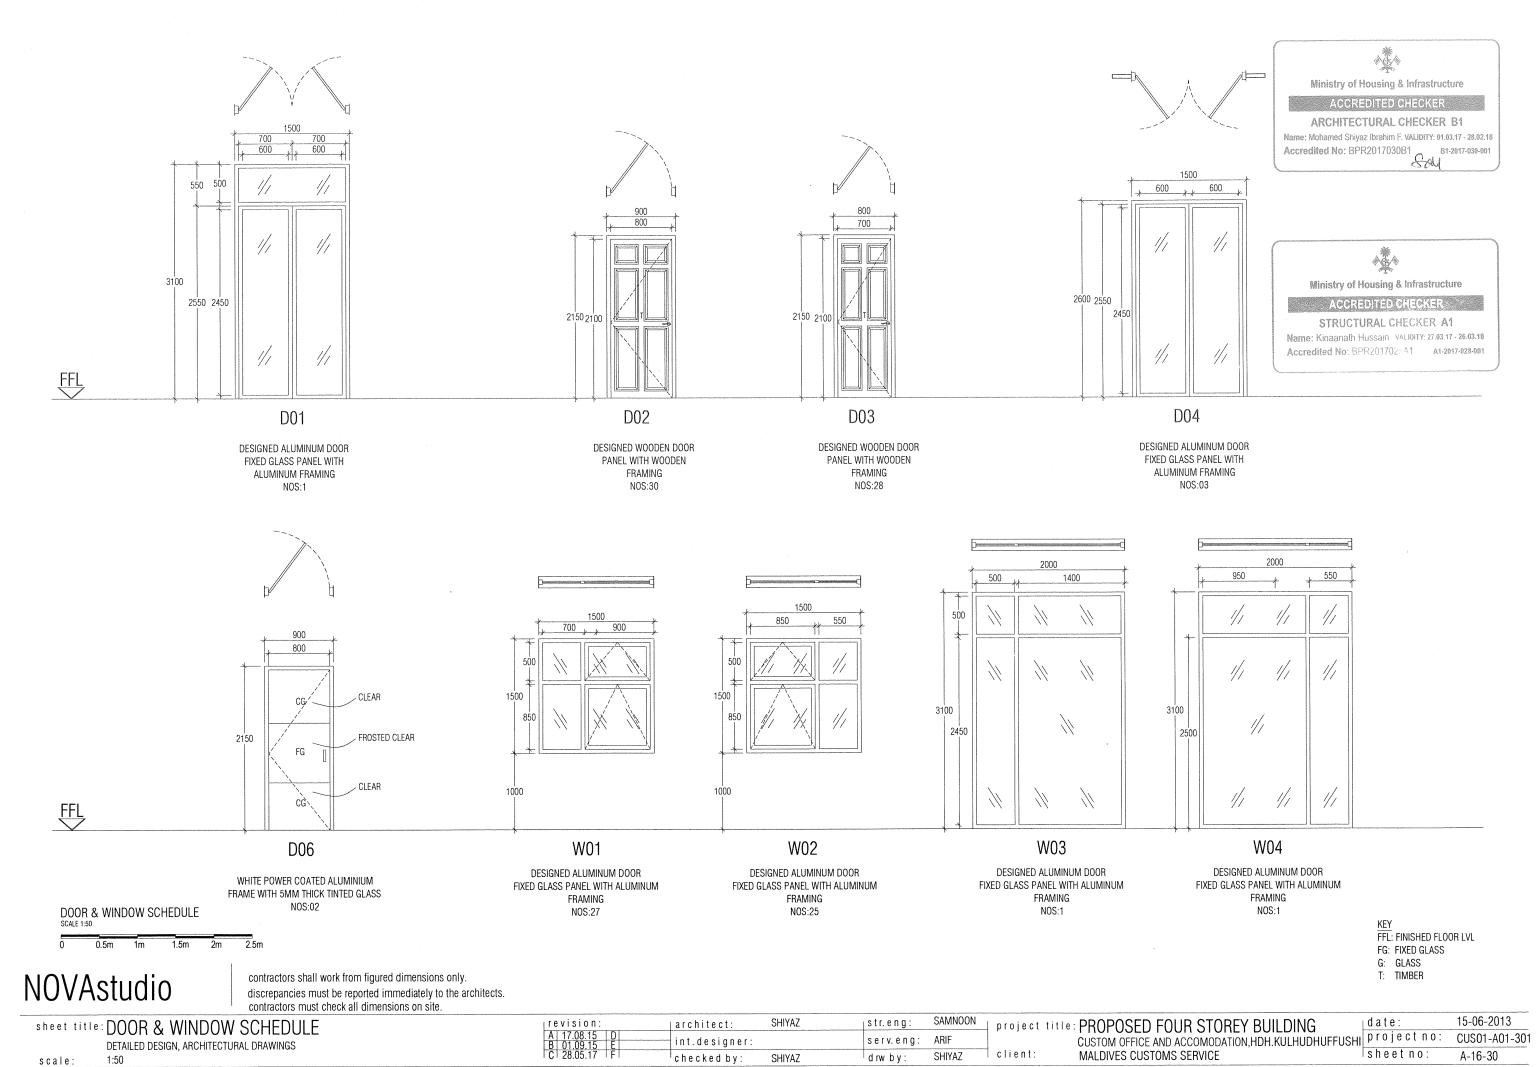

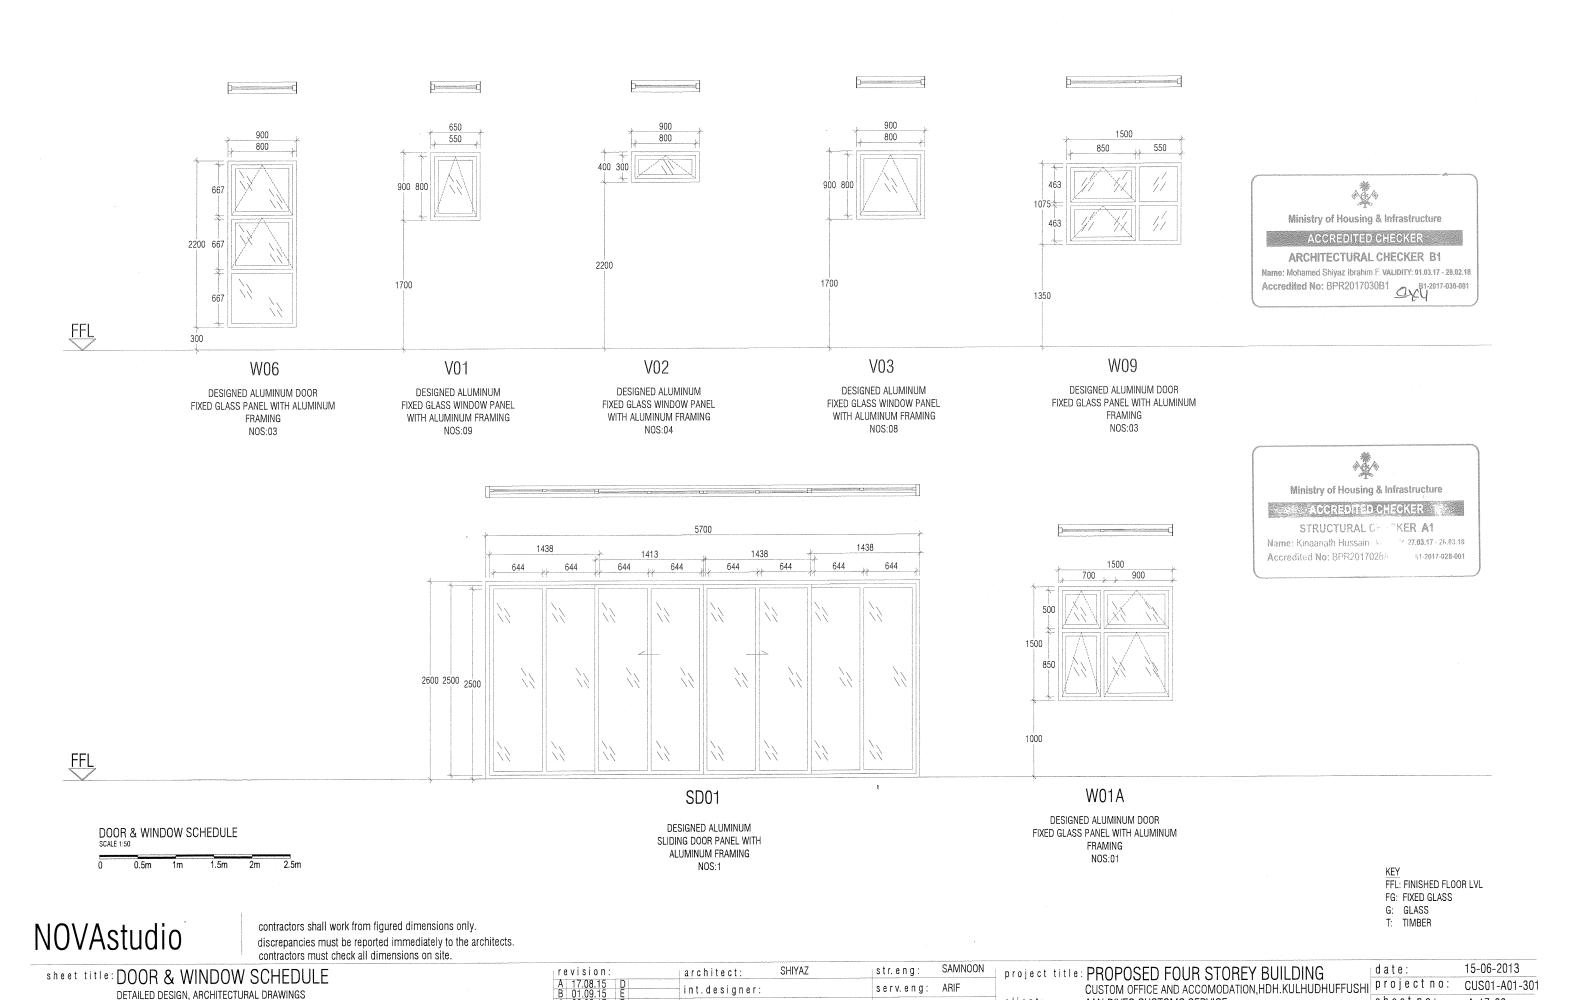


sheet no: client: MALDIVES CUSTOMS SERVICE A-17-30 drw by: checked by: SHIYAZ 1:50 COPYRIGHT: THE CONCEPT AND DESIGN IN THIS DRAWING ARE THE PROPERTIES OF NOVA STUDIO. UNAUTHORIZED USE OF ANY KIND OR COPYING OF WHOLE OR PART OF THIS DRAWING, CONCEPT OR DESIGN IN THIS DRAWING.

DETAILED DESIGN, ARCHITECTURAL DRAWINGS




Accredited No: BPR2017030B1

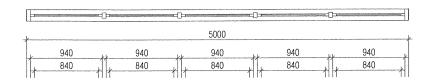




Accredited No: BPR2017028A1 A1-2017-028-001

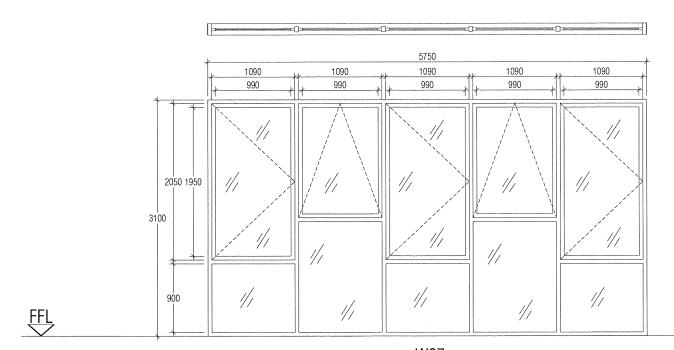

W07

DOOR & WINDOW SCHEDULE SCALE 1:50 0.5m 1m 1.5m 2m

DESIGNED ALUMINUM FIXED GLASS WINDOW PANEL WITH ALUMINUM FRAMING

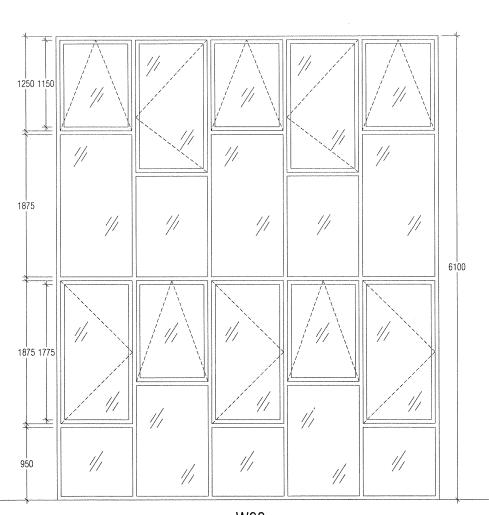

W08

DESIGNED ALUMINUM FIXED GLASS WINDOW PANEL WITH ALUMINUM FRAMING NOS:01

> FFL: FINISHED FLOOR LVL FG: FIXED GLASS

G: GLASS

T: TIMBER

NOVAstudio

contractors shall work from figured dimensions only. discrepancies must be reported immediately to the architects. contractors must check all dimensions on site.

sheet title: DOOR & WINDOW SCHEDULE DETAILED DESIGN, ARCHITECTURAL DRAWINGS


revision:

architect: int.designer checked by:

SAMNOON str.eng: serv.eng: SHIYAZ drw by:

project title: PROPOSED FOUR STOREY BUILDING CUSTOM OFFICE AND ACCOMODATION, HDH. KULHUDHUFFUSHI Project no:

15-06-2013 CUS01-A01-301

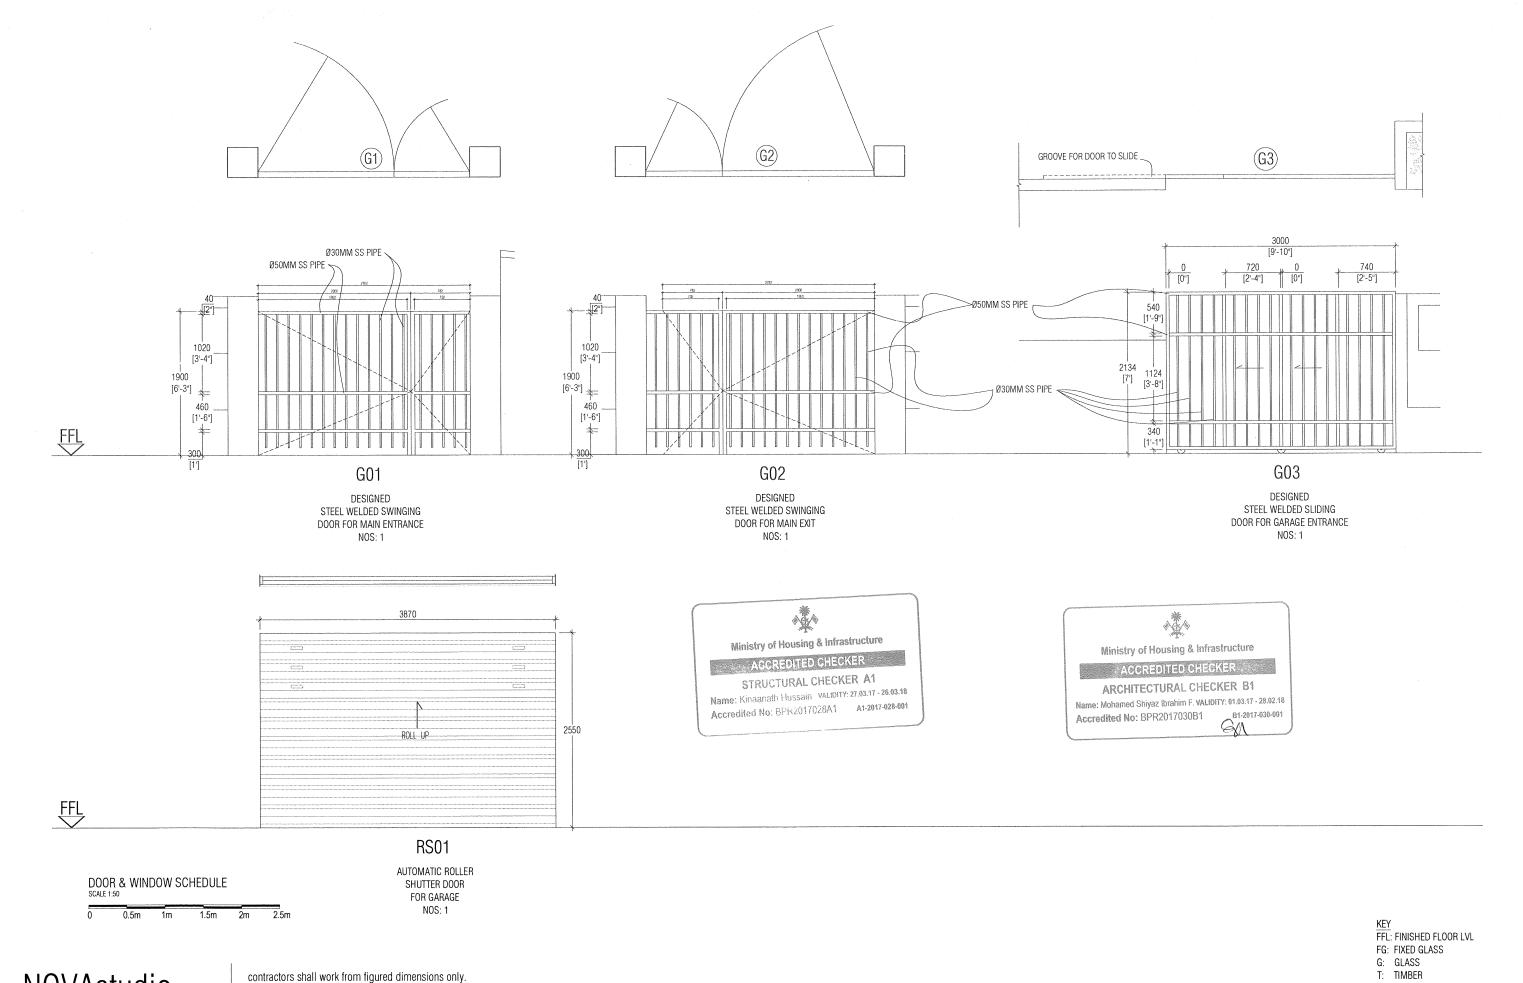

contractors shall work from figured dimensions only. discrepancies must be reported immediately to the architects. contractors must check all dimensions on site.

sheet title: DOOR & WINDOW SCHEDULE DETAILED DESIGN, ARCHITECTURAL DRAWINGS


me	arcn	neci	S.	


revision:	architect:	SHIYAZ	str.eng:	SAMNOON
A 17.08.15 D B 01.09.15 E	int.designer:		serv.eng:	ARIF
C 28.05.17 F	chacked by:	CHIVA7	dry by	SHIYA7

project title: PROPOSED FOUR STOREY BUILDING CUSTOM OFFICE AND ACCOMODATION, HDH. KULHUDHUFFUSHI project no: MALDIVES CUSTOMS SERVICE

15-06-2013 date: CUS01-A01-301 sheet no:



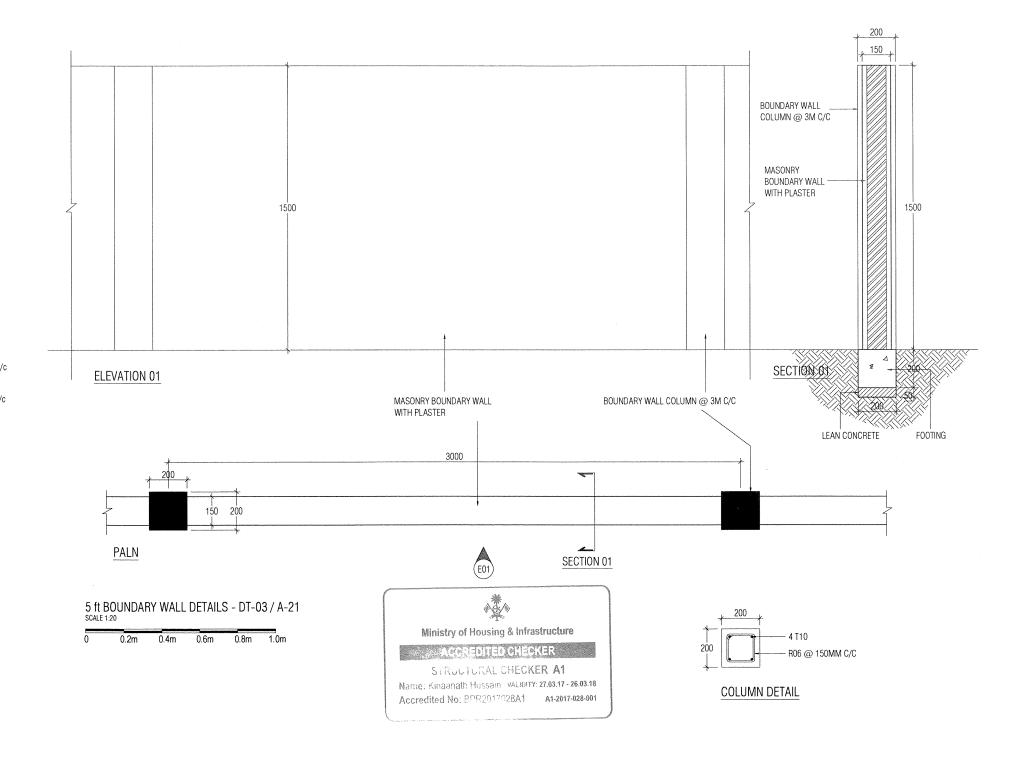

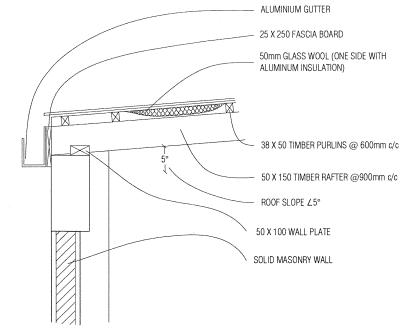

NORMAL GUTTER DETAILS - DT- 02 / A-21
SCALE 1:20
0 0.2m 0.4m 0.6m 0.8m 1.0m

NOVAstudio

contractors shall work from figured dimensions only. discrepancies must be reported immediately to the architects. contractors must check all dimensions on site.

sheet title: DETAILS

DETAILED DESIGN, ARCHITECTURAL DRAWINGS

revision:	architect:	SHIYAZ	str.eng:	SAMNOON	project
A 17.08.15 D B 01.09.15 E	int.designer:		serv.eng:	ARIF	, ,
C 28.05.17 F	checked by:	SHIYAZ	drw by:	SHIYAZ	client:


project title: PROPOSED FOUR STOREY BUILDING date:
CUSTOM OFFICE AND ACCOMODATION, HDH. KULHUDHUFFUSHI

MALDIVES CUSTOMS SERVICE


DING | date: 15-06-2013 | projectno: CUS01-A01-301 | sheetno: A-21-30




Name: Mohamed Shiyaz Ibrahim F. VALIDITY: 01.03.17 - 28.02.18 Accredited No: BPR2017030B1

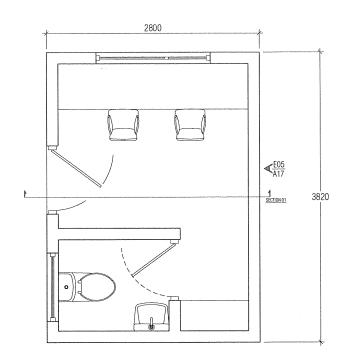

SECURITY GUARD POST DETAILS - DT-04 / A-22 SCALE 1:50 0.2m 0.4m 0.6m 0.8m 1.0m

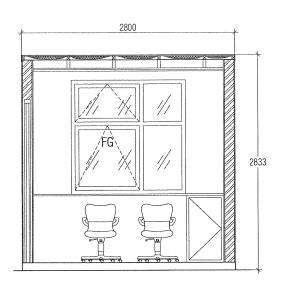

0.2m 0.4m 0.6m 0.8m 1.0m

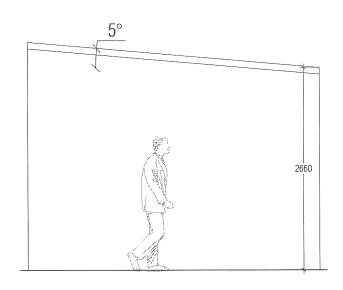

ELEVATION 01 SCALE 1:50 0.2m 0.4m 0.6m 0.8m 1.0m



Ministry of Housing & Infrastructure

* ACCREDITED CHECKER

STRUCTURAL CHECKER A1

Name: Kinaanath Hussain VALIDITY: 27.03.17 - 26.03.18 Accredited No: BPR2017028A1 A1-2017-028-001

NOVAstudio

contractors shall work from figured dimensions only. discrepancies must be reported immediately to the architects. contractors must check all dimensions on site.

sheet title: DETAILS

DETAILED DESIGN, ARCHITECTURAL DRAWINGS

revision:	architect:	SHIYAZ	str.eng:	SAMNOON	
A 17.08.15 D B 01.09.15 E	int.designer:		serv.eng:	ARIF	
C 28.05.17 F	checked by:	SHIYAZ	drw by:	SHIYAZ	


client:


project title: PROPOSED FOUR STOREY BUILDING
CUSTOM OFFICE AND ACCOMODATION, HDH. KULHUDHUFFUSHI MALDIVES CUSTOMS SERVICE

date: 15-06-2013 CUS01-A01-301

sheet no: A-22-30



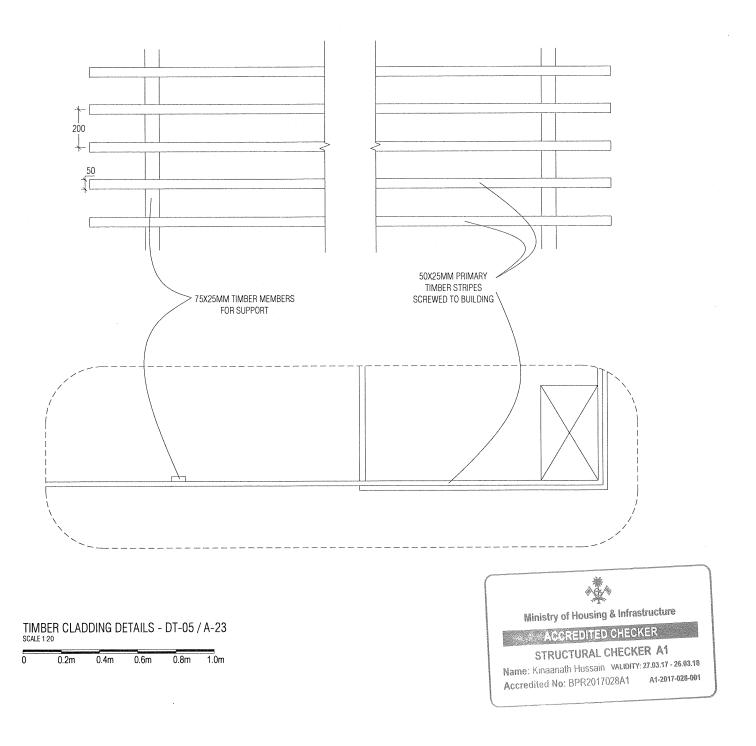

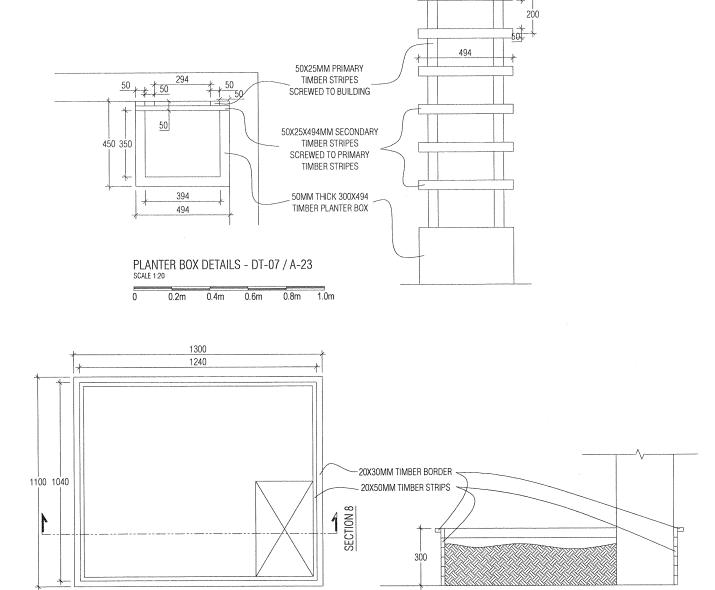

contractors shall work from figured dimensions only. discrepancies must be reported immediately to the architects. contractors must check all dimensions on site.

sheet title: DETAILS

DETAILED DESIGN, ARCHITECTURAL DRAWINGS

revision:	architect:	SHIYAZ	str.eng:	SAMNOON	proiect
A 17.08.15 D B 01.09.15 E	int.designer:		serv.eng:	ARIF	r · · · , · · · ·
C 28.05.17 F	checked by:	SHIYAZ	drw by:	SHIYAZ	client:

project title: PROPOSED FOUR STOREY BUILDING

PLANTER BOX DETAILS - DT-06 / A-23 SCALE 1:20


0.2m 0.4m 0.6m 0.8m 1.0m

CUSTOM OFFICE AND ACCOMODATION, HDH. KULHUDHUFFUSHI project no: MALDIVES CUSTOMS SERVICE

SECTION 02


15-06-2013 CUS01-A01-301 sheet no: A-23-30


SHIYAZ scale: COPYRIGHT: THE CONCEPT AND DESIGN IN THIS DRAWING ARE THE PROPERTIES OF NOVA STUDIO. UNAUTHORIZED USE OF ANY KIND OR COPYING OF WHOLE OR PART OF THIS DRAWING, CONCEPT OR DESIGN IN THIS DRAWING.

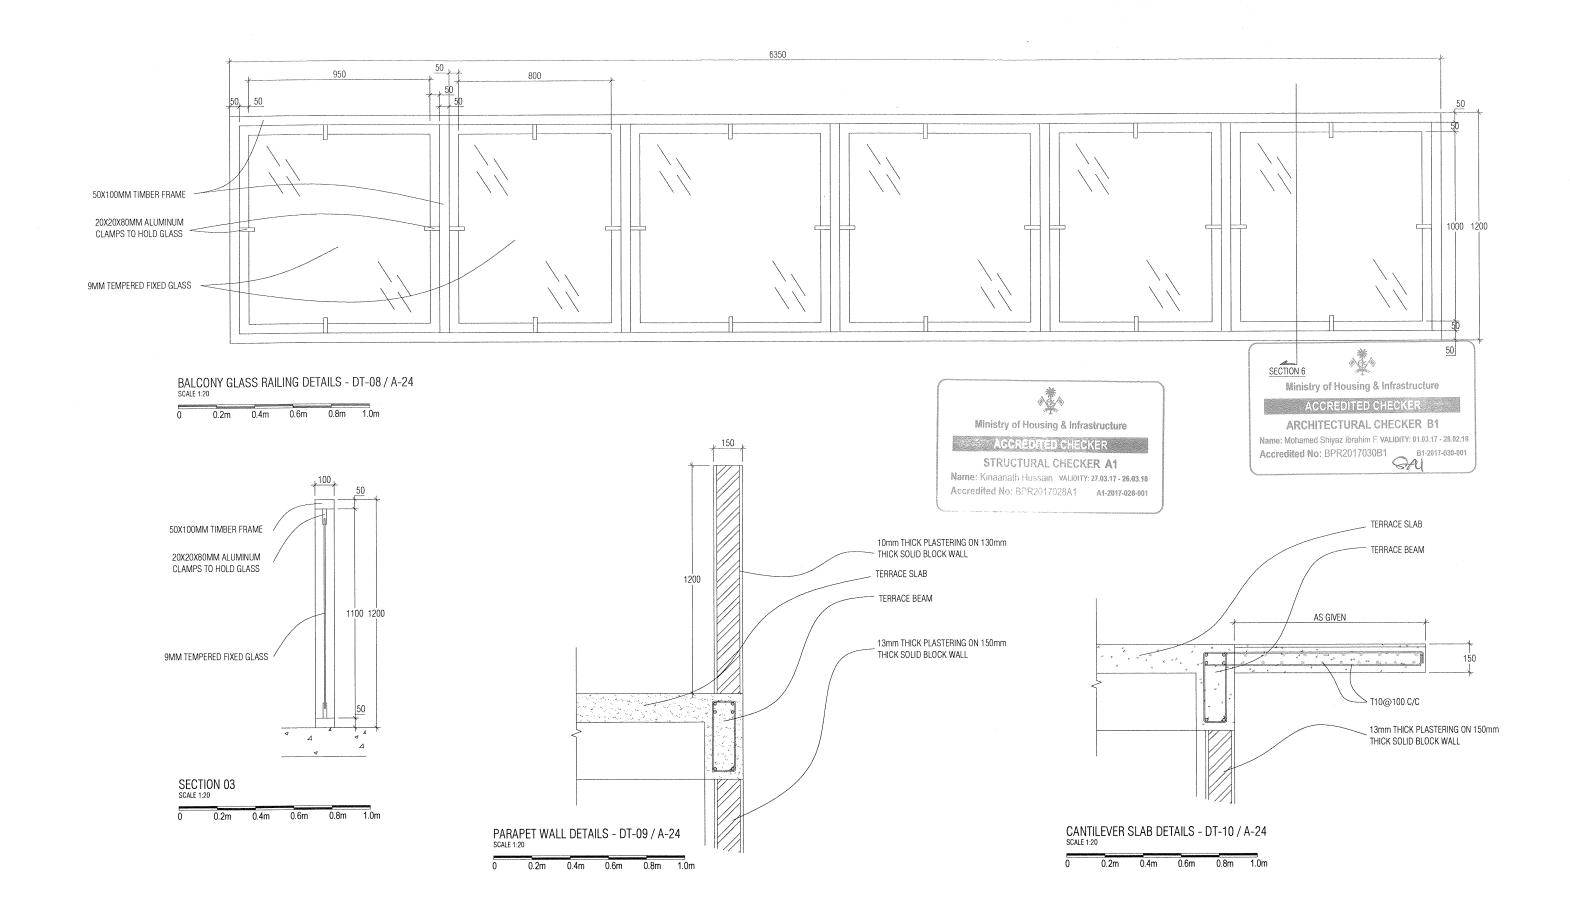

contractors shall work from figured dimensions only. discrepancies must be reported immediately to the architects. contractors must check all dimensions on site.

SAMNOON 15-06-2013 SHIYAZ date sheet title: DETAILS revision: str.eng: project title: PROPOSED FOUR STOREY BUILDING | architect: CUSTOM OFFICE AND ACCOMODATION, HDH. KULHUDHUFFUSHI project no: CUS01-A01-301 serv.eng: ARIF int.designer: DETAILED DESIGN, ARCHITECTURAL DRAWINGS sheet no: client: MALDIVES CUSTOMS SERVICE A-24-30 checked by: drw by: SHIYAZ

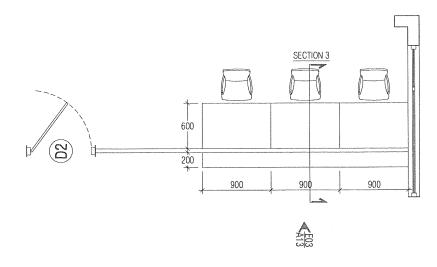

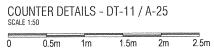







Ministry of Housing & Infrastructure

ACCREDITED CHECKER

STRUCTURAL CHECKER A1
Name: Kinaanath Hussain validity: 27.03.17 - 26.03.18
Accredited No: BPR2017028A1 A1-2017-028-001

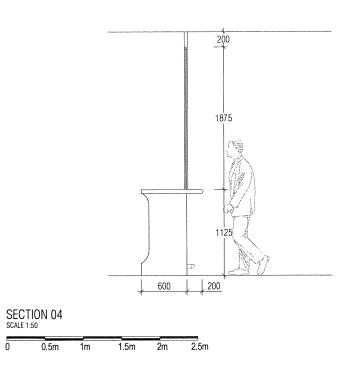

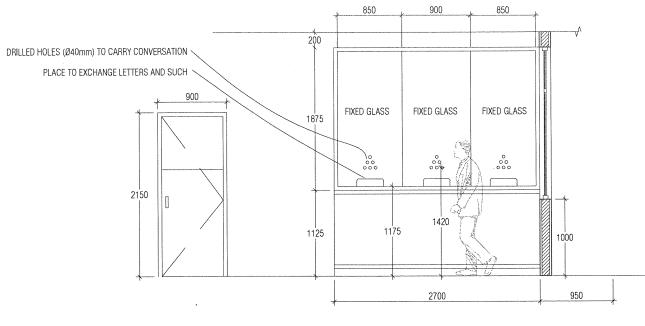


ELEVATION E-02 SCALE 1:50 0 0.5m 1m 1.5m 2m 2.5

NOVAstudio

contractors shall work from figured dimensions only. discrepancies must be reported immediately to the architects. contractors must check all dimensions on site.

sheet title: DETAILS
DETAILED DESIGN, ARCHITECTURAL DRAWINGS

revision:	architect:	SHIYAZ	str.eng:	SAMNOON	」 project tit	tle: PROPOSED FOUR STOREY BUILDING	date:	15-06-2013
A 17.08.15 D B 01.09.15 E C 28.05.17 F	int.designer:		serv.eng:			CUSTOM OFFICE AND ACCOMODATION, HDH. KULHUDHUFFUSHI	project no:	CUS01-A01-301
C 28.05.17 F	checked by:	SHIYAZ	drw by:	SHIYAZ	1 client:	MALDIVES CUSTOMS SERVICE	sheet no:	A-25-30

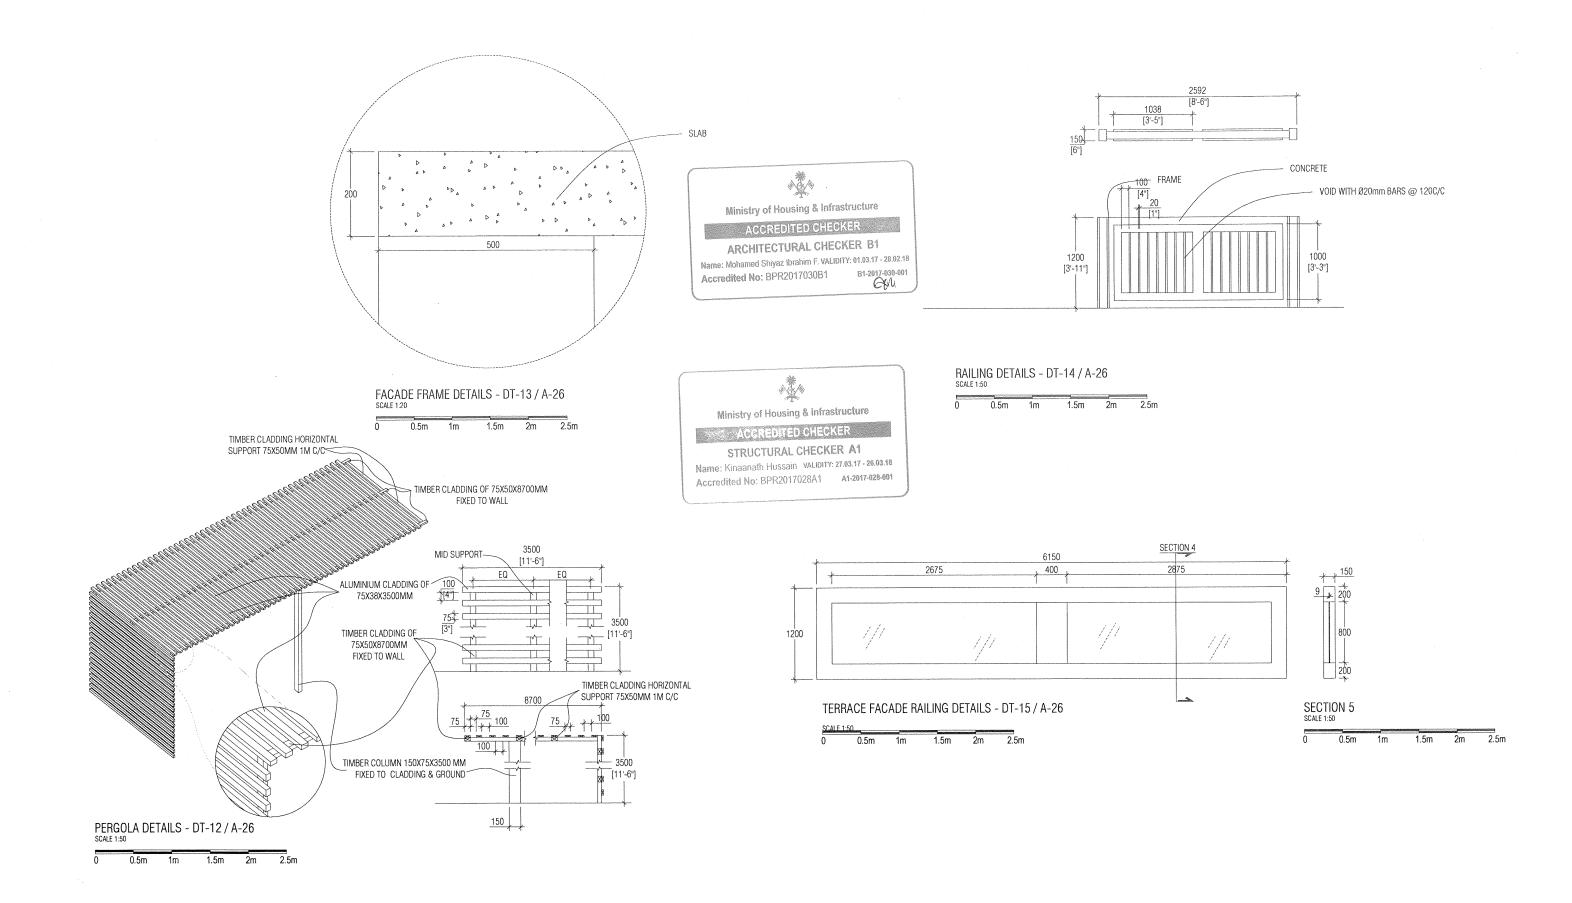

scale:

contractors shall work from figured dimensions only. discrepancies must be reported immediately to the architects. contractors must check all dimensions on site.

sheet title: DETAILS	
DETAILED DESIGN, ARCHITECTURAL DRAWINGS	


1:50

revision:	ar
A 17.08.15 D	:
B 01.09.15 E	1111
C 28.05.17 F	c h

revision:	architect:	SHIYAZ	str.eng:	SAMNOON
A 17.08.15 D B 01.09.15 E	int.designer:		serv.eng:	ARIF
C 28.05.17 F	checked by:	SHIYAZ	drw by:	SHIYAZ

project title: PROPOSED FOUR STOREY BUILDING CUSTOM OFFICE AND ACCOMODATION, HDH. KULHUDHUFFUSHI project no: client: MALDIVES CUSTOMS SERVICE

15-06-2013 date: CUS01-A01-301 sheet no: A-26-30

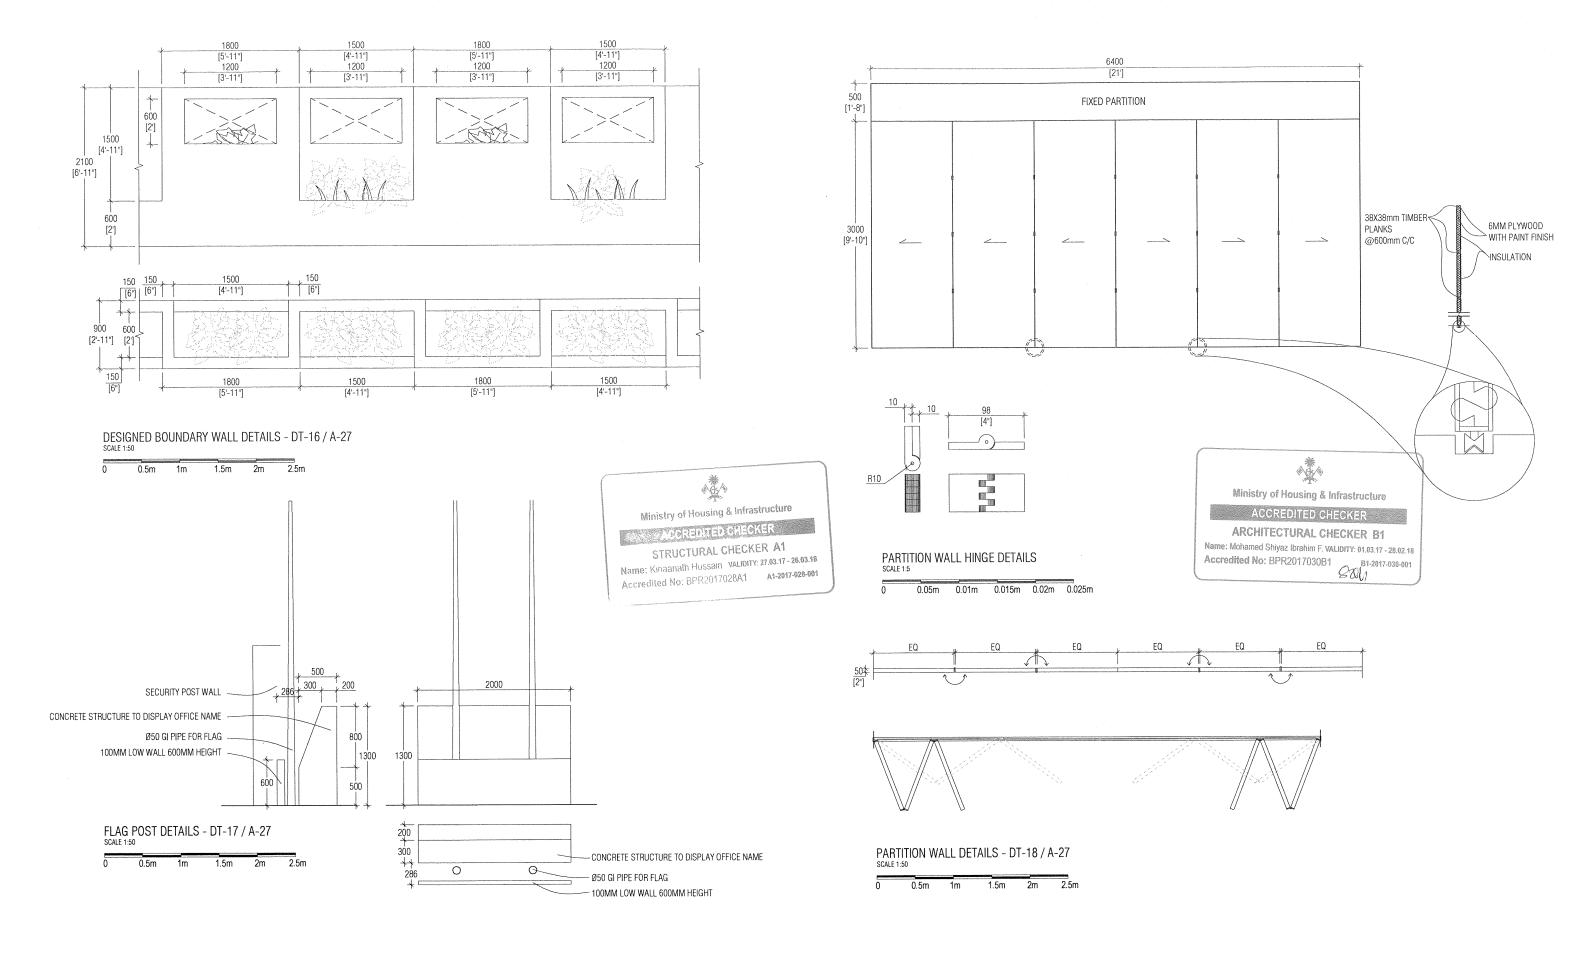

contractors shall work from figured dimensions only. discrepancies must be reported immediately to the architects. contractors must check all dimensions on site.

sheet title: DETAILS


DETAILED DESIGN, ARCHITECTURAL DRAWINGS


1	revision:	architect:	SHIYAZ	str.eng:	SAMNOON
	A 17.08.15 D B 01.09.15 E	int.designer:		serv.eng:	ARIF
	C 28.05.17 F	checked by:	SHIYAZ	drw by:	SHIYAZ

project title: PROPOSED FOUR STOREY BUILDING
CUSTOM OFFICE AND ACCOMODATION, HDH. KULHUDHUFFUSHI


MALDIVES CUSTOMS SERVICE


FUSH date: 15-06-2013 projectno: CUS01-A01-301 sheetno: A-27-30

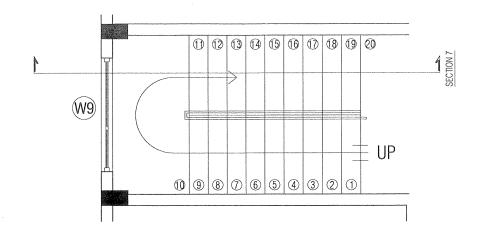

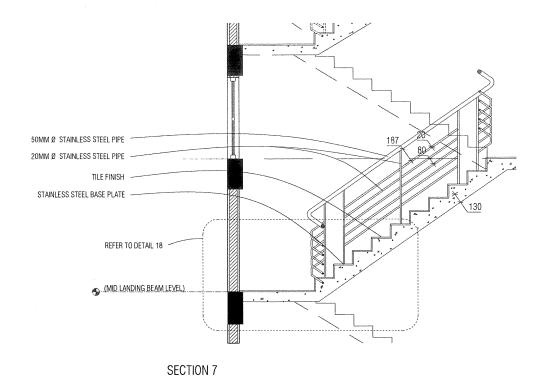

	GROUND TO SECOND FLOOR	SECOND TO TERRACE FLOOR
Going	- 250.00mm	- 250.00mm
Riser	- 175.0mm	- 150.0mm
No. of Goings	- 19 nos	- 19 nos

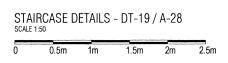

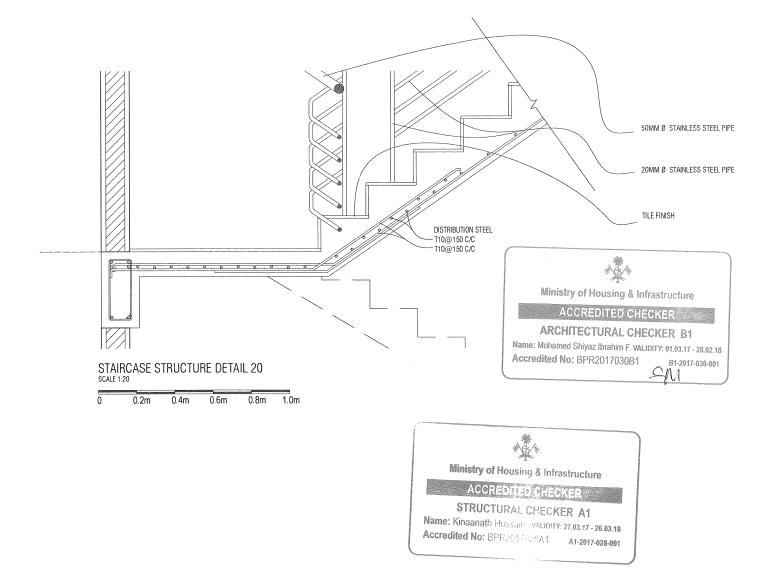

contractors shall work from figured dimensions only. discrepancies must be reported immediately to the architects. contractors must check all dimensions on site.


sheet title: DETAILS DETAILED DESIGN, ARCHITECTURAL DRAWINGS revision: A 17.08.15 B 01.09.15 C 28.05.17 SHIYAZ |architect: str.eng: serv.eng: ARIF int.designer SHIYAZ ^lchecked by: ^ldrw by:

project title: PROPOSED FOUR STOREY BUILDING CUSTOM OFFICE AND ACCOMODATION, HDH. KULHUDHUFFUSHI projectno:

MALDIVES CUSTOMS SERVICE

15-06-2013 date: CUS01-A01-301 sheet no: A-28-30

scale: COPYRIGHT: THE CONCEPT AND DESIGN IN THIS DRAWING, ROCCEPT OR DESIGN OR USE OF ANY KIND OR COPYING OF WHOLE OR PART OF THIS DRAWING, CONCEPT OR DESIGN OR USE THE CONCEPT OR DESIGN IN THIS DRAWING.

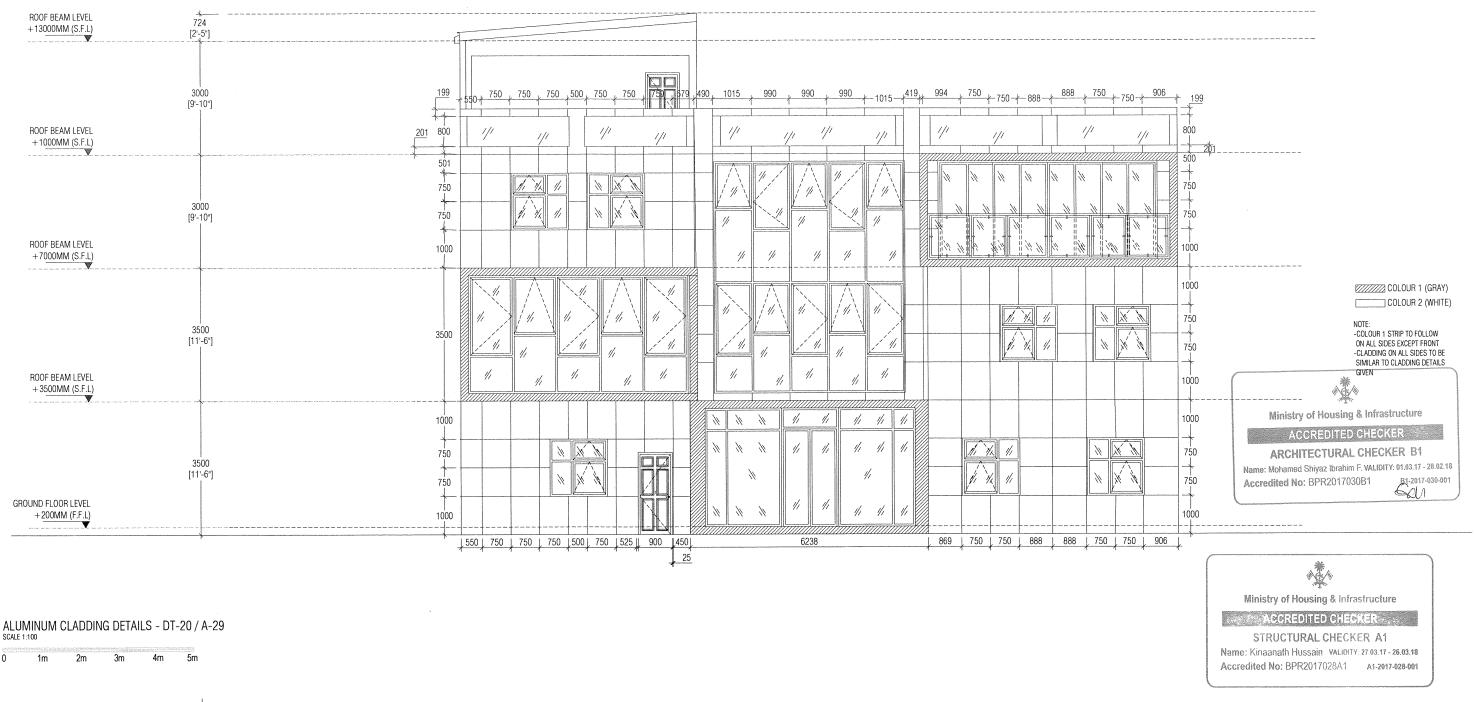

contractors shall work from figured dimensions only. discrepancies must be reported immediately to the architects. contractors must check all dimensions on site.

SAMNOON SHIYAZ revision: str.eng: | architect: sheet title: CLADDING DETAILS serv.eng: int.designer: DETAILED DESIGN, ARCHITECTURAL DRAWINGS checked by: drw by: scale:

project title: PROPOSED FOUR STOREY BUILDING CUSTOM OFFICE AND ACCOMODATION, HDH. KULHUDHUFFUSHI project no: MALDIVES CUSTOMS SERVICE

15-06-2013 date: CUS01-A01-301 sheet no: A-29-30

COPYRIGHT: THE CONCEPT AND DESIGN IN THIS DRAWING ARE THE PROPERTIES OF NOVA STUDIO. UNAUTHORIZED USE OF ANY KIND OR COPYING OF WHOLE OR PART OF THIS DRAWING, CONCEPT OR DESIGN IN THIS DRAWING.



ROOF BEAM LEVEL 724 +13000MM (S.F.L) [2'-4"] 3000 [9'-10"] ROOF BEAM LEVEL +1000MM (S.F.L) 1200 1700 500 11 14 11 750 750 [9'-10"] ROOF BEAM LEVEL 1000 1000 +7000MM (S.F.L) 1000 1000 COLOUR 1 (GRAY) COLOUR 2 (WHITE) 11 1/1/1 11 1/4 1/1 750 NOTE: -COLOUR 1 STRIP TO FOLLOW 3500 [11'-6"] ON ALL SIDES EXCEPT FRONT
-CLADDING ON ALL SIDES TO BE
SIMILAR TO CLADDING DETAILS 750 ROOF BEAM LEVEL 1000 1000 +3500MM (S.F.L) 150 1000 11 1/2 1/1 11 1/2 1/1 11 1/2 1/1 11 1/4 1/1 11 1/4 // 750 3500 [11'-6"] 1 K 16 750 GROUND FLOOR LEVEL +200MM (F.F.L) 1463 | 750 | 512 | 375 | 750 | 750 | 750 | 611 | 611 | 750 | 750 | 691 | 691 | 750 | 750 | 680 | 680 | 750 | 750 | 660 | 660 | 750 | 750 | 699 | 699 | 750 | 750 | 758 | <u>|</u>500|

ALUMINUM CLADDING DETAILS - DT-21 / A-30 SCALE 1:100

Ministry of Housing & Infrastructure

ACCREDITED CHECKER STRUCTURAL CHECKER A1

Name: Kinaanath Hussain VALIDITY 27.03.17 - 26.03.18
Accredited No: BPR201702841 A1-2017-028-001

NOVAstudio

contractors shall work from figured dimensions only. discrepancies must be reported immediately to the architects. contractors must check all dimensions on site.

sheet title: CLADDING DETAILS

DETAILED DESIGN, ARCHITECTURAL DRAWINGS 1:100


revision:	architect:	SHIYAZ	str.eng:	SAMNOON
A 17.08.15 D B 01.09.15 E	int.designer:		serv.eng:	ARIF
C 28.05.17 F	checked by:	SHIYAZ	drw by:	SHIYAZ

project title: PROPOSED FOUR STOREY BUILDING
CUSTOM OFFICE AND ACCOMODATION, HDH. KULHUDHUFFUSHI

project no:

MALDIVES CUSTOMS SERVICE

SHI date: 15-06-2013 projectno: CUS01-A01-301 sheetno: A-30-30 STRUCTURAL DRAWING CUSTOMS, HDH.KULHUDHUFFUSHI, MALDIVES

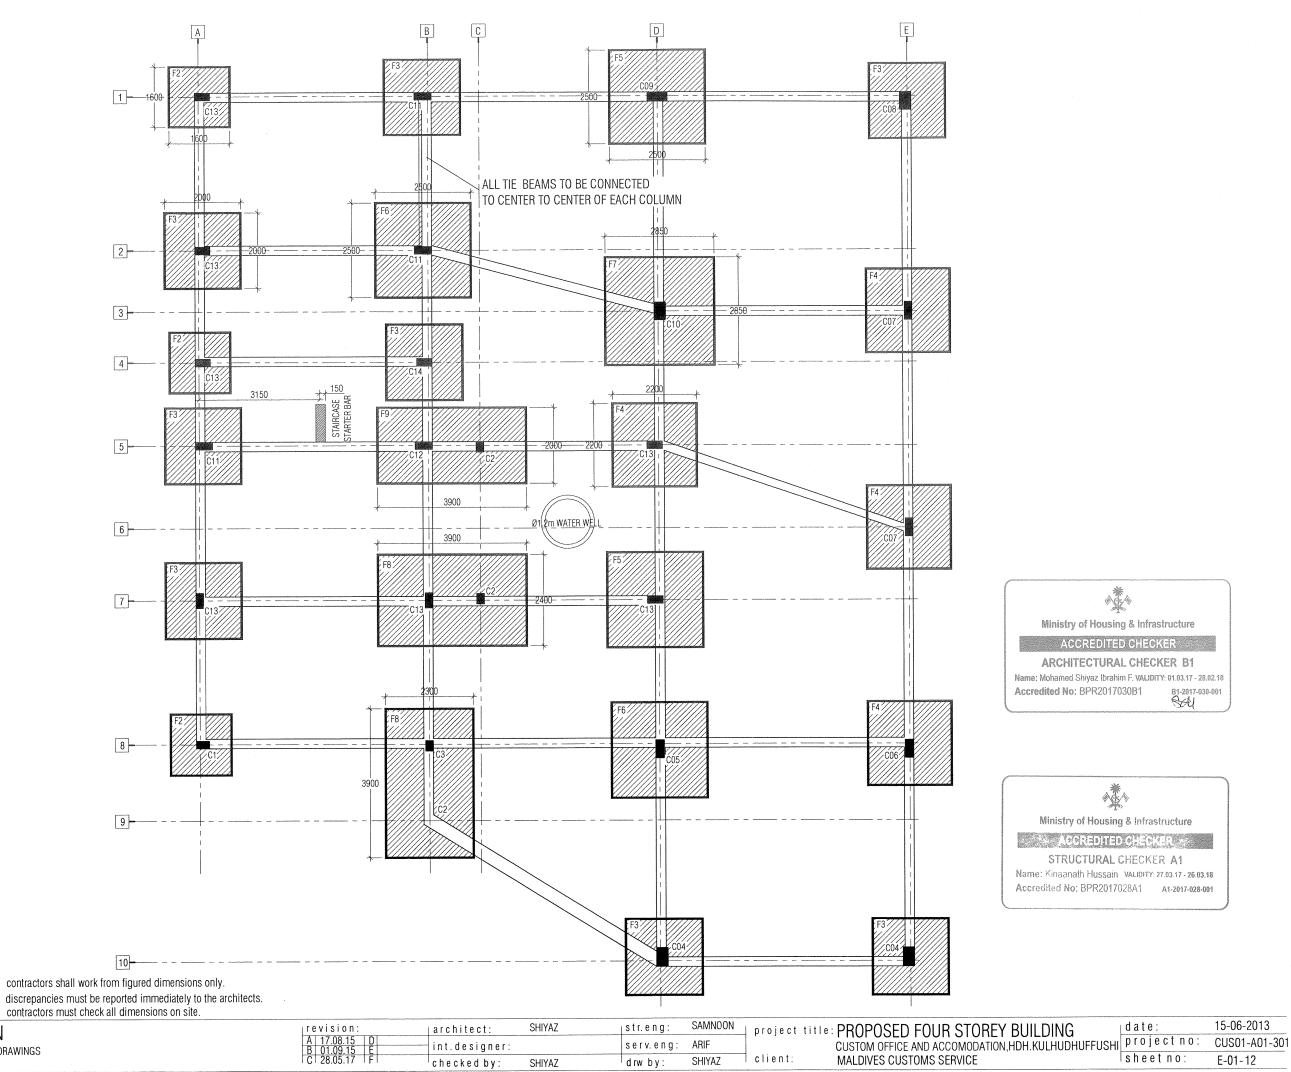


COPYRIGHT: THE CONCEPT AND DESIGN IN THIS DRAWING ARE THE PROPERTIES OF NOVA STUDIO, UNAUTHORIZED USE OF ANY KIND OR COPYING OF WHOLE OR PART OF THIS DRAWING, CONCEPT OR DESIGN IN THIS DRAWING.

FOUNDATION PLAN SCALE 1:100

NOVAstudio

sheet title: FOUNDATION PLAN

DETAILED DESIGN, STRUCTURAL DRAWINGS

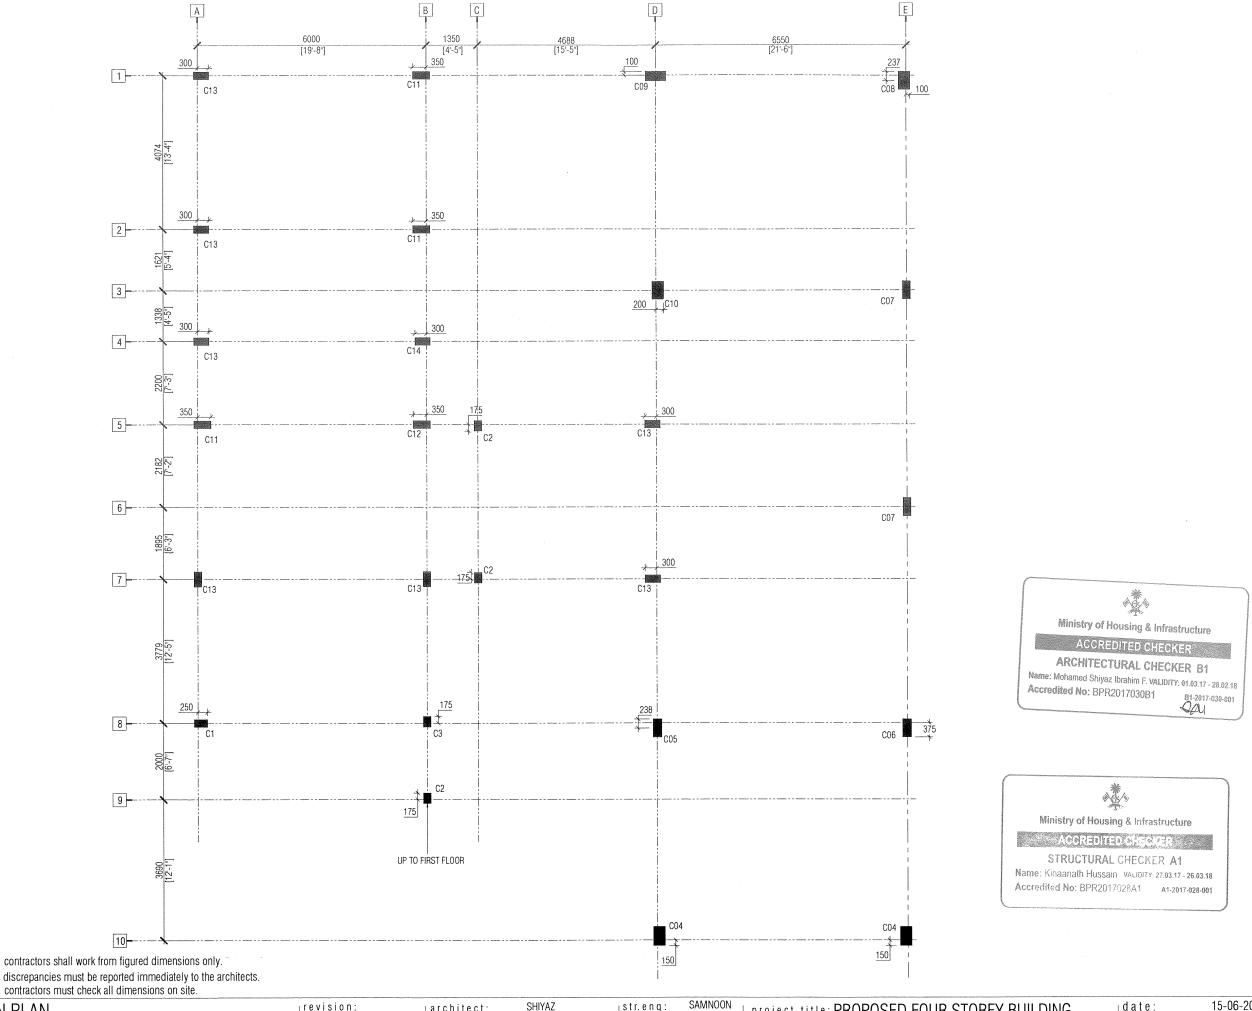

COLUMN LOCATION PLAN SCALE 1:100

contractors shall work from figured dimensions only. discrepancies must be reported immediately to the architects.

sheet title: COLUMN LOCATION PLAN


DETAILED DESIGN, STRUCTURAL DRAWINGS

revision: A 17.08.15 B 01.09.15 SHIYAZ str.eng: architect: serv.eng: int.designer: ldrwby: SHIYAZ


project title: PROPOSED FOUR STOREY BUILDING

15-06-2013 date project no: CUS01-A01-301


CUSTOM OFFICE AND ACCOMODATION, HDH. KULHUDHUFFUSHI MALDIVES CUSTOMS SERVICE E-02 12

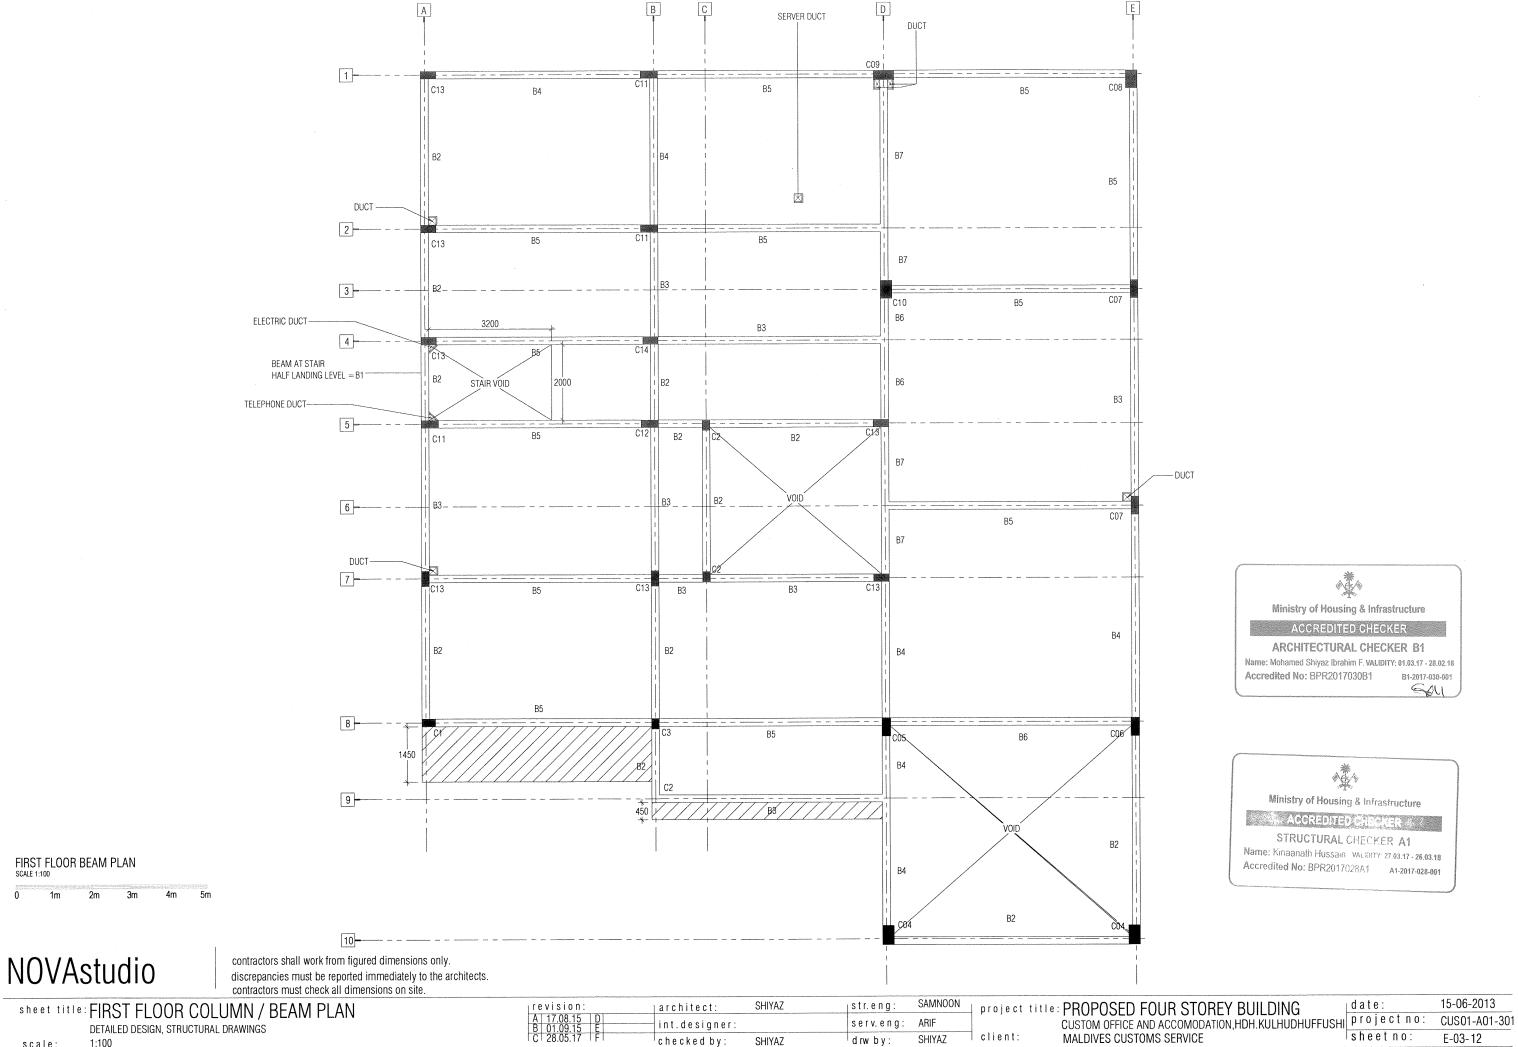


COPYRIGHT: THE CONCEPT AND DESIGN IN THIS DRAWING ARE THE PROPERTIES OF NOVA STUDIO. UNAUTHORIZED USE OF ANY KIND OR COPYING OF WHOLE OR PART OF THIS DRAWING, CONCEPT OR DESIGN IN THIS DRAWING.

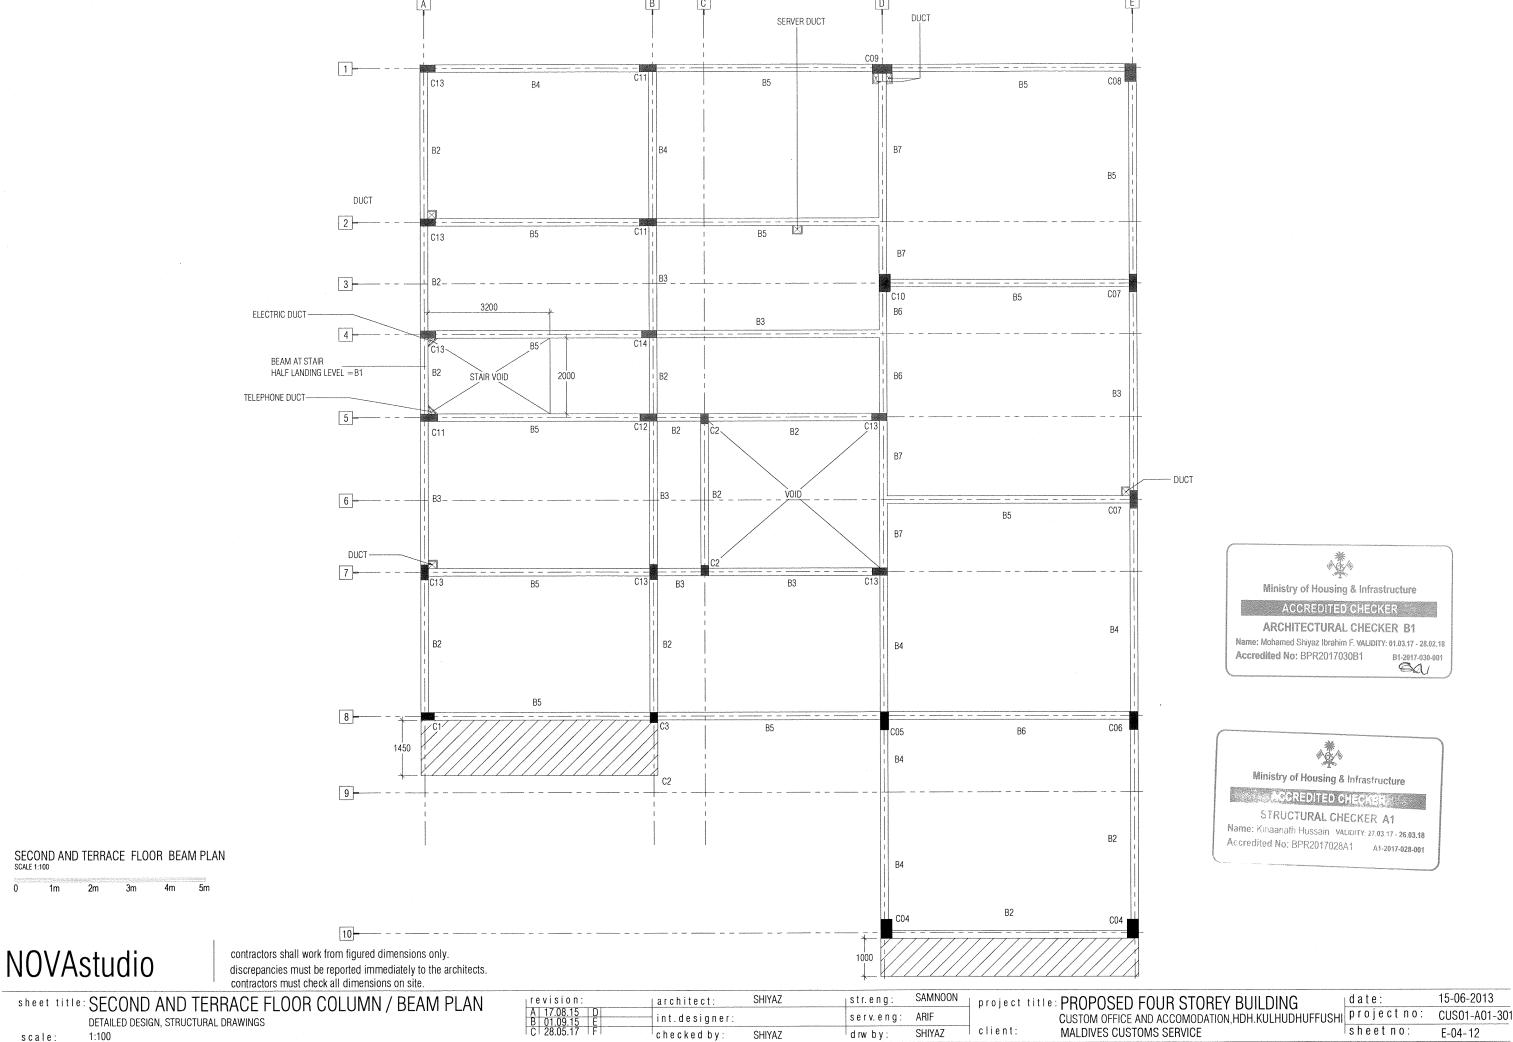



COPYRIGHT: THE CONCEPT AND DESIGN IN THIS DRAWING ARE THE PROPERTIES OF NOVA STUDIO, UNAUTHORIZED USE OF ANY KIND OR COPYING OF WHOLE OR PART OF THIS DRAWING, CONCEPT OR DESIGN IN THIS DRAWING.

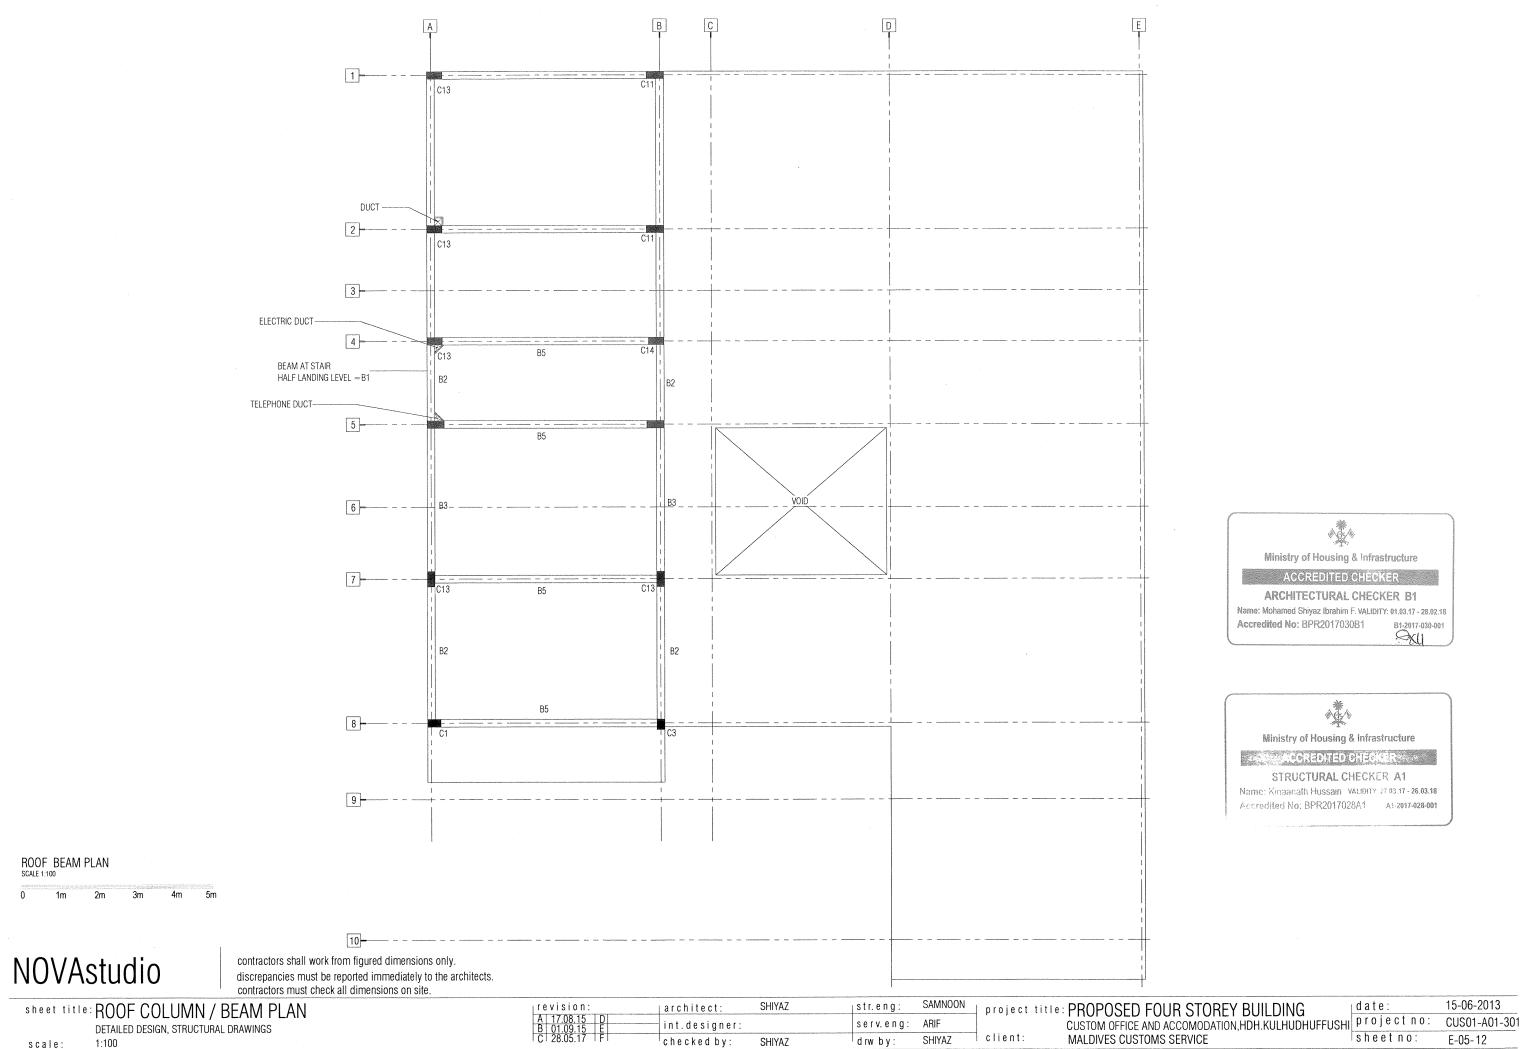



COPYRIGHT: THE CONCEPT AND DESIGN IN THIS DRAWING ARE THE PROPERTIES OF NOVA STUDIO. UNAUTHORIZED USE OF ANY KIND OR COPYING OF WHOLE OR PART OF THIS DRAWING, CONCEPT OR DESIGN IN THIS DRAWING.

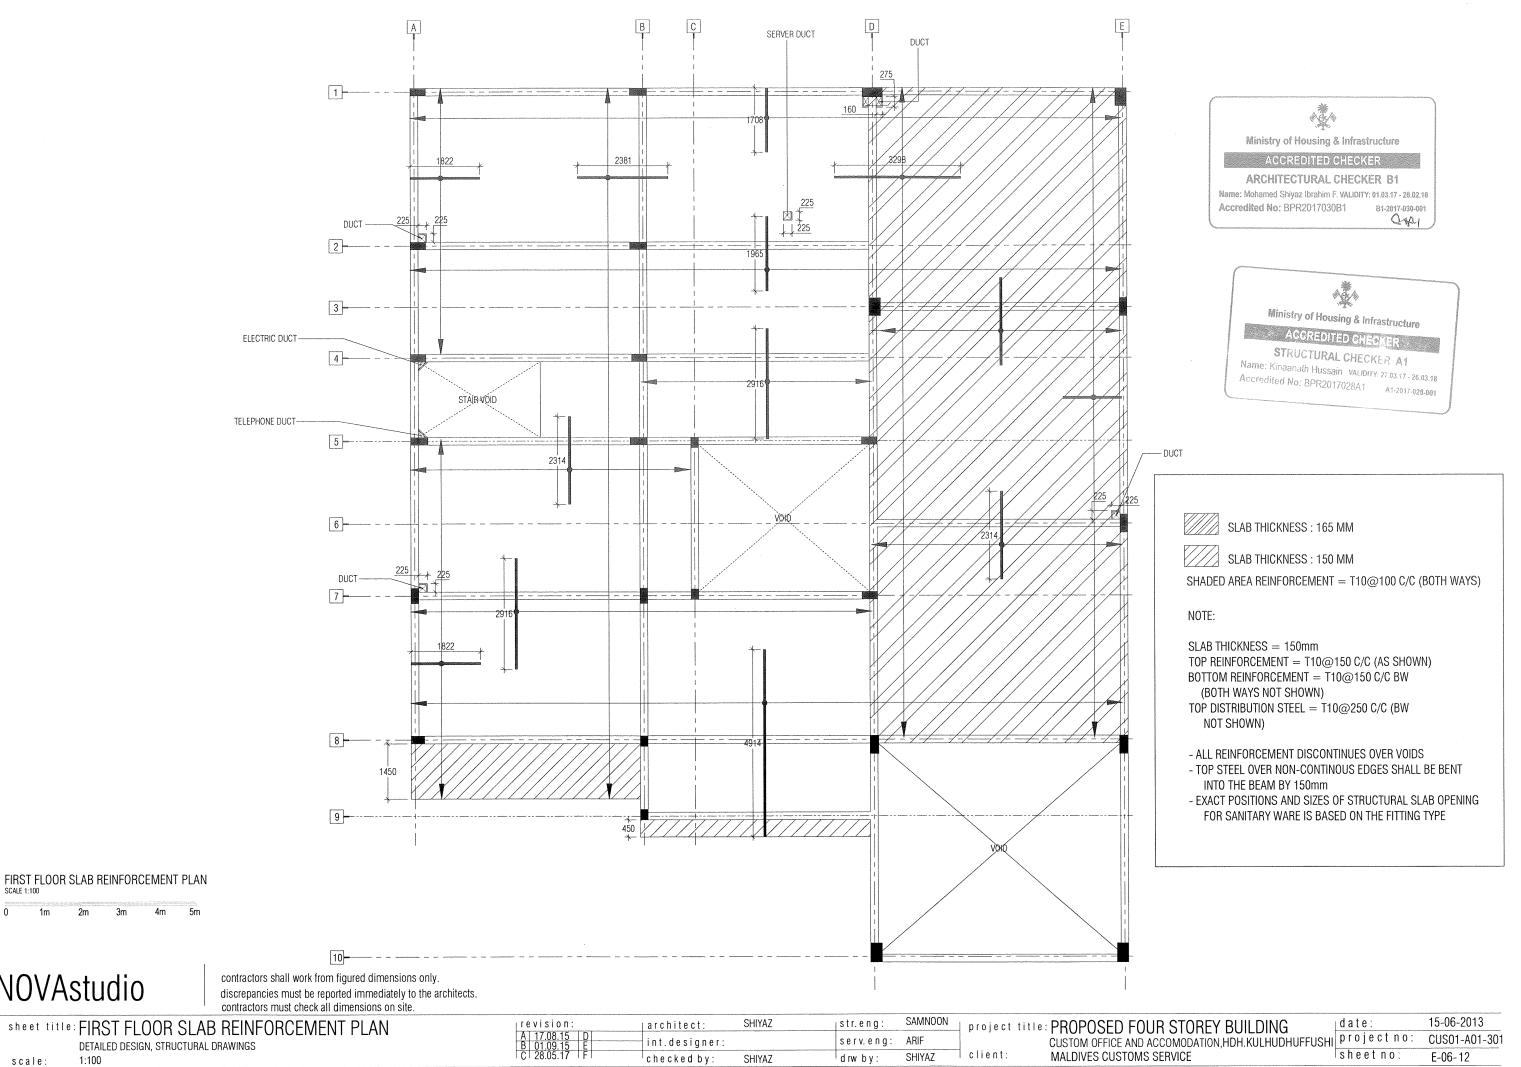


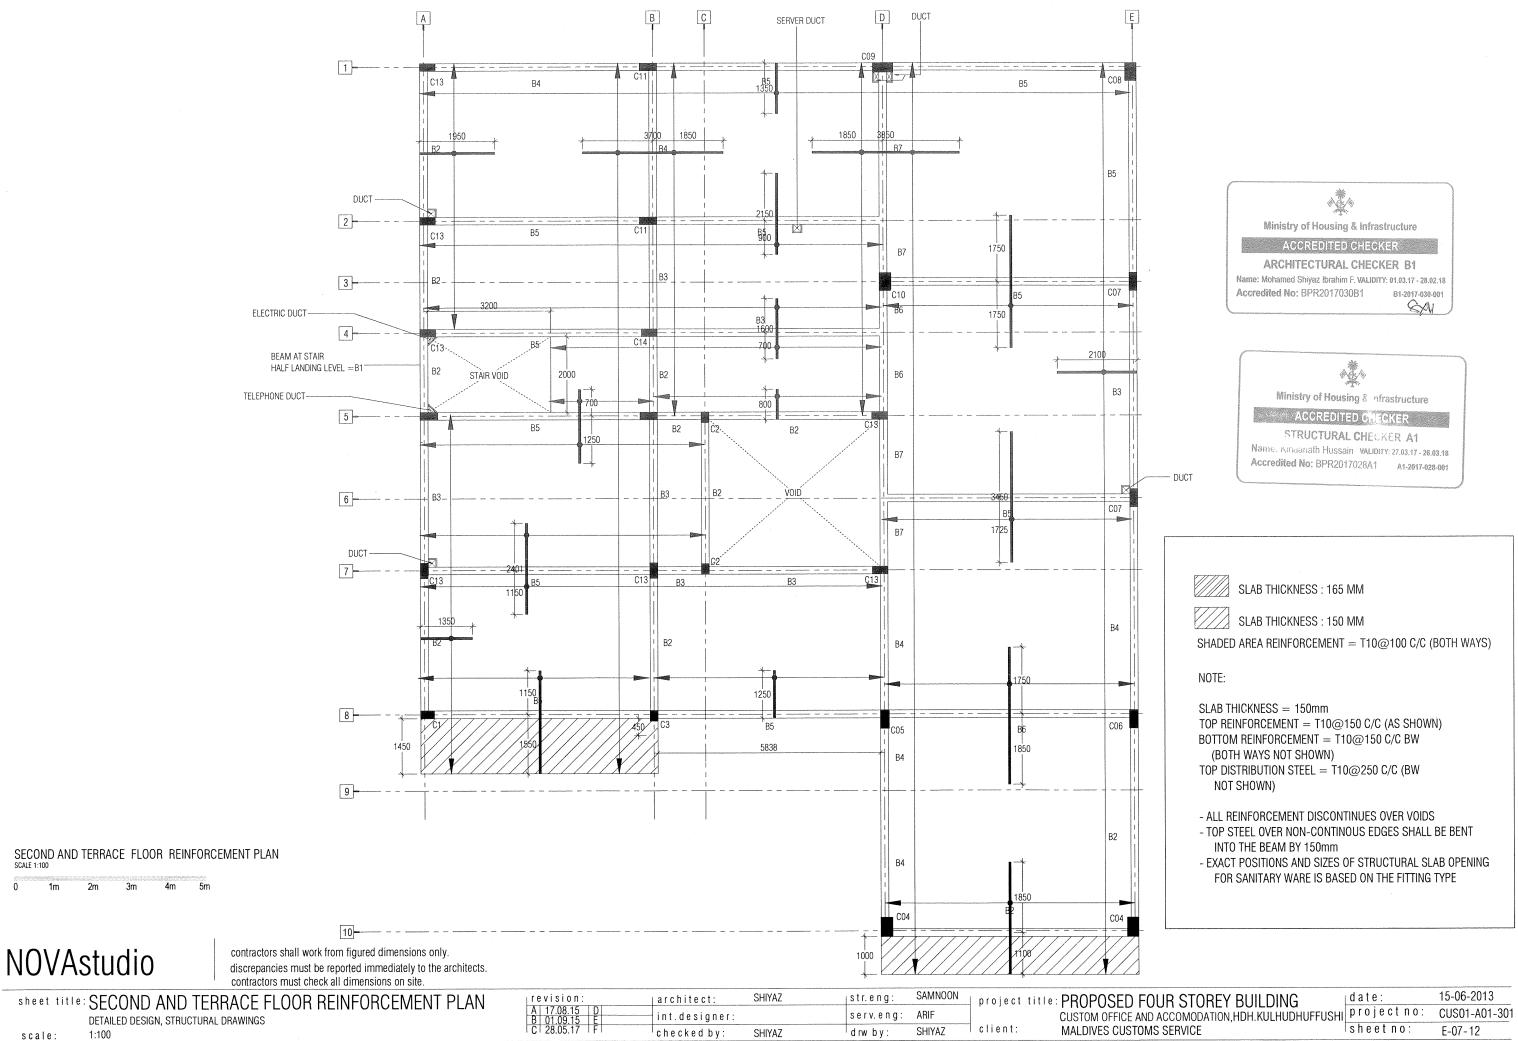


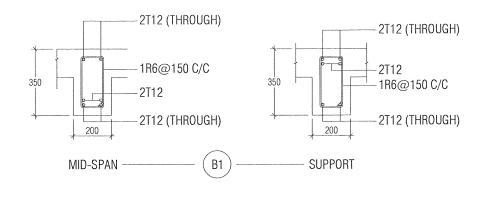


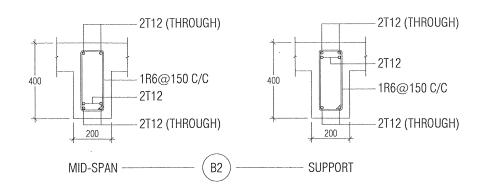


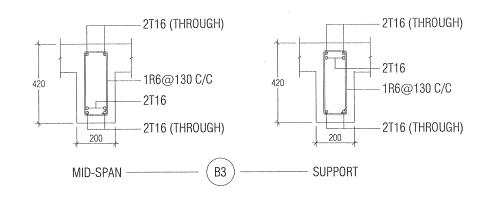


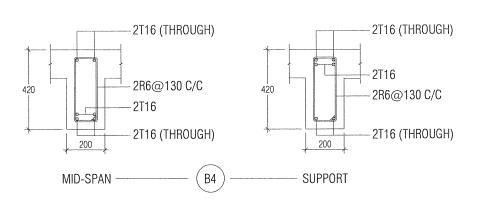


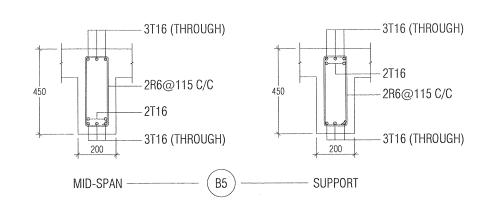

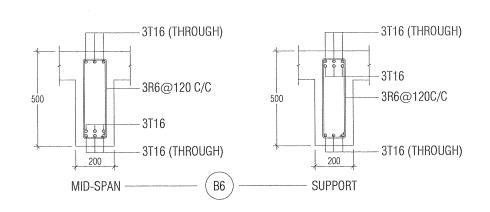

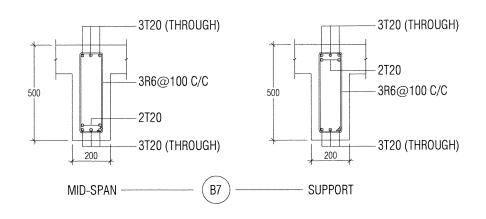

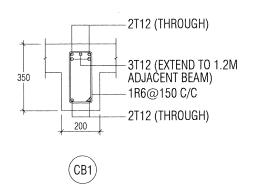

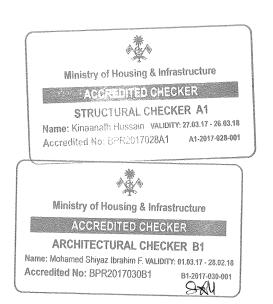

MID-SPAN	SUPPORT
LENGTH	LENGTH
= 0.80 X SPAN	= 0.35 X SPAN

RC NOTE:

- 1. ALL CONCRETE ELEMENTS DESIGN CONFORMS TO BS8110.
- 2. MINIMUM COMPRESSIVE STRENGTH OF CONCRETE TO BE 25N/sqmm.
- 3. CONCRETE MIX RATIO 1:2:3
- 4. MAIN REINFORCEMENT STEEL TO BE HIGH STRENGTH DEFORMED BARS.
- 5. RIVER SAND AND GRANITE TO BE USED AS AGGREGATES.
- 6. USE WATER FREE OF SALT AND ANY OTHER IMPURITIES.
- 7. ALL REINFORCEMENT SHALL BE SUPPORTED IN ITS CORRECT POSITION WHEN CONCRETING BY USING SPACERS.
- 8. LAPS = $45 \, \emptyset$, BENDS AT END SUPPORT = $12 \, \emptyset$ (\emptyset = BAR DIAMETER)
- 9. PROPS TO BEAMS SPANNING UP TO 6M SHOULD BE REMOVED A MINIMUM OF 21 DAYS AFTER CONCRETING AND PROPS TO BEAMS SPANNING OVER 6M SHOULD BE REMOVED 28 DAYS AFTER CONCRETING.
- 10. COVER TO REINFORCEMENT AS GIVEN BELOW UNLESS NOTED OTHERWISE

FOOTING = 50MMTIE BEAMS =40MM

FLOOR BEAMS = 40MM (TOP, BOT) 40MM (SIDES) ROOF BEAMS = 40MM (TOP, BOT) 40MM (SIDES)

COLUMN = 40MM

= 25MM (TOP, BOT)

NOVAstudio


contractors shall work from figured dimensions only. discrepancies must be reported immediately to the architects. ust check all dimensions on site.


contractors must check
sheet title: STRUCTURAL DETAILS
DETAILED DESIGN, STRUCTURAL DRAWINGS


revision:	architect:	SHIYAZ	str.eng:	SAMNOON
A 17.08.15 D B 01.09.15 E	int.designer:		serv.eng:	ARIF
C 28.05.17 F	checked by:	SHIYAZ	drw by:	SHIYAZ


| project title: PROPOSED FOUR STOREY BUILDING client


15-06-2013 |date: CUSTOM OFFICE AND ACCOMODATION, HDH. KULHUDHUFFUSHI project no: CUS01-A01-301 sheet no: MALDIVES CUSTOMS SERVICE E-08-12

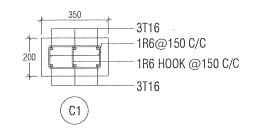

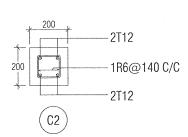

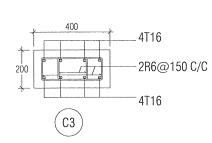

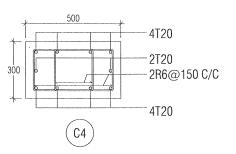

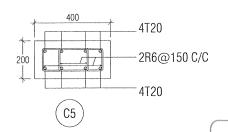




Ministry of Housing & Infrastructure


ACCREDITED CHECKER


ARCHITECTURAL CHECKER B1


Name: Mohamed Shiyaz Ibrahim F. VALIDITY: 01.03.17 - 28.02.18 Accredited No: BPR2017030B1


81-2017-030-001

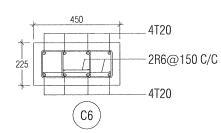

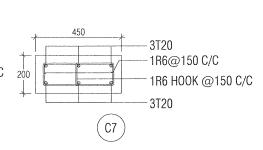


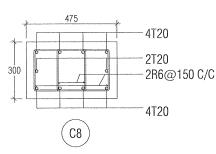


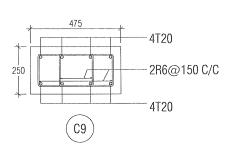


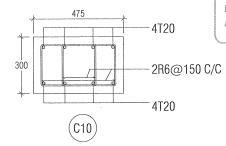


APPLY TWO LAYERS OF DAMP PROOFING AGENT TO ALL SURFACES OF CONCRETE THAT COMES BELOW NATURAL GROUND LEVEL.

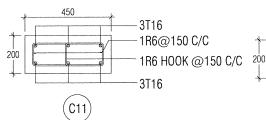

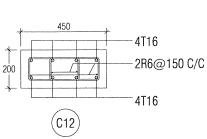

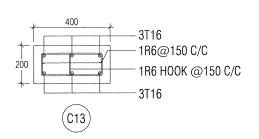

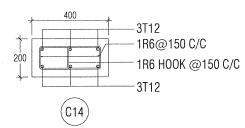



Ministry of Housing & Infrastructure

ACCREDITED CHECKER

STRUCTURAL CHECKER A1

Name: Kinaanath Hussain VALIDITY: 27.03.17 - 26.03.18 Accredited No: BPR2017028A1 A1-2017-028-001 RC NOTE:

- 1. ALL CONCRETE ELEMENTS DESIGN CONFORMS TO BS8110. 2. MINIMUM COMPRESSIVE STRENGTH OF CONCRETE TO BE 25N/sqmm.
- 3. CONCRETE MIX RATIO 1:2:3
- 4. MAIN REINFORCEMENT STEEL TO BE HIGH STRENGTH DEFORMED BARS.
- 5. RIVER SAND AND GRANITE TO BE USED AS AGGREGATES.
- 6. USE WATER FREE OF SALT AND ANY OTHER IMPURITIES.
- 7. ALL REINFORCEMENT SHALL BE SUPPORTED IN ITS CORRECT POSITION WHEN CONCRETING BY USING SPACERS.
- 8. LAPS = $45 \, \emptyset$, BENDS AT END SUPPORT = $12 \, \emptyset$ (\emptyset = BAR DIAMETER)
- 9. PROPS TO BEAMS SPANNING UP TO 6M SHOULD BE REMOVED A MINIMUM OF 21 DAYS AFTER CONCRETING AND PROPS TO BEAMS SPANNING OVER 6M SHOULD BE REMOVED 28 DAYS AFTER CONCRETING.
- 10. COVER TO REINFORCEMENT AS GIVEN BELOW UNLESS NOTED OTHERWISE

FOOTING = 50MM

TIE BEAMS = 40MM

FLOOR BEAMS = 40MM (TOP, BOT) 40MM (SIDES)

ROOF BEAMS = 40MM (TOP, BOT) 40MM (SIDES)

= 40MM

COLUMN SLAB = 25MM (TOP, BOT)

NOVAstudio

contractors shall work from figured dimensions only. discrepancies must be reported immediately to the architects. contractors must check all dimensions on site.

sheet title: STRUCTURAL DETAILS

DETAILED DESIGN, STRUCTURAL DRAWINGS


revision:	architect:	SHIYAZ	str.eng:	SAMNOON	_ project
A 17.08.15 D B 01.09.15 E	int.designer:		serv.eng:	ARIF	' '
C 28.05.17 F	checked by:	SHIYAZ	drw by:	SHIYAZ	d client:

project title: PROPOSED FOUR STOREY BUILDING CUSTOM OFFICE AND ACCOMODATION, HDH. KULHUDHUFFUSHI project no:

MALDIVES CUSTOMS SERVICE

15-06-2013 date CUS01-A01-301 sheet no: E-09-12

scale: COPYRIGHT: THE CONCEPT AND DESIGN IN THIS DRAWING ARE THE PROPERTIES OF NOVA STUDIO, UNAUTHORIZED USE OF ANY KIND OR COPYING OF WHOLE OR PART OF THIS DRAWING, CONCEPT OR DESIGN IN THIS DRAWING IS PROHIBITED AND APPLY AS TERMS AND CONDITIONS UNDER WHICH THE CLIENT IS ENTITLED TO USE THE CONCEPT OR DESIGN IN THIS DRAWING.

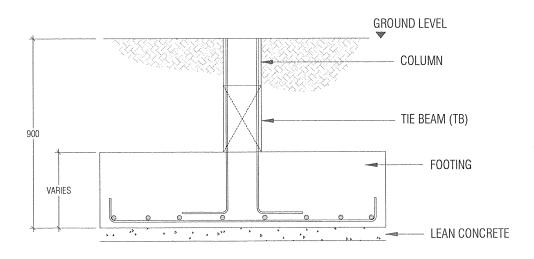

-2T12 (THROUGH) 1R6@150 C/C -2T12 (THROUGH)

TYPICAL FOUNDATION PAD DETAIL

FOR REINFORCEMENT REFER FOUNDATION PAD DETAILS

1			
PAD	SIZE/MM	DEPTH/MM	REINFORCEMENT
F1	3900X2300	450	T16@75MM C/C BW T/B
F2	1600X1600	300	T10@150MM C/C BW
F3	2000X2000	400	T12@150MM C/C BW
F4	2200X2200	450	T12@150MM C/C BW
F5	2300X2300	450	T12@150MM C/C BW
F6	2500X2500	450	T16@175MM C/C BW
F7	2850X2850	450	T16@150MM C/C BW
F8	3900X2400	450	T16@175MM C/C BW T/B
F9	3900X2000	450	T16@175MM C/C BW T/B

FOOTING DETAILS





APPLY TWO LAYERS OF DAMP PROOFING AGENT TO ALL SURFACES OF CONCRETE THAT COMES BELOW NATURAL GROUND LEVEL

- 1. ALL CONCRETE ELEMENTS DESIGN CONFORMS TO BS8110.
- 2. MINIMUM COMPRESSIVE STRENGTH OF CONCRETE TO BE 25N/sqmm.
- 3. CONCRETE MIX RATIO 1:2:3
- 4. MAIN REINFORCEMENT STEEL TO BE HIGH STRENGTH DEFORMED BARS.
- 5. RIVER SAND AND GRANITE TO BE USED AS AGGREGATES.
- 6. USE WATER FREE OF SALT AND ANY OTHER IMPURITIES.
- 7. ALL REINFORCEMENT SHALL BE SUPPORTED IN ITS CORRECT POSITION WHEN CONCRETING BY USING SPACERS.
- 8. LAPS = 45 \emptyset , BENDS AT END SUPPORT = 12 \emptyset (\emptyset = BAR DIAMETER)
- 9. PROPS TO BEAMS SPANNING UP TO 6M SHOULD BE REMOVED A MINIMUM
 OF 21 DAYS AFTER CONCRETING AND PROPS TO BEAMS SPANNING OVER 6M SHOULD BE REMOVED 28 DAYS AFTER CONCRETING.
- 10. COVER TO REINFORCEMENT AS GIVEN BELOW UNLESS NOTED OTHERWISE

FOOTING = 50MM

FLOOR BEAMS = 40MM (TOP, BOT) 40MM (SIDES)

ROOF BEAMS = 40MM (TOP, BOT) 40MM (SIDES)

COLUMN = 40MM SLAB

= 25MM (TOP, BOT)

NOVAstudio

contractors shall work from figured dimensions only. discrepancies must be reported immediately to the architects. contractors must check all dimensions on site.

sheet title: STRUCTURAL DETAILS DETAILED DESIGN, STRUCTURAL DRAWINGS


re	visio	n:		
A	17.08.	15	D	
R	01 00	15	E	

evision:	architect:	SHIYAZ	str.eng:	SAMNOON
17.08.15 D 01.09.15 E	int.designer:		serv.eng:	ARIF
28.05.17 F	checked by:	SHIYA7	drw by:	SHIYAZ

client:

project title: PROPOSED FOUR STOREY BUILDING CUSTOM OFFICE AND ACCOMODATION, HDH. KULHUDHUFFUSHI Project no: MALDIVES CUSTOMS SERVICE

15-06-2013 date CUS01-A01-301 sheet no: E-10-12

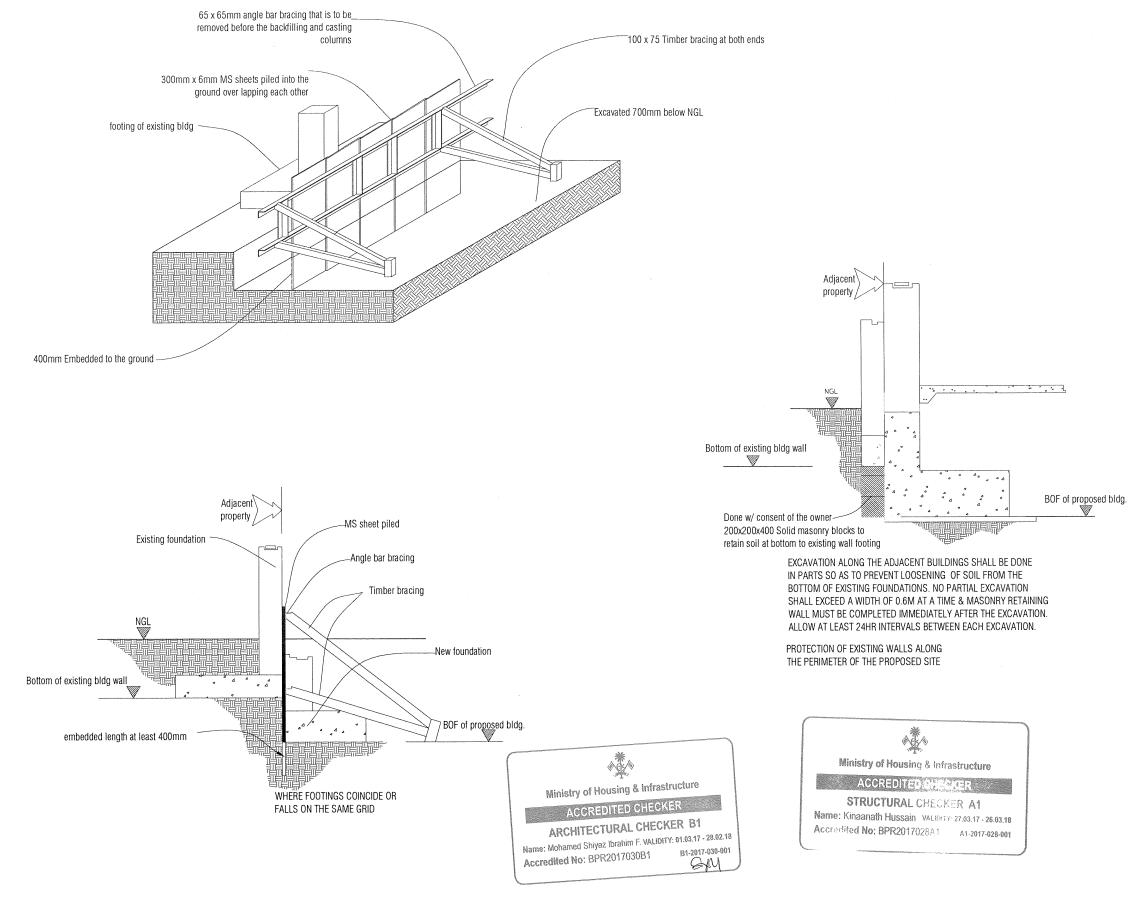



SHORING DETAILS SCALE 1:50

0.5m

contractors shall work from figured dimensions only. discrepancies must be reported immediately to the architects. contractors must check all dimensions on site.

15-06-2013 SAMNOON project title: PROPOSED FOUR STOREY BUILDING date revision: SHIYAZ str.eng: sheet title: SHORING DETAILS | architect: CUSTOM OFFICE AND ACCOMODATION, HDH. KULHUDHUFFUSHI Project no: CUS01-A01-301 int.designer: serv.eng: DETAILED DESIGN, STRUCTURAL DRAWINGS sheet no: MALDIVES CUSTOMS SERVICE E-11-12 SHIYAZ ^lchecked by: I drw by: scale:

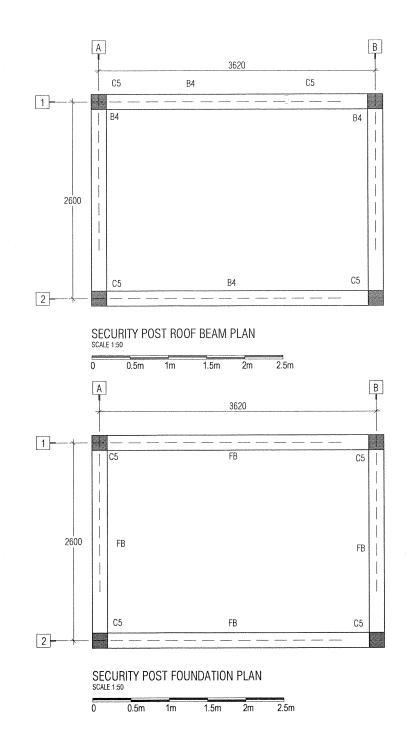

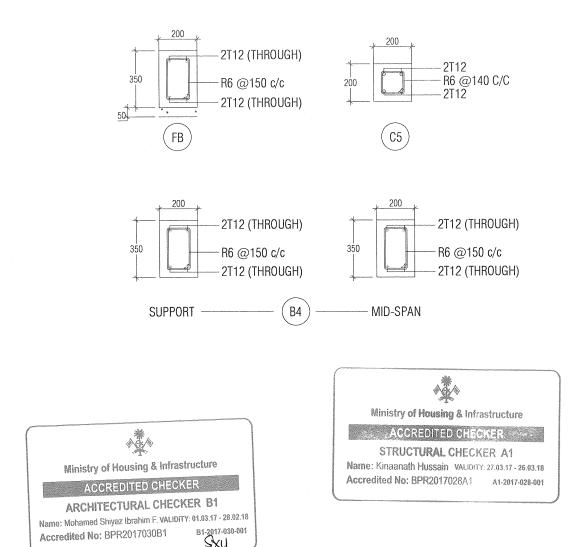

SECURITY POST STRUCTURAL DETAILS SCALE 1:50

0 0.5m 1m 1.5m 2m 2.5

NOVAstudio

contractors shall work from figured dimensions only. discrepancies must be reported immediately to the architects. contractors must check all dimensions on site.

sheet title: SECURITY POST STRUCTURAL DETAILS	
DETAILED DESIGN, STRUCTURAL DRAWINGS	

revision:	architect:	SHIYAZ	str.eng:	SAMNOON
A 17.08.15 D B 01.09.15 E	int.designer:		serv.eng:	ARIF
C 28.05.17 F	checked by:	SHIYAZ	drw by:	SHIYAZ

project title: PROPOSED FOUR STOREY BUILDING date:
CUSTOM OFFICE AND ACCOMODATION, HDH. KULHUDHUFFUSHI

MALDIVES CUSTOMS SERVICE

date: 15-06-2013 projectno: CUS01-A01-301 sheetno: E-12-12