

MINISTRY OF ENVIRONMENT AND ENERGY

REPUBLIC OF MALDIVES

TENDER DRAWINGS

01 MARCH 2016

PROJECT:


PROVISION OF WATER SUPPLY FACILITIES IN B. EYDHAFUSHI, MALDIVES


CONSULTANT:



OWG. NOS	DRAWING TITLES
GENERAL	·
BE-WS-100	LIST OF DRAWINGS
WATER SUPPL	Y
BE-WS-101 (1 OF 2)	WATER SUPPLY LAYOUT-PART-A
BE-WS-101 (2 OF 2)	WATER SUPPLY LAYOUT-PART-B
BE-WS-102	RAIN WATER COLLECTION LAYOUT
BE-WS-103 (1 OF 2)	BRINE OUTFALL LAYOUT & SECTION
BE-WS-103 (2 OF 2)	BRINE OUTFALL DETAILS
BE-WS-104	INTEGRATED WATER SUPPLY NETWORK SCHEMATIC
BE-WS-105	RO PLANT LAYOUT
BE-WS-106	BRINE PUMP DETAILS
BE-WS-107	TUBE WELL DETAIL
BE-WS-109 (1 OF 4)	TYPICAL DETAILS-WATER SUPPLY - (SHEET-OI)
BE-WS-109 (2 OF 4)	TYPICAL DETAILS-WATER SUPPLY - (SHEET-02)
BE-WS-109 (3 OF 4)	TYPICAL DETAILS-WATER SUPPLY - (SHEET-03)
BE-WS-109 (4 OF 4)	TYPICAL DETAILS-WATER SUPPLY - (SHEET-04)
BE-WS-110	TYPICAL PIPE BENDING DETAILS
BE-WS-111	GRP WATER TANK
BE-WS-113	RO PLANT ADMIN BUILDING - FLOOR AND ROOF PLAN
BE-WS-114	RO PLANT ADMIN BUILDING - ELEVATIONS AND SECTION
BE-WS-115	RO PLANT ADMIN BUILDING - DOOR, WINDOW & EXHAUST FAN DETAILS
BE-WS-116	RO PLANT ADMIN BUILDING - SEWERAGE AND WATER SUPPLY LAYOUT
BE-WS-117	RO PLANT ADMIN BUILDING - STRUCTURAL DRAWINGS
BE-WS-119	REVERSE OSMOSIS UNIT STRUCTURAL PLANS
BE-WS-120	REVERSE OSMOSIS UNIT STRUCTURAL DETAIL \$ SCHEDULES
BE-WS-121	REVERSE OSMOSIS UNIT DETAILS

LIST OF DRAWINGS					
DWG. NOS	DRAWING TITLES				
ELECTRICAL					
BE-EL- I 00	RO PLANT ADMIN BUILDING ELECTRICAL LAYOUT				
BE-EL-101	RO PLANT BUILDING ELECTRICAL LAYOUT				
BE-EL- I 02	RO PLANT ELECTRICAL LAYOUT				
BE-EL-103	SCHEMATIC DIAGRAM FOR RO PLANT				
BE-EL- I 04	ELECTRICAL DB SCHEDULE				
BE-EL- I 05	ELECTRICAL TYPICAL DETAILS				

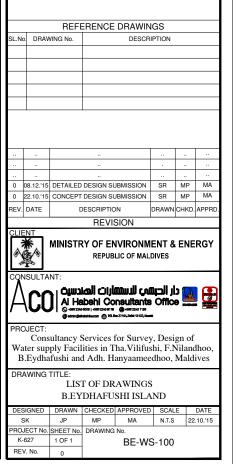

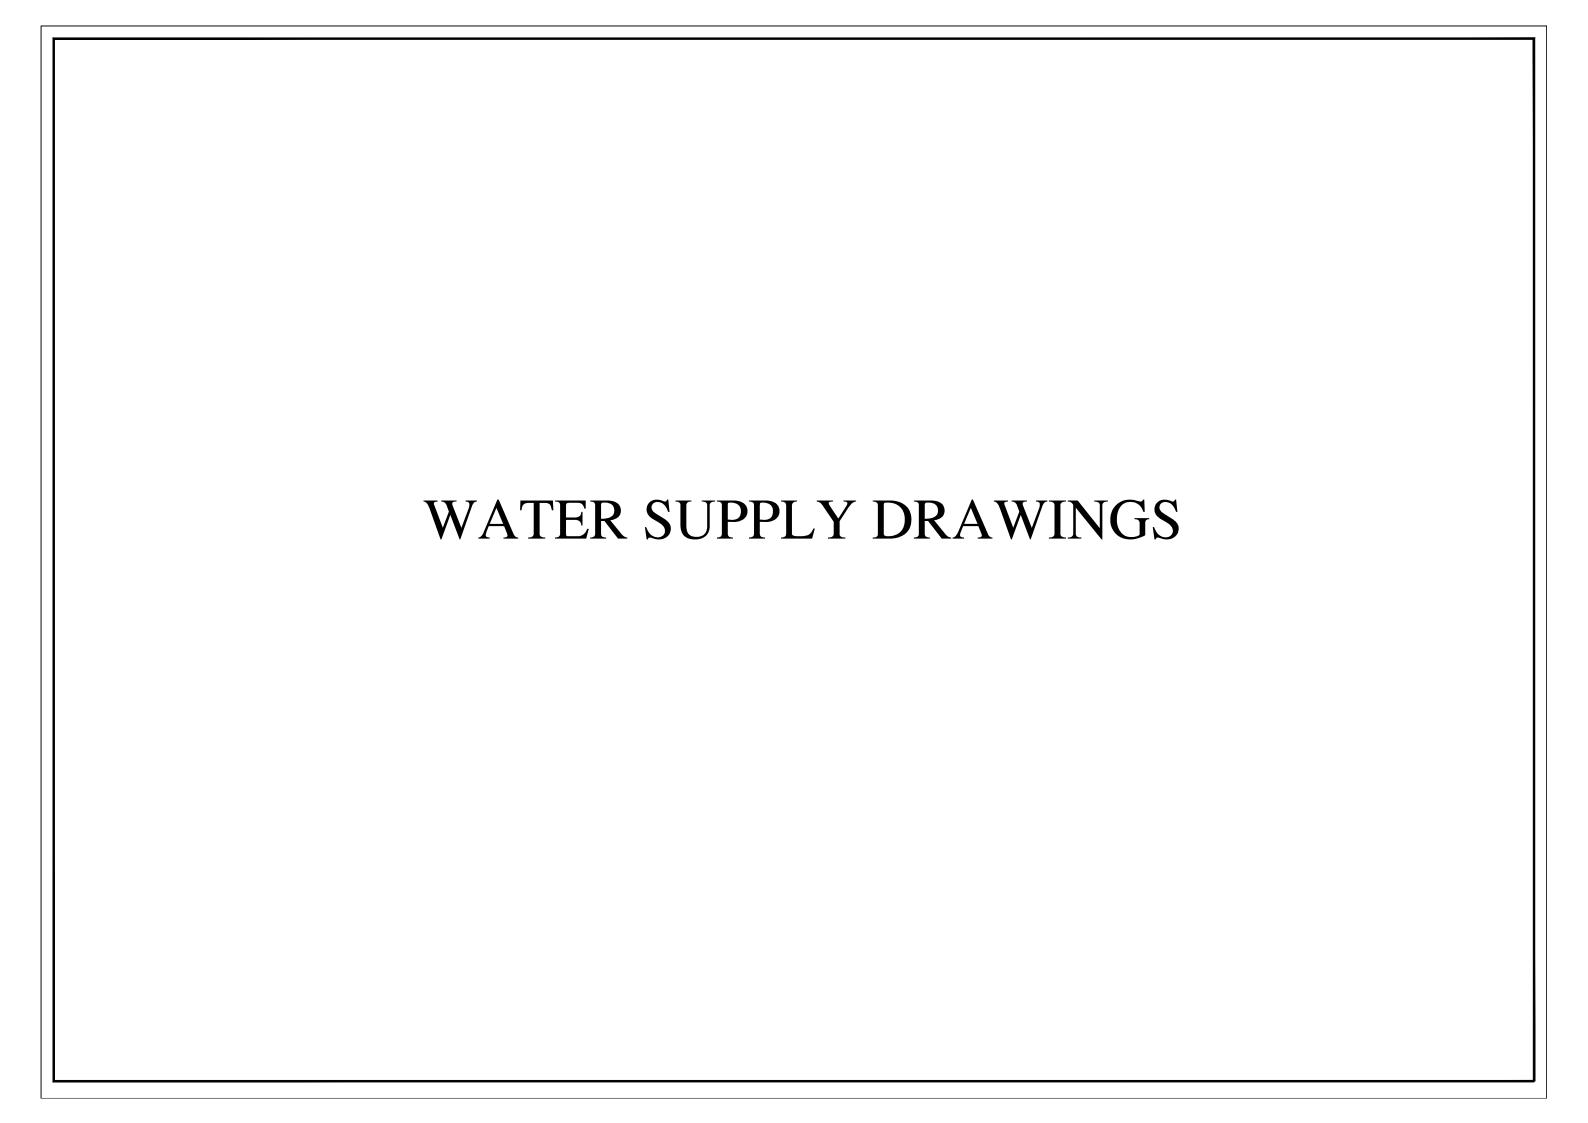











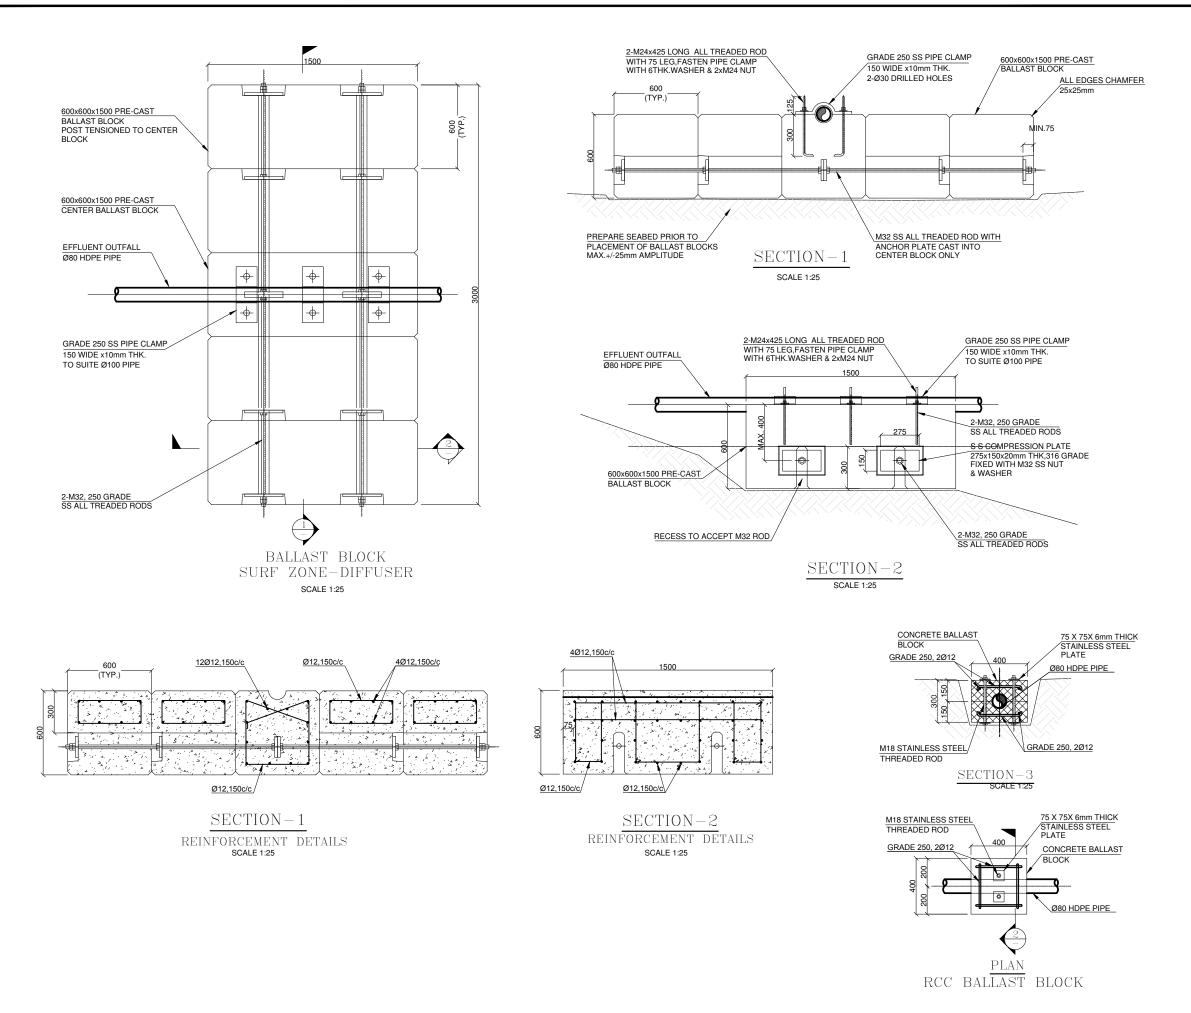


NOTES:-

. ALL DIMENSIONS SHOWN ARE IN MILLIMETERS (MM)


2. THIS DRAWING TO BE READ IN CONJUNCTION WITH ALL OTHER

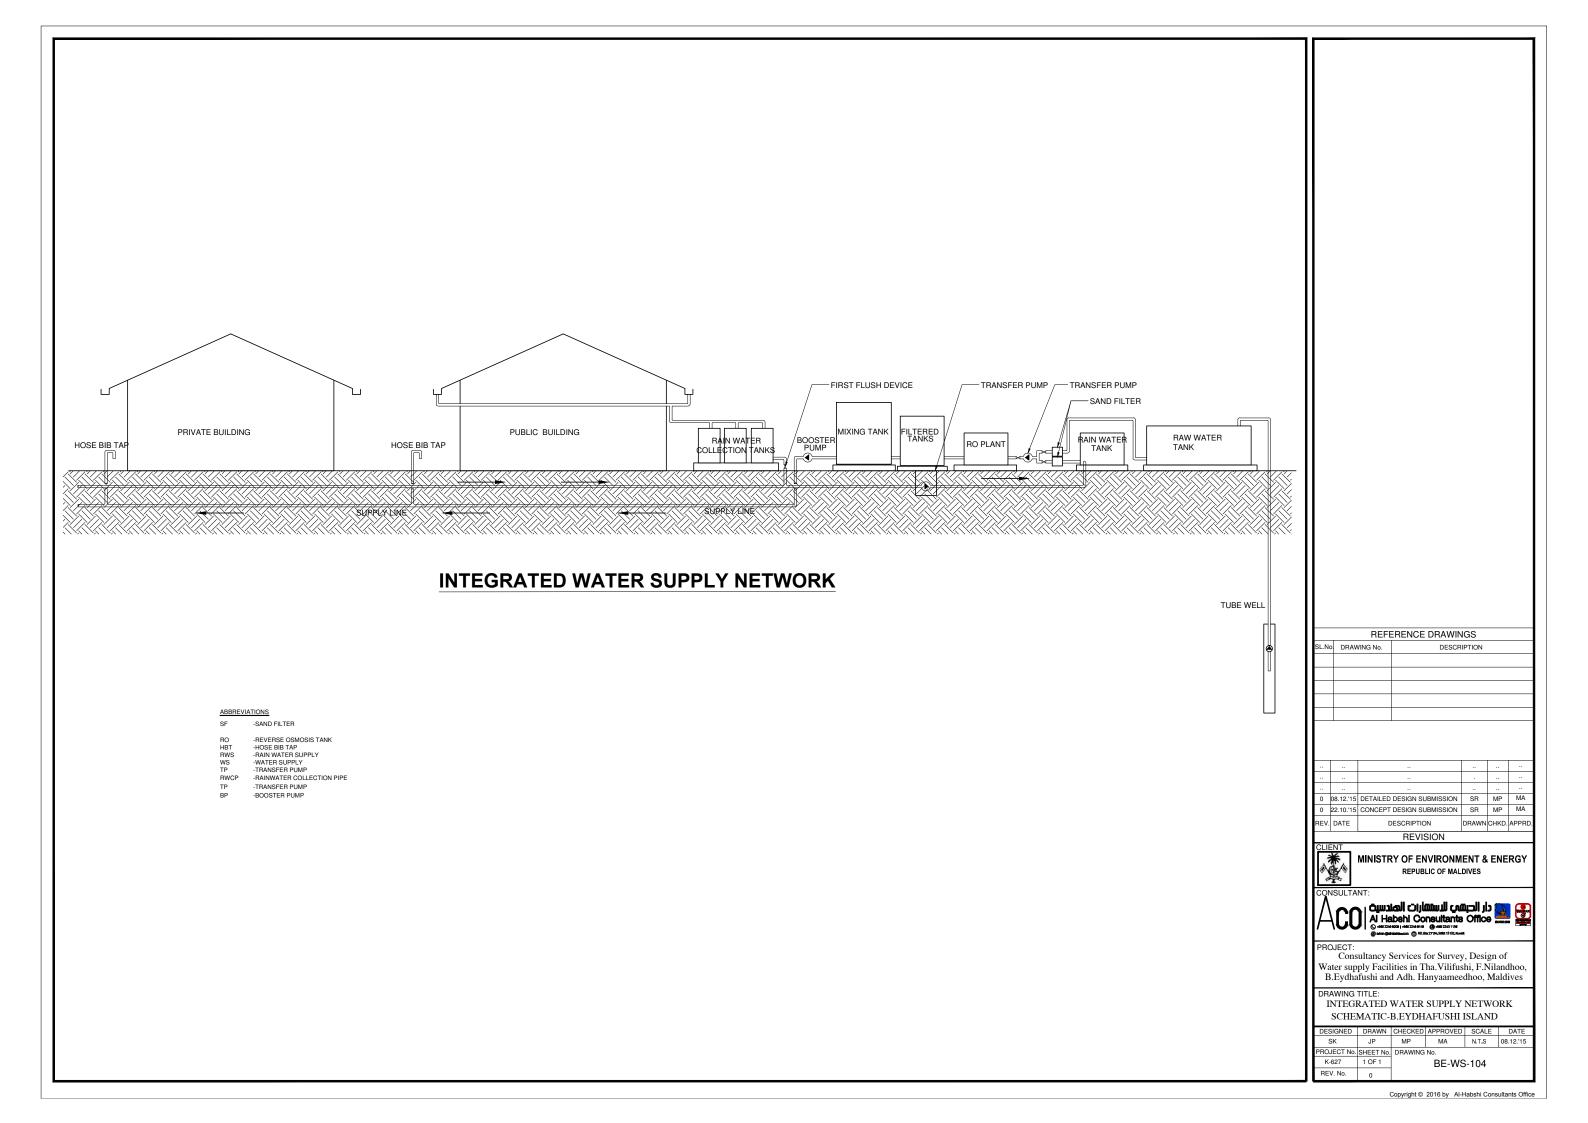

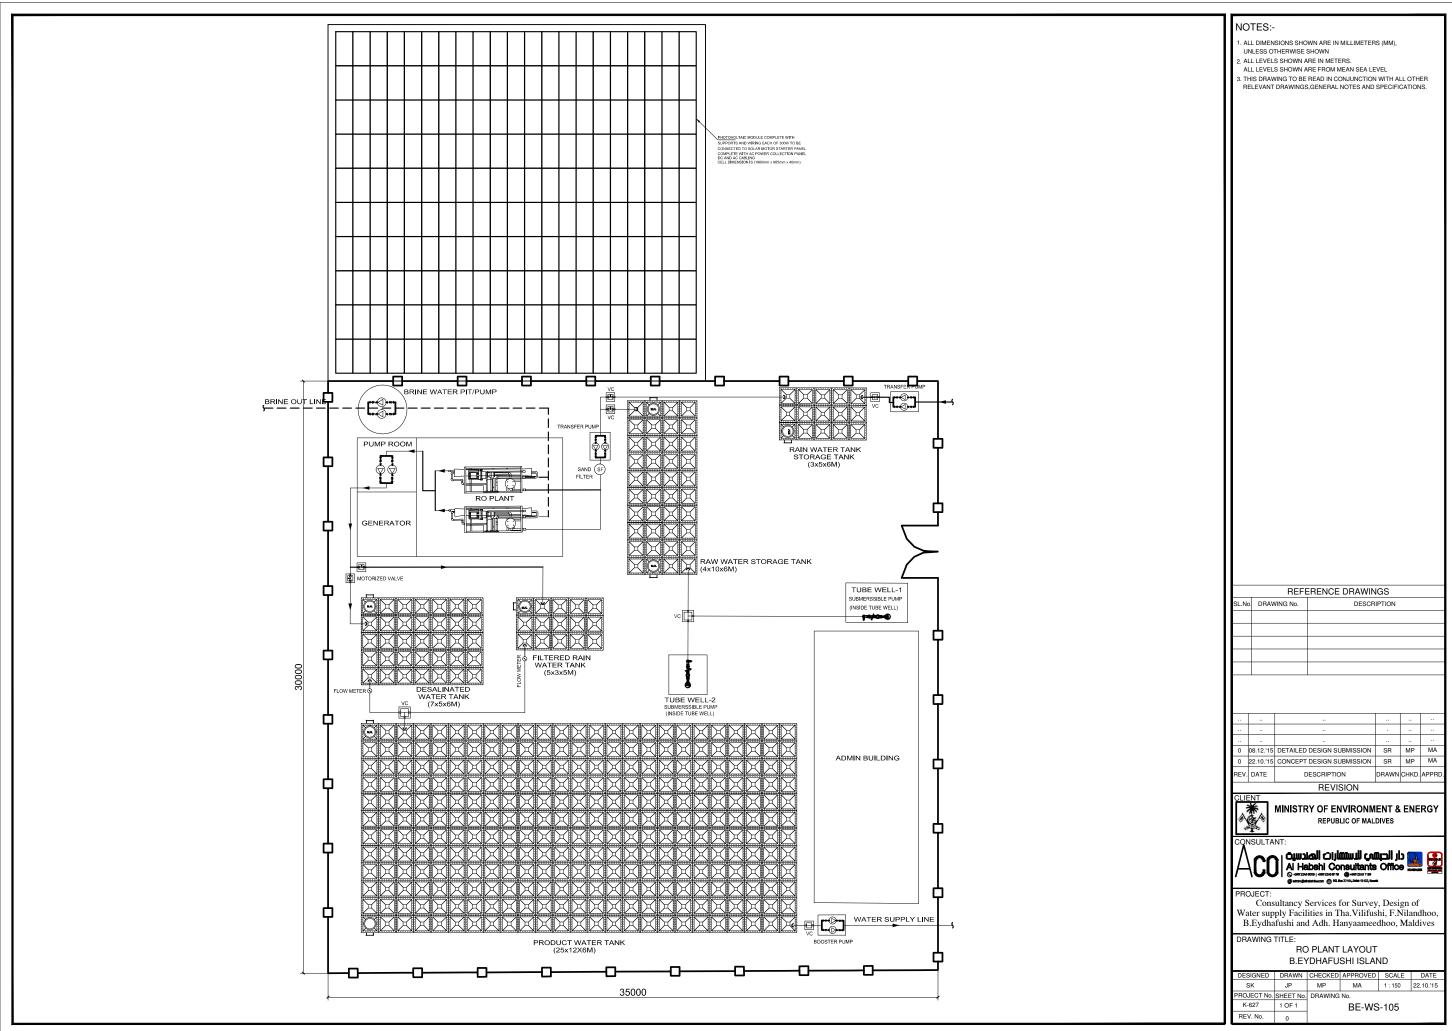

ACCESS DOORS CENTERED OVER PUMPS \HDPE.PRESSURE LINE VALVE CHAMBER 250mm THK RCC VENT PIPE

BRINE PUMP DETAILS - PLAN

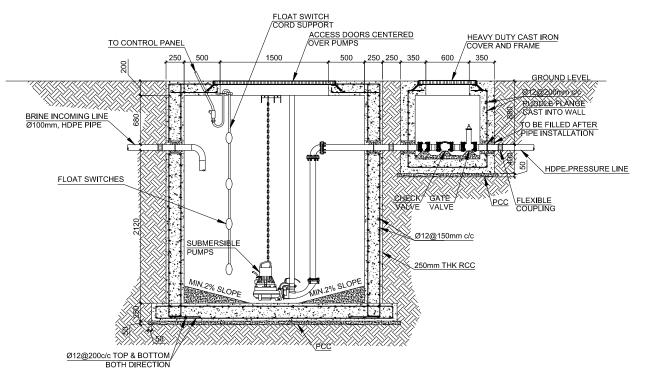

BRINE PUMP DETAILS - SECTION

NOTES:-

- 1. ALL DIMENSIONS SHOWN ARE IN MILLIMETERS (MM), UNLESS OTHERWISE SHOWN

- 2. ALL LEVELS SHOWN ARE IN METERS.
 ALL LEVELS SHOWN ARE FROM MEAN SEA LEVEL
- 3. THIS DRAWING TO BE READ IN CONJUNCTION WITH ALL OTHER RELEVANT DRAWINGS, GENERAL NOTES AND SPECIFICATIONS.

	REFERENCE DRAWINGS								
L.No.	DRAWING No.	DESCRIPTION							

0	08.12.'15	DETAILED DESIGN SUBMISSION	SR	MP	MA
0	22.10.'15	CONCEPT DESIGN SUBMISSION	SR	MP	MA
REV.	DATE	DESCRIPTION	DRAWN	CHKD.	APPRD.

REVISION




MINISTRY OF ENVIRONMENT & ENERGY REPUBLIC OF MALDIVES





Consultancy Services for Survey, Design of Water supply Facilities in Tha.Vilifushi, F.Nilandhoo, B.Eydhafushi and Adh. Hanyaameedhoo, Maldives


BRINE PUMP DETAILS B.EYDHAFUSHI ISLAND

ı	DESIGNED	DRAWN	CHECKED	APPROVED	SCALE	DATE			
ı	SK	JP	MP	MA	1:50	08.12.'15			
ı	PROJECT No.	SHEET No.	. DRAWING No.						
	K-627	1 OF 1	BE-WS-106						
ı	REV No		BE 110 100						

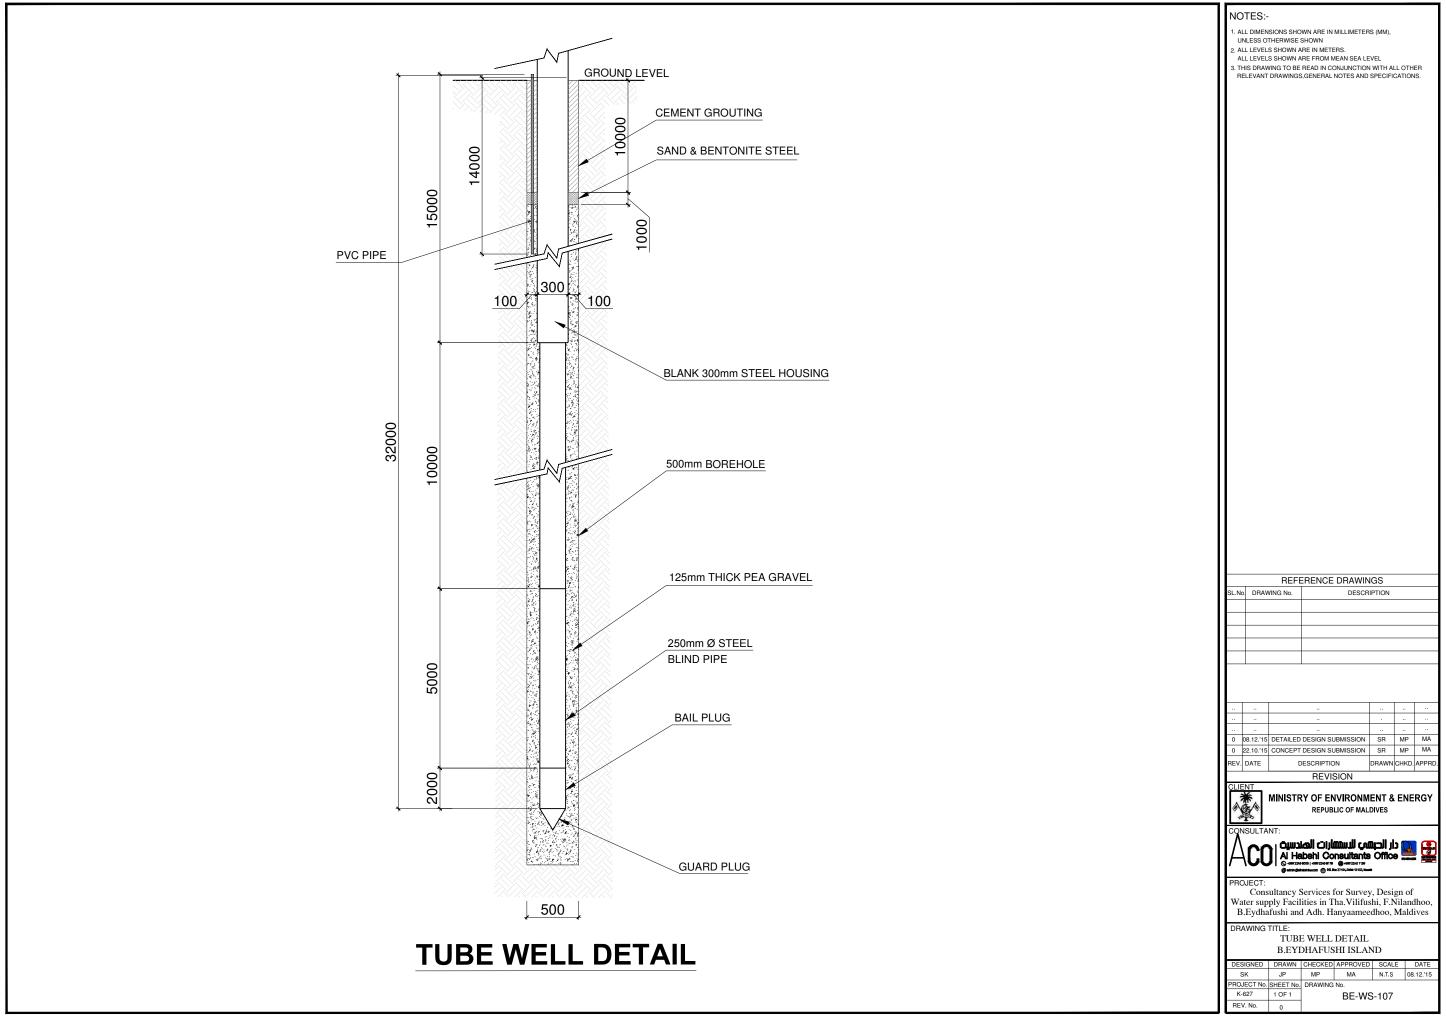

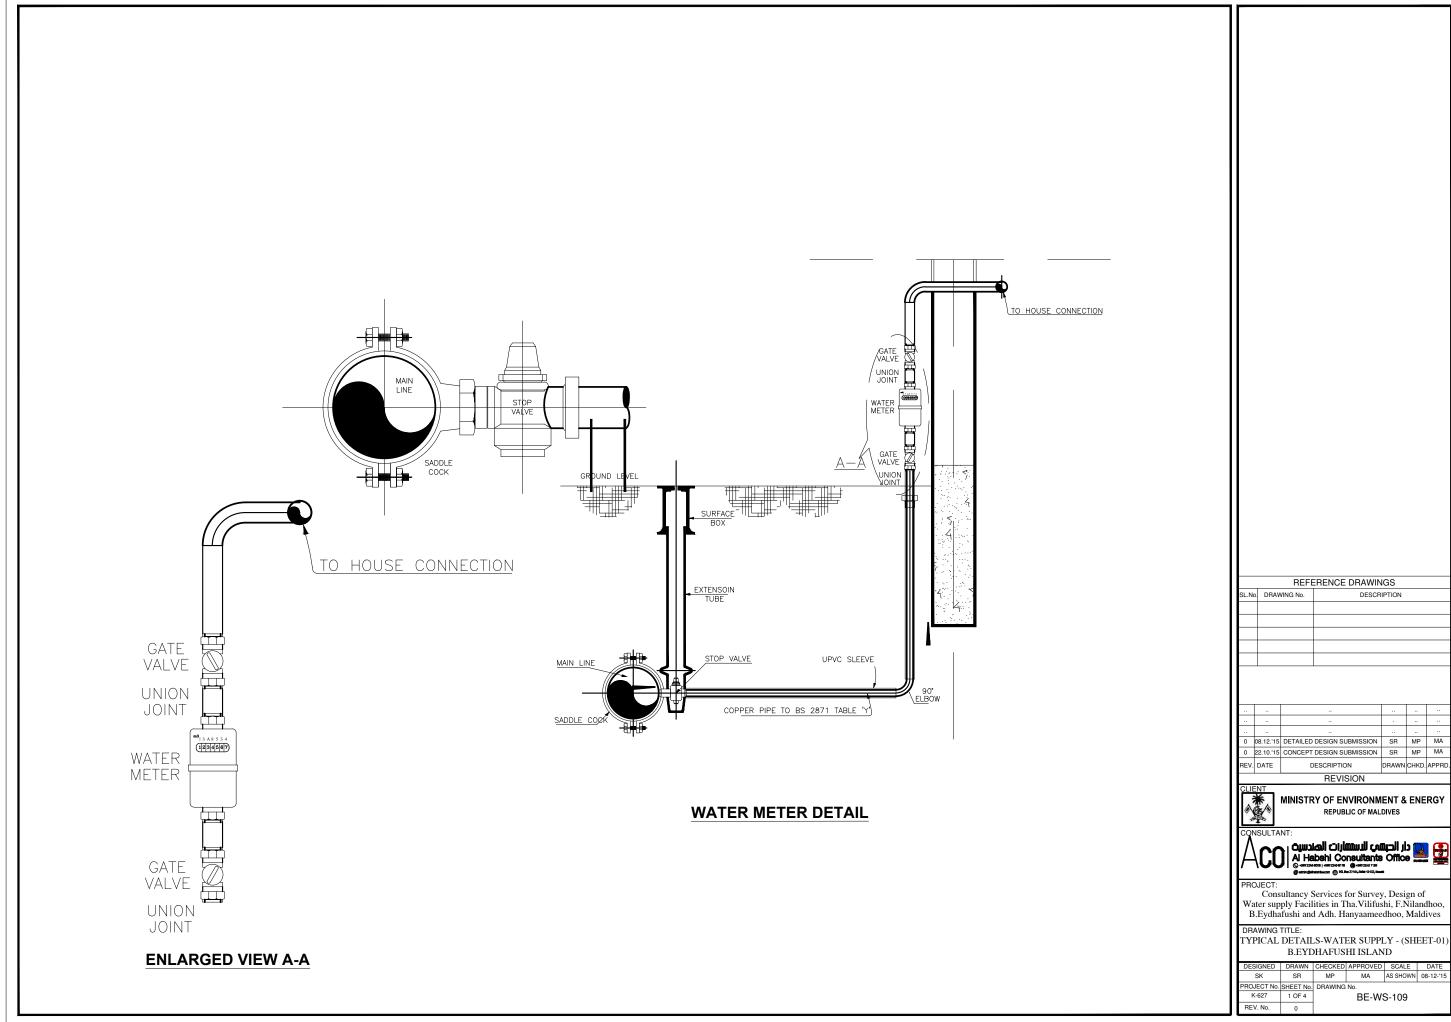

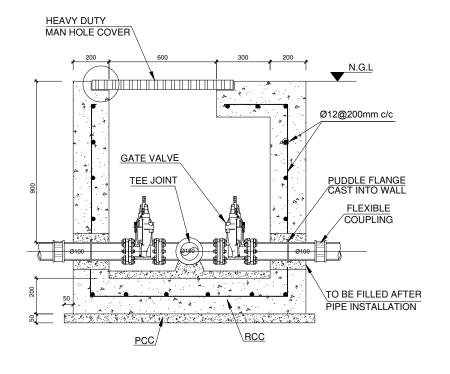

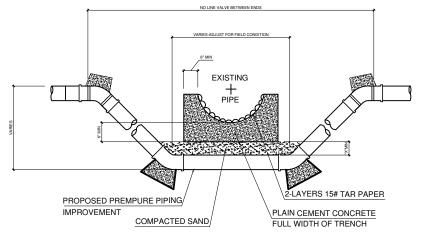

PIPE CROMPING DETAIL


"X" DIMENSION REQUIRMENTS

- A 6" FOR (GAS & OBT LINE CROMPING W/NO CRADLE NEEDED)
- B 18" FOR STORM SEWER PIPE
- C IF CROMPING SPACE IS MORE THAN MIN.SPACE OF CRADLE BELOE PIPE BOTTOM PLUS AFORMENTIONED "X" DIMENSION THEN EXTEND "X" DIMENSION TO MAKE UP DIFFERENCE.


CONCRETE CRADLE CONDITIONS

- A IF SANITORY OR SEWER PIPE JOINT IS WITHIN PROPOSED IMPROVEMENT TRENCH LIMIT
- B IF CROMPING SPACE IS LEMP THAN MIN.SPACE OF CRADLE BELOW PIPE BOTTOM PLUS "X" DIMENSION THEN OMIT SAND FILL AND USE CONCRETE


USE OF BENDS & THRUST BLOCKS OR JOINT DEFLECTION TO BE DETERMINED IN FIELD FOR EACH CROMPING

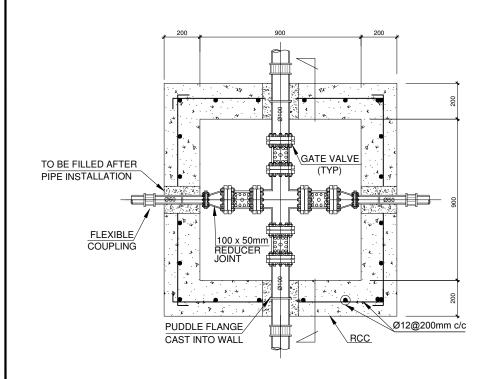

VALVE CHAMBER

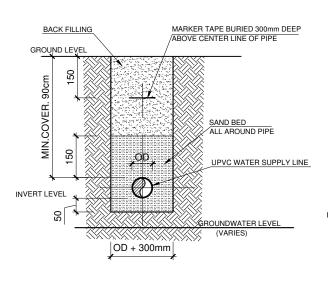

TYPICAL PIPE TRENCH DETAIL (WATER TABLE BELOW TRENCH BASE)

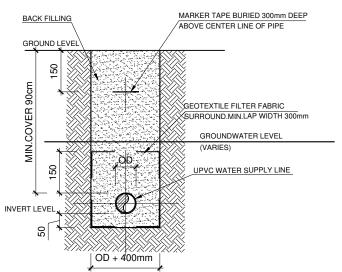

TYPICAL PIPE TRENCH DETAIL (WATER TABLE ABOVE TRENCH BASE)

REFERENCE DRAWINGS .No. DRAWING No.


0 08.12.'15 DETAILED DESIGN SUBMISSION SR MP MA 0 22.10.'15 CONCEPT DESIGN SUBMISSION SR MP MA REVISION


MINISTRY OF ENVIRONMENT & ENERGY REPUBLIC OF MALDIVES


Consultancy Services for Survey, Design of Water supply Facilities in Tha. Vilifushi, F.Nilandhoo, B.Eydhafushi and Adh. Hanyaameedhoo, Maldives

TYPICAL DETAILS-WATER SUPPLY - (SHEET-02 B.EYDHAFUSHI ISLAND


MP MA AS SHOWN 08-12-'1 K-627 2 OF 4 BE-WS-109

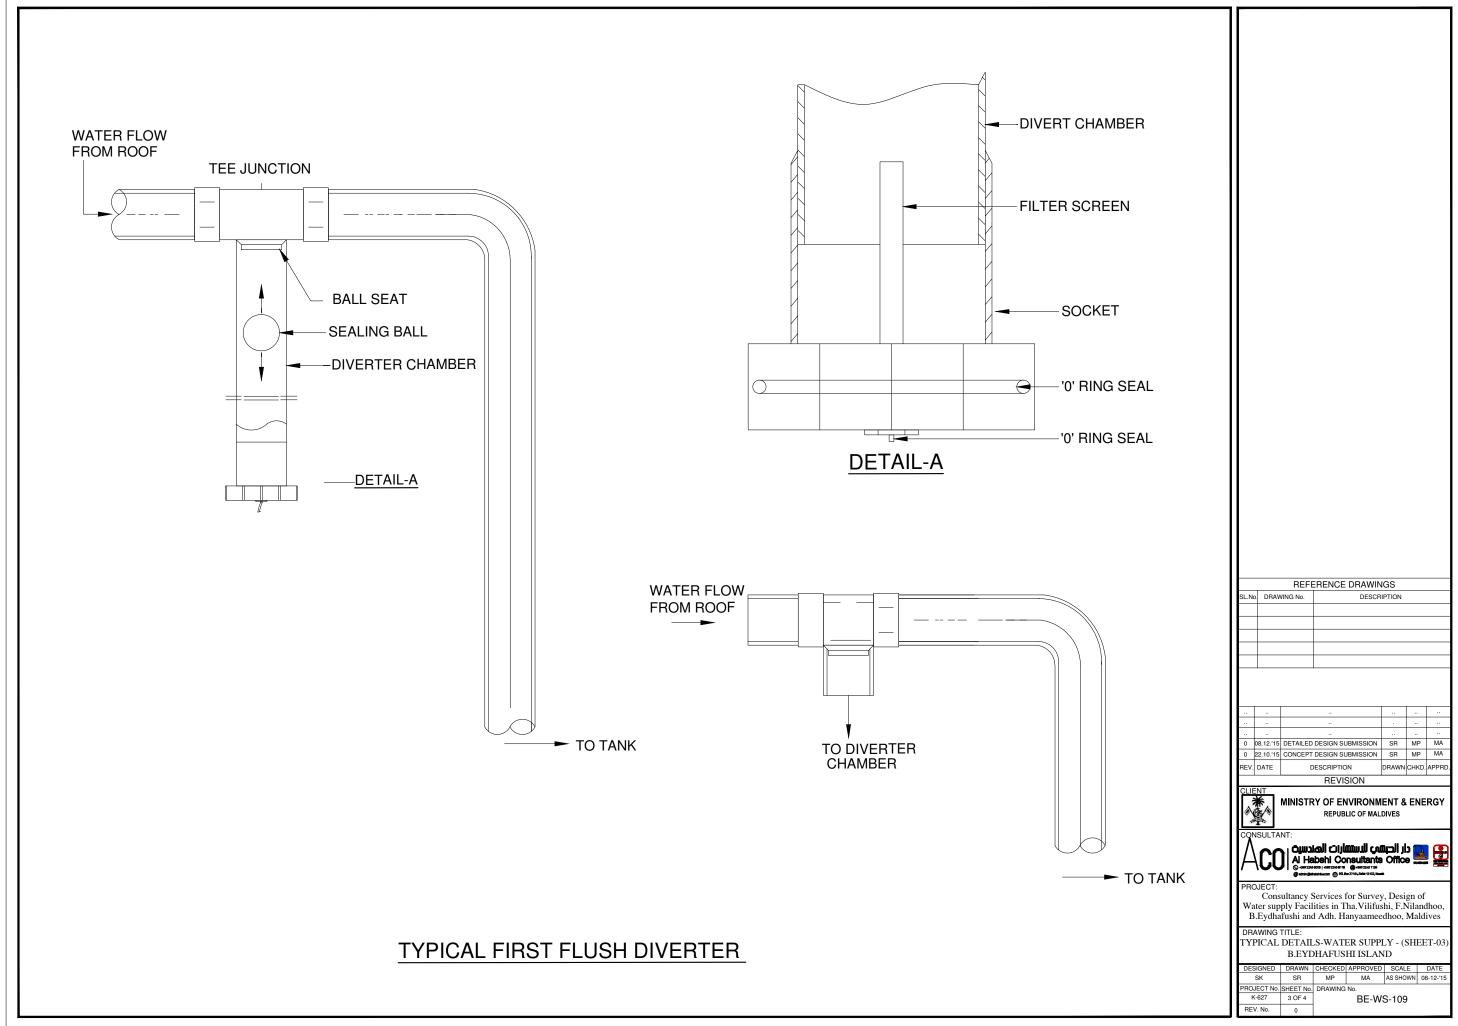

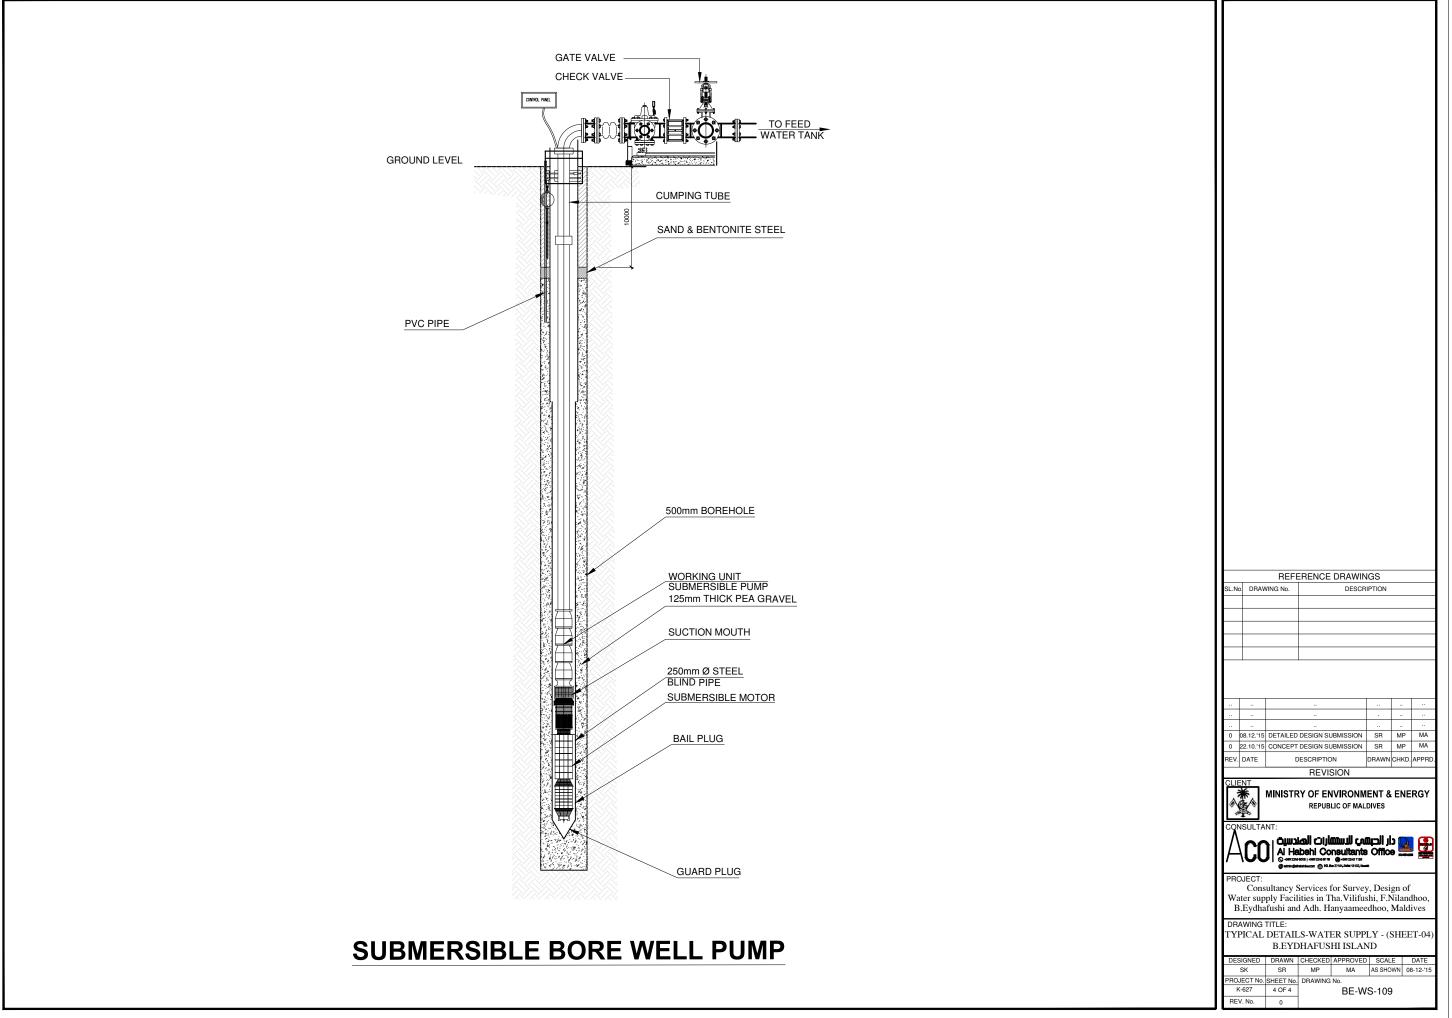


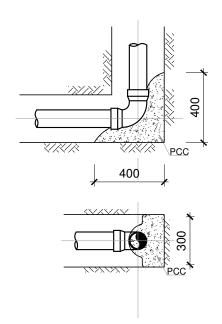




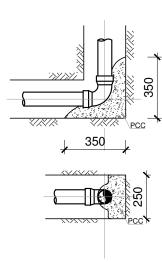


90° HORIZONTAL BEND (BTM) FOR Ø80 WS PIPE

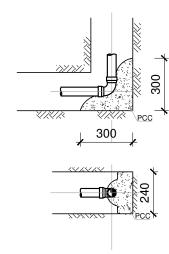


90° VERTICAL BEND (BTM) FOR Ø50 WS PIPE

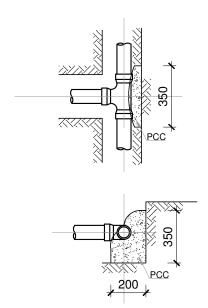



ANGLE BRANCH & TEE FOR Ø80 WS PIPE

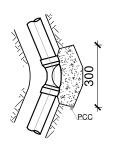

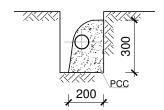

HORIZONTAL BEND FOR Ø80 WS PIPE

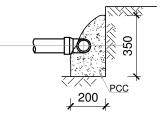


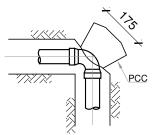

90° VERTICAL BEND (BTM) FOR Ø80 WS PIPE

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0	22.10.'15		DESIGN SUBMISSION	SR	MP	MA					
REV.	DATE		ESCRIPTION	DRAWN	CHKD.	APPRD					
			REVISION								
CON	MINISTRY OF ENVIRONMENT & ENERGY REPUBLIC OF MALDIVES CONSULTANT: At Habehi Consultants Office										
Wa	iter sup	ultancy S	1000 det 220 6119	y, Desi shi, F.I	gn of Vilano	lhoo,					


TYPICAL PIPE BENDING DETAILS B.EYDHAFUSHI ISLAND

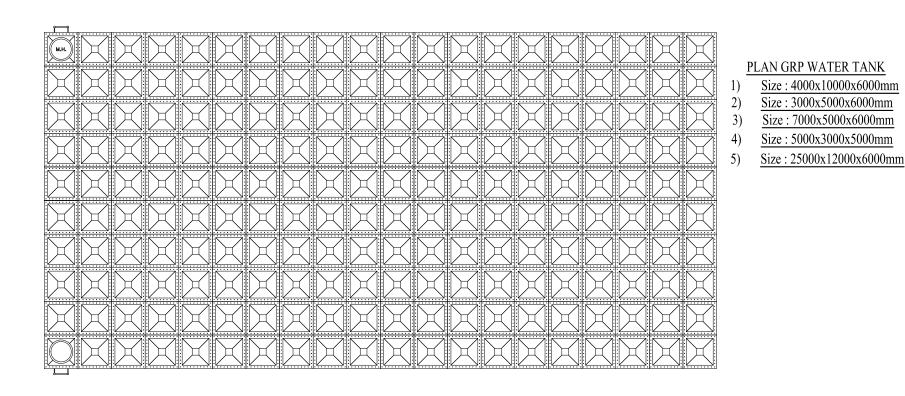

3. THIS DRAWING TO BE READ IN CONJUNCTION WITH ALL OTHER RELEVANT DRAWINGS, GENERAL NOTES AND SPECIFICATIONS.

I. ALL DIMENSION ARE IN MILLIMETER, UNLESS OTHERWISE

- 2. ALL LEVELS SHOWN ARE IN METERS.
- 4. THE DESIGN IS INDICATIVE ONLY, THE CONTRACTOR TO DESIGN & BUILD THE TANK TOWER STRUCTURE.
- 5 . WATER STOPS SHALL BE 210x9mm THICK MULTI-RIB TYPE WITH CANTER BULB FOR CONSTRUCTION, CONTROL AND EXPANSION JOINTS.

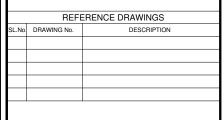

0 08.12.15 DETAILED DESIGN SUBMISSION SR MP MA 0 22.10.'15 CONCEPT DESIGN SUBMISSION SR MP MA DESCRIPTION REVISION





MINISTRY OF ENVIRONMENT & ENERGY REPUBLIC OF MALDIVES


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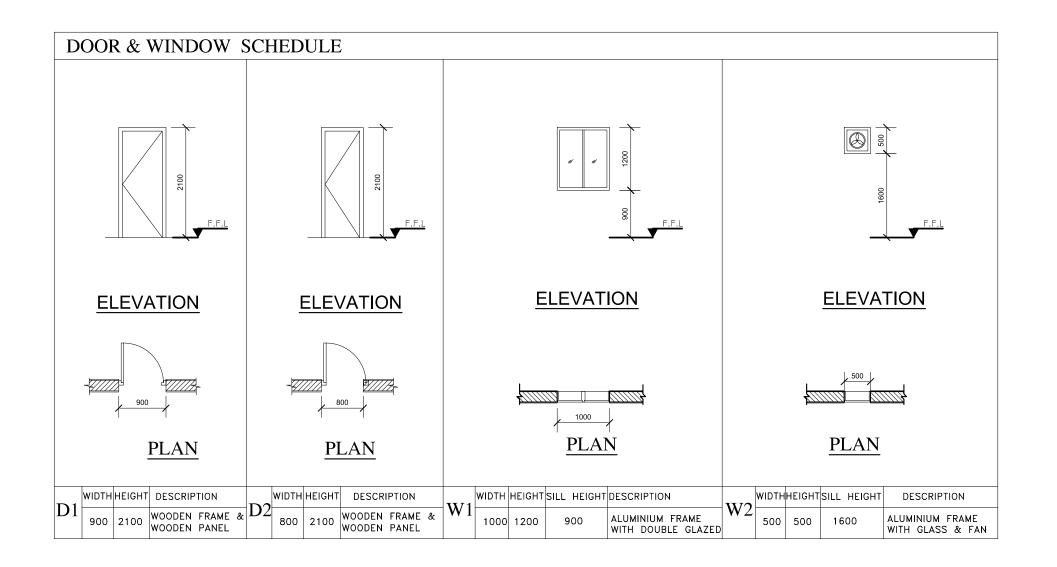
GRP WATER TANK B.EYDHAFUSHI ISLAND

DESIGNED	DRAWN	CHECKED	APPROVED	SCALE	DATE
SK	SR	MP	MA	AS SHOWN	08-12-'15
PROJECT No.	SHEET No.	DRAWING	No.		
K-627	1 OF 1		BE-WS	S-111	
REV. No.	0				




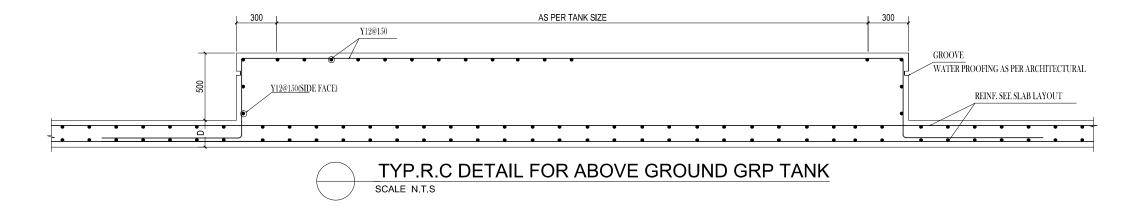

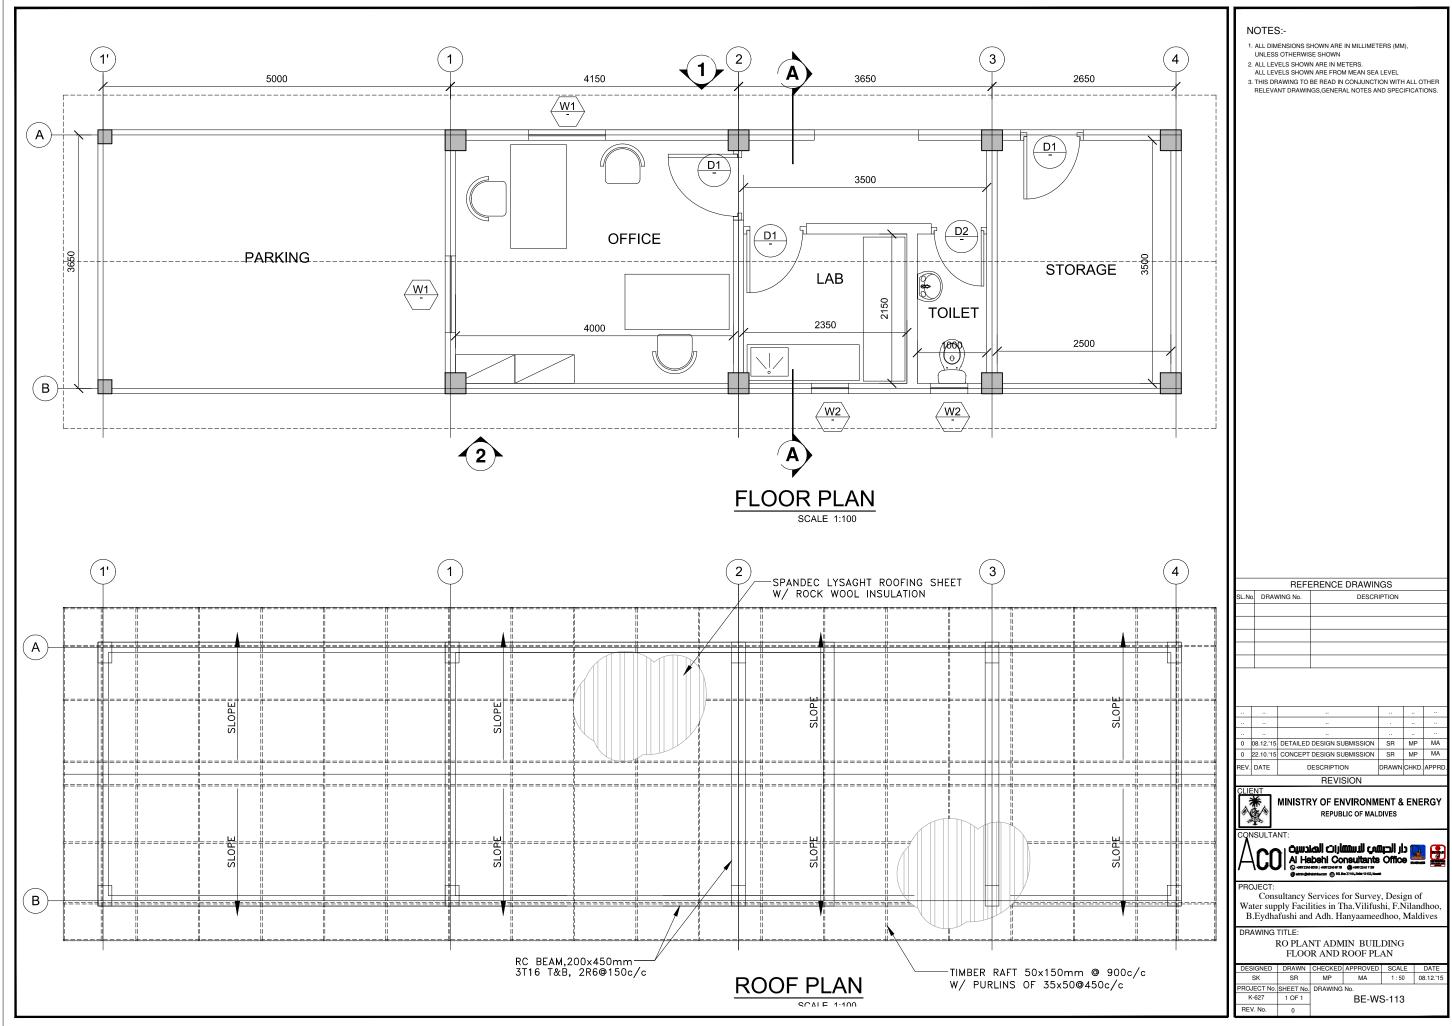

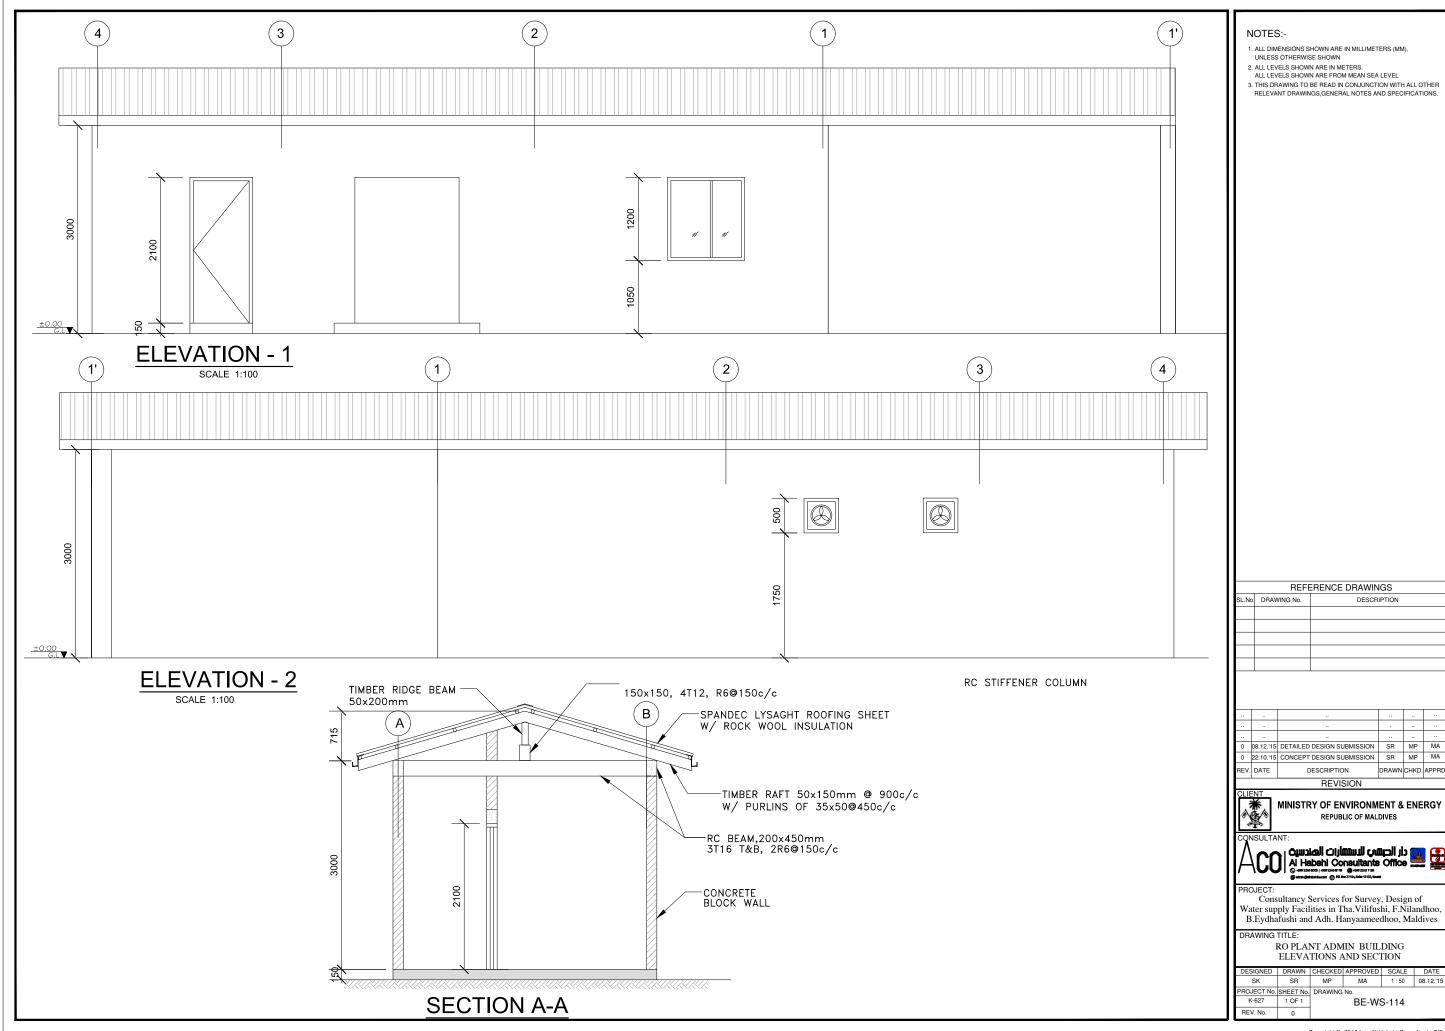

2. Stop EF at night time

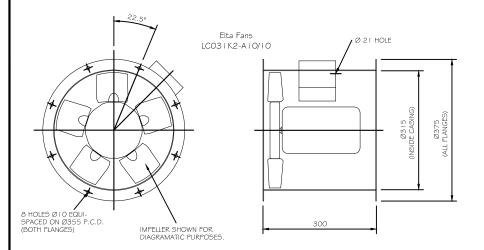

	FANS SCHEDULE										
REFERENCE	LOCATION	SERVICE	FLOW RATE	SP		POV	VER		FAN SPEED	FAN	REMARKS
	AREA	AREA	CFM	IWG	KW	VOLTS	PH	HZ	RPM	FAN TYPE	
EXF-1	LABORATORY	LABORATORY	120	0.5	0.25	230	1	50	1450	AXAL	
EXF-2	TOILET	TOILET	60	0.5	0.25	230	1	50	1450	AXAL	

TYP.EXHAUST FAN

EXHAUST FAN SCHEDULE


NOTES:-


- ALL DIMENSIONS SHOWN ARE IN MILLIMETERS (MM), UNLESS OTHERWISE SHOWN
 ALL LEVELS SHOWN ARE IN METERS.
 ALL LEVELS SHOWN ARE FROM MEAN SEA LEVEL
 THIS DRAWING TO BE READ IN CONJUNCTION WITH ALL OTHER RELEVANT DRAWINGS, GENERAL NOTES AND SPECIFICATIONS.


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ate	r sup	ply Facil	Services for Surve ities in Tha.Vilifu I Adh. Hanyaamee	shi, F.N	Vilano	lhoo, ives				
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BE-WS-115


PROJECT No. SHEET No. DRAWING K-627 1 OF 1



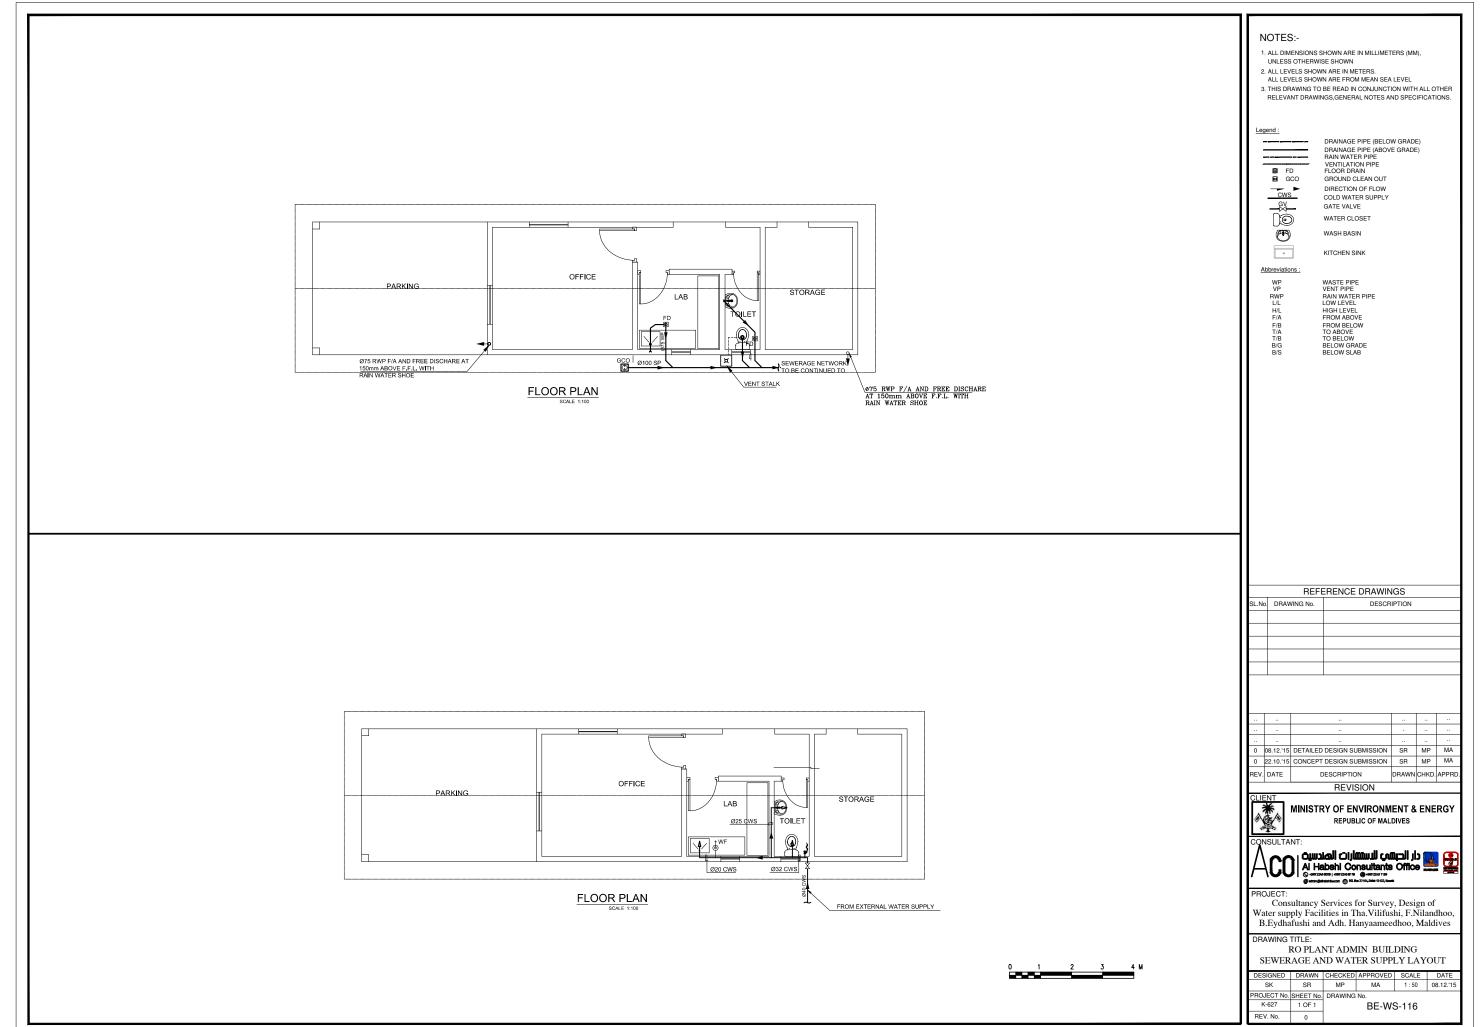

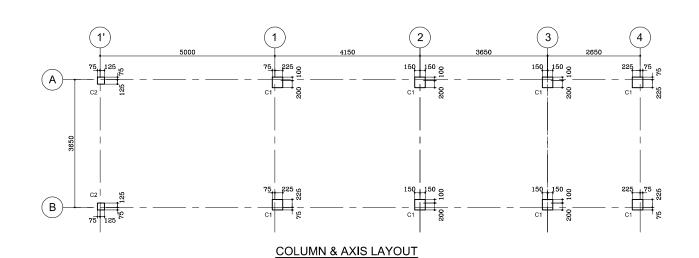

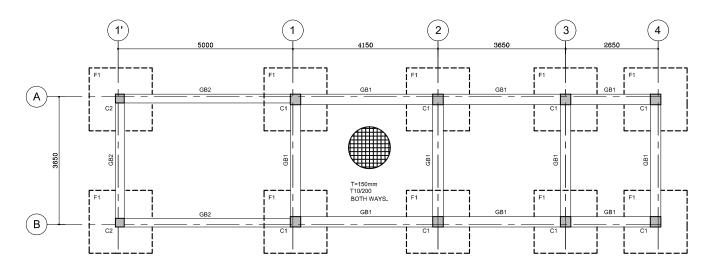FOOTING & GRADE BEAM LAYOUT

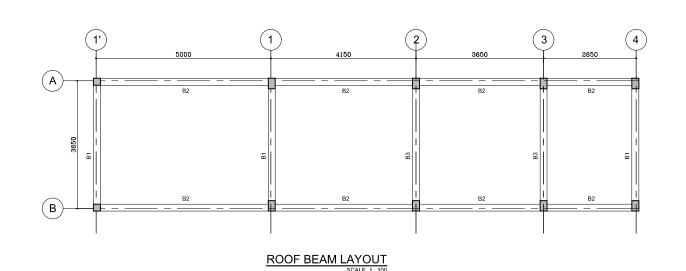



COLUMNS REINFORCEMENT DETAILS										
		FOL	JND	G	ROUND	FLOOR				
TYPE	SIZ	ZE	REINT.	SIZ	ZE.	REINT.	STIRRUPS			
C1	300	300	12T16	200	300	10T16	T8/125 c/c			
C2	250	250	8T16	200	200	4T16	T8/125 c/c			

MARK		DIMENSIO	REINFORCEMENT			
WARK	L	W	Н		BOXED	REMARKS
F1	1800	1800	400	T12@100 c/c B/W, T&B		

	GRADE BEAM REINFORCEMENT DETAILS										
MARK	SIZ	E	воттом	TOP	CTIPDUIDO	SIDE	DELLABOR				
IVIARK	b	h	BARS	BARS	STIRRUPS	BARS	REMARKS				
GB1	300	300	4T16	3T16	T6/125 c/c						
GB2	250	300	4T16	3T16	T6/125 c/c						

	BEAM REINFORCEMENT DETAILS										
MARK	MARK SIZE		BOTTOM BARS	TOP STIRRUPS		SIDE BARS	REMARKS				
	ь	h		BARS		BARS					
B1	200	500	5T16	3T16	T6/125 c/c						
B2	200	500	4T16	3T16	T6/125 c/c						
В3	200	500	5T16	3T16	T6/100 c/c						

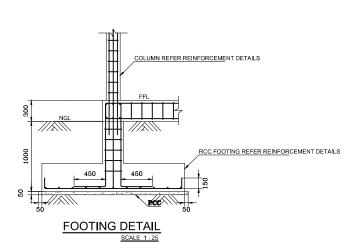

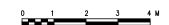

NOTES:-

- ALL DIMENSIONS SHOWN ARE IN MILLIMETERS (MM), UNLESS OTHERWISE SHOWN
 ALL LEVELS SHOWN ARE IN METERS.
 ALL LEVELS SHOWN ARE FROM MEAN SEA LEVEL

- 3. THIS DRAWING TO BE READ IN CONJUNCTION WITH ALL OTHER RELEVANT DRAWINGS, GENERAL NOTES AND SPECIFICATIONS.
- INVESTIGATION TO CONFORM THE BEARING CAPACITY OF S 150 KN / M²
 4. THE CONCRETE COVER TO ALL REINFORCEMENT SHALL BE
- 4. INE CONCENTE COVERT TO ALL REINFORCEMENT SHALL
 AS FOLLOW:
 COLUMN / BEAM = 40 mm
 SLAB = 30 mm
 FOUNDATION = 50 mm

 5. WATER CEMENT RATIO SHALL BE 0.50

 6. FOR ALL GENERAL NOTES REFER BY DWG UT-GN-01

- 7. GRADE OF CONCRETE IS M30 AND GRADE OF STEEL IS Fy 460

LEGEND:-

1. NGL - NATURAL GROUND LEVEL

2. FFL - FINISHED FLOOR LEVEL

3. PCC - PLAIN CEMENT CONCRETE

REFERENCE DRAWINGS SL.No. DRAWING No. DESCRIPTION

0 08.12.15 DETAILED DESIGN SUBMISSION SR MP MA 0 22.10.'15 CONCEPT DESIGN SUBMISSION SR MP MA

REV. DATE

MINISTRY OF ENVIRONMENT & ENERGY REPUBLIC OF MALDIVES


DESCRIPTION REVISION



Consultancy Services for Survey, Design of Water supply Facilities in Tha. Vilifushi, F.Nilandhoo, B.Eydhafushi and Adh. Hanyaameedhoo, Maldives


RO PLANT ADMIN BUILDING STRUCTURAL DRAWINGS

SK SR MP MA 1:50 08.12.11 PROJECT No. SHEET No. DRAWING K-627 1 OF 1 REV. No. 0 BE-WS-117

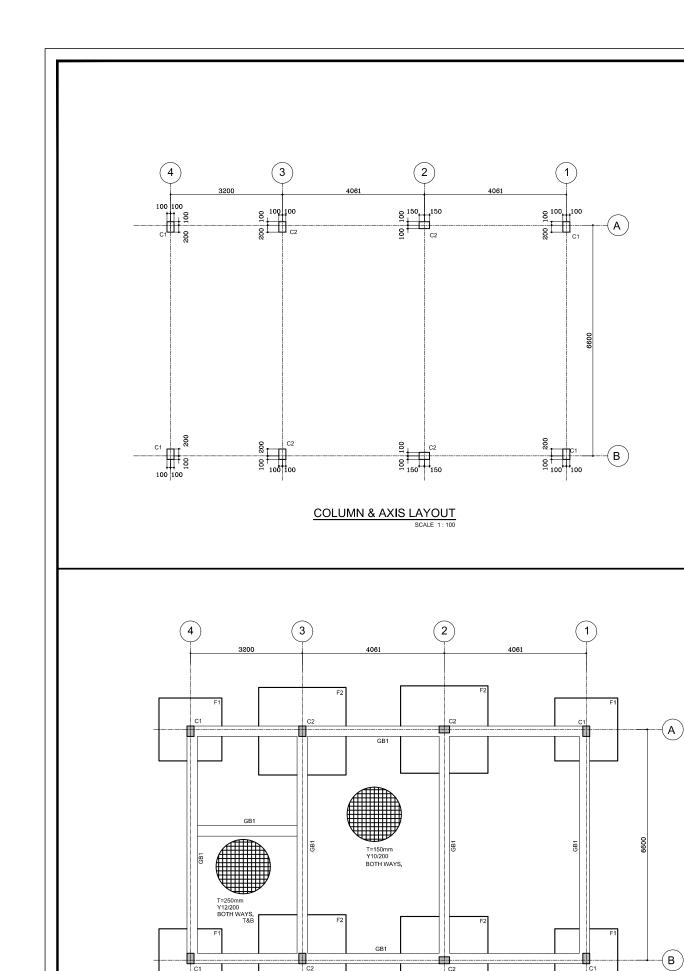

FOOTING & GRADE BEAM LAYOUT

SCALE 1:100

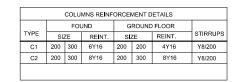

FOOTING REINFORCEMENT DETAILS									
MARK		DIMENSIO	N	REINFOR	CEMENT	BOXED	REMARKS		
Wirth	L	W	Н	WIDTH	LENGTH	BOXED	REWARKS		
F1	1800	1800	300	5Y16/m	5Y16/m				
F2	2500	2500	400	8Y16/m	8Y16/m				

GRADE BEAM REINFORCEMENT DETAILS								
MARK	SIZ	E	воттом	TOP	STIRRUPS	SIDE		
IVIARK	b	h	BARS	BARS	STIRRUPS	BARS	REMARKS	
GB1	300	300	3Y16	3Y16	Y8/200			

BEAM REINFORCEMENT DETAILS										
MARK	SIZ	E	воттом	TOP	CTIPPLIPS	SIDE				
MARK	b	h	BARS	BARS	STIRRUPS	BARS	REMARKS			
B1	200	500	3Y16 + 2Y16	2Y16	Y8/150					
B2	200	400	3Y16	3Y16	Y8/150					
В3	200	400	5Y16	3Y16	Y8/150					
			•		•					

REFER REINFORCEMENT DETAILS

REFER REINFORCEMENT DETAILS

SLABS REINFORCEMENT DETAILS									
MARK	THICK	REINFORCE	REMARKS						
IVIARIX		WIDTH	LENGTH						
S1	150	Y10/150	Y10/150						

FOOTING DETAIL



2. ALL LEVELS SHOWN ARE. IN METERS.

3. THIS DRAWING TO BE READ IN CONJUNCTION WITH ALL OTHER RELEVANT DRAWINGS, GENERAL NOTES AND SPECIFICATIONS.

4. CONTRACTOR SHALL CONDUCT INDEPENDENT GEOTECHNICAL INVESTIGATION TO CONFORM THE BEARING CAPACITY OF SOIL 65 KN / M AT 1M DEPTH AS DESIGNED IS APPROPRIATE SHOULD THERE BE A VARIANCE CONTRACTOR SHALL REVISE THE DESIGN TO CONSTRUCT THE WORK

THE DESIGN TO CONSTRUCT THE WORK

THE CONCRETE COVER TO ALL REINFORCEMENT SHALL BE
AS FOLLOW:

COLUMN / BEAM = 40 mm
SLAB = 30 mm

FOUNDATION = 50 mm

WATER CEMENT RATIO SHALL BE 0.50
 FOR ALL GENERAL NOTES REFER BY DWG_UT-GN-01

LEGEND:-

1. NGL - NATURAL GROUND LEVEL 2. FFL - FINISHED FLOOR LEVEL 3. PCC - PLAIN CEMENT CONCRETE

ABBREVIATIONS:-



GRID LINE - GRID MARK (HORIZONTAL)



- GRID MARK (VERTICAL)

REFERENCE DRAWINGS

SL.No.	DRAWING No.	DESCRIPTION
		•

22.10.10	CONCENT BEGION CODMISCOION			l .
22 10 '15	CONCEPT DESIGN SUBMISSION	SR	MP	MA
08.12.'15	DETAILED DESIGN SUBMISSION	SR	MP	MA
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REVISION


MINISTRY OF ENVIRONMENT & ENERGY REPUBLIC OF MALDIVES



Consultancy Services for Survey, Design of Water supply Facilities in Tha. Vilifushi, F.Nilandhoo, B.Eydhafushi and Adh. Hanyaameedhoo, Maldives

REVERSE OSMOSIS UNIT STRUCTURAL PLANS

DESIGNED	DRAWN	CHECKED	APPROVED	SCALE	DATE
SK	SR	MP	MA	1:50	08.12.'15
PROJECT No.	SHEET No.	DRAWING	No.		
K-627	1 OF 1		BE-WS	S-119	
REV. No.	0				

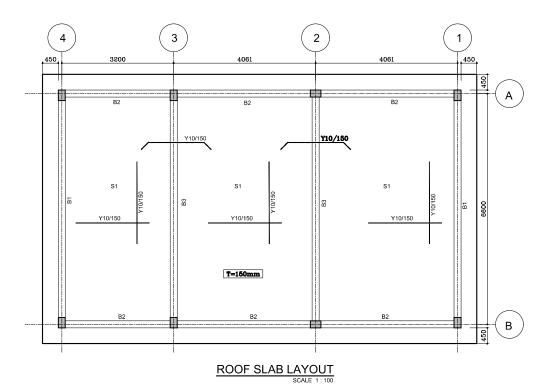

COLUMNS REINFORCEMENT DETAILS									
	FOUND GROUND FLOOR								
TYPE	SIZ	ZE	REINT.	SIZE		REINT.	STIRRUPS		
C1	200	300	6Y16	200	200	4Y16	Y8/200		
C2	200	300	8Y16	200	300	8Y16	Y8/200		

	FOOTING REINFORCEMENT DETAILS										
MARK	DIMENSION REINFORCEMENT					BOXED	REMARKS				
175 4 414	L	W	Н	WIDTH LENGTH		BOXED	KEIWAKKS				
F1	1800	1800	300	5Y16/m	5Y16/m						
F2	2500	2500	400	8Y16/m	8Y16/m						

	GRADE BEAM REINFORCEMENT DETAILS									
MARK	SIZ	E	воттом	TOP	OTIDDUDO	SIDE				
WARK	b	h	BARS	BARS	STIRRUPS	BARS	REMARKS			
GB1	300	300	3Y16	3Y16	Y8/200					

			BEAM REINFO	RCEMENT DE	TAILS		
MARK	SIZ b	E h	BOTTOM BARS	TOP BARS	STIRRUPS	SIDE BARS	REMARKS
B1	200	500	3Y16 + 2Y16	2Y16	Y8/150		
B2	200	400	3Y16	3Y16	Y8/150		
В3	200	400	5Y16	3Y16	Y8/150		

	SLAE	S REINFORCEM	IENT DETA I LS	
MARK	THICK	REINFORCE	MENT	REMARKS
IVIARA	ITHICK	WIDTH	LENGTH	
S1	150	Y10/150	Y10/150	

- ALL DIMENSIONS ARE IN MILLIMETERS (MM).
 ALL LEVELS SHOWN ARE IN METERS.

- 2. ALL LEVELS SHOWN ARE IN METERS.
 3. THIS DRAWING TO BE READ IN CONJUNCTION WITH ALL OTHER RELEVANT DRAWINGS, GENERAL NOTES AND SPECIFICATIONS.
 4. CONTRACTOR SHALL CONDUCT INDEPENDENT GEOTECHNICAL INVESTIGATION TO CONFORM THE BEARING CAPACITY OF SOIL 65 KN./ M AT IM DEPTH AS DESIGNED IS APPROPRIATE SHOULD THERE BE A VARIANCE CONTRACTOR SHALL REVISE THE DESIGNET CONSTRUCT THE WORK
 5. THE CONCRETE COVER TO ALL REINFORCEMENT SHALL BE AS FOLLOW:

 COLUMN/SEAM = 40 mm
 SLAB = 30 mm
 FOUNDATION = 50 mm
 6. WATER CEMENT RATIO SHALL BE 0.50
 7. FOR ALL GENERAL NOTES REFER BY DWG UT-GN-01

LEGEND:-

1. NGL - NATURAL GROUND LEVEL 2. FFL - FINISHED FLOOR LEVEL 3. PCC - PLAIN CEMENT CONCRETE

ABBREVIATIONS:-





- GRID MARK (VERTICAL)

REFE	ERENCE DRAWINGS
DRAWING No.	DESCRIPTION

		**			
		**			
0	08.12.'15	DETAILED DESIGN SUBMISSION	SR	MP	M

0 22.10.'15 CONCEPT DESIGN SUBMISSION SR MP MA

DESCRIPTION REVISION



REV. DATE


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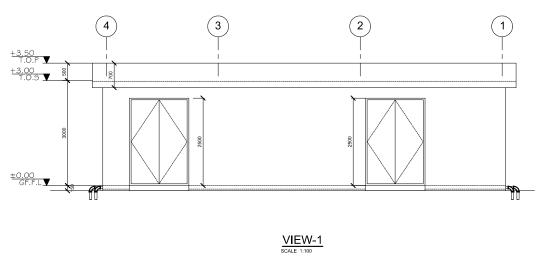


Consultancy Services for Survey, Design of Water supply Facilities in Tha. Vilifushi, F.Nilandhoo, B.Eydhafushi and Adh. Hanyaameedhoo, Maldives


REVERSE OSMOSIS UNIT STRUCTURAL PLANS

DESIGNED	DRAWN	CHECKED	APPROVED	SCALE	DATE
SK	SR	MP	MA	1:50	08.12.'15
PROJECT No.	SHEET No.	DRAWING	No.		
K-627	1 OF 1		BE-WS	S-120	
DEM No.					



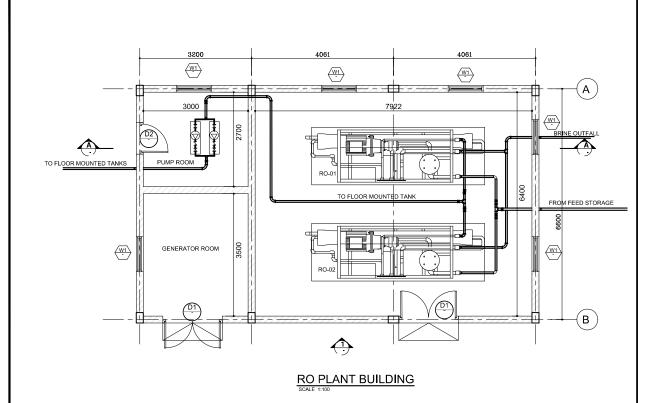

- ALL DIMENSION ARE IN MILLIMETER (MM), UNLESS OTHERWISE NOTED
- ALLEVELS SHOWN ARE IN METERS.
 THIS DRAWING TO BE READ IN CONJUNCTION WITH ALL OTHER RELEVANT DRAWINGS, GENERAL NOTES AND SPECIFICATIONS.

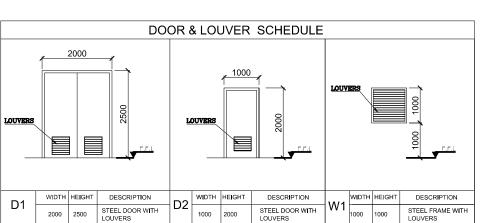

1000 2000

2500

2000

RO PLANT SCHEDULE FOR XXXXXXX ISLAND MOTOR


35 KW(46.90 BHP)


400-415/3/50

25.0M /HRS

REMARKS

TWO NOS OF RO PLANT WORKING ACCORDING TO FLOAT SENSOR

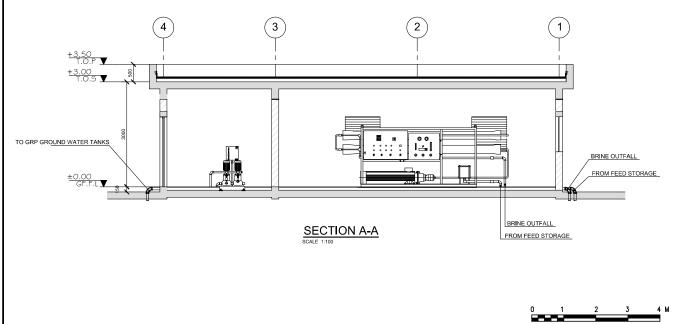

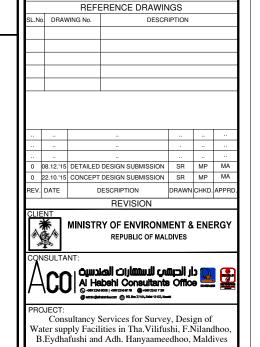


REVERSE OSMOSIS UNIT DETAILS


PROJECT No. SHEET No. DRAWING K-627 1 OF 1

REV. No.

SK SR MP MA 1:50 08.12.11

BE-WS-121

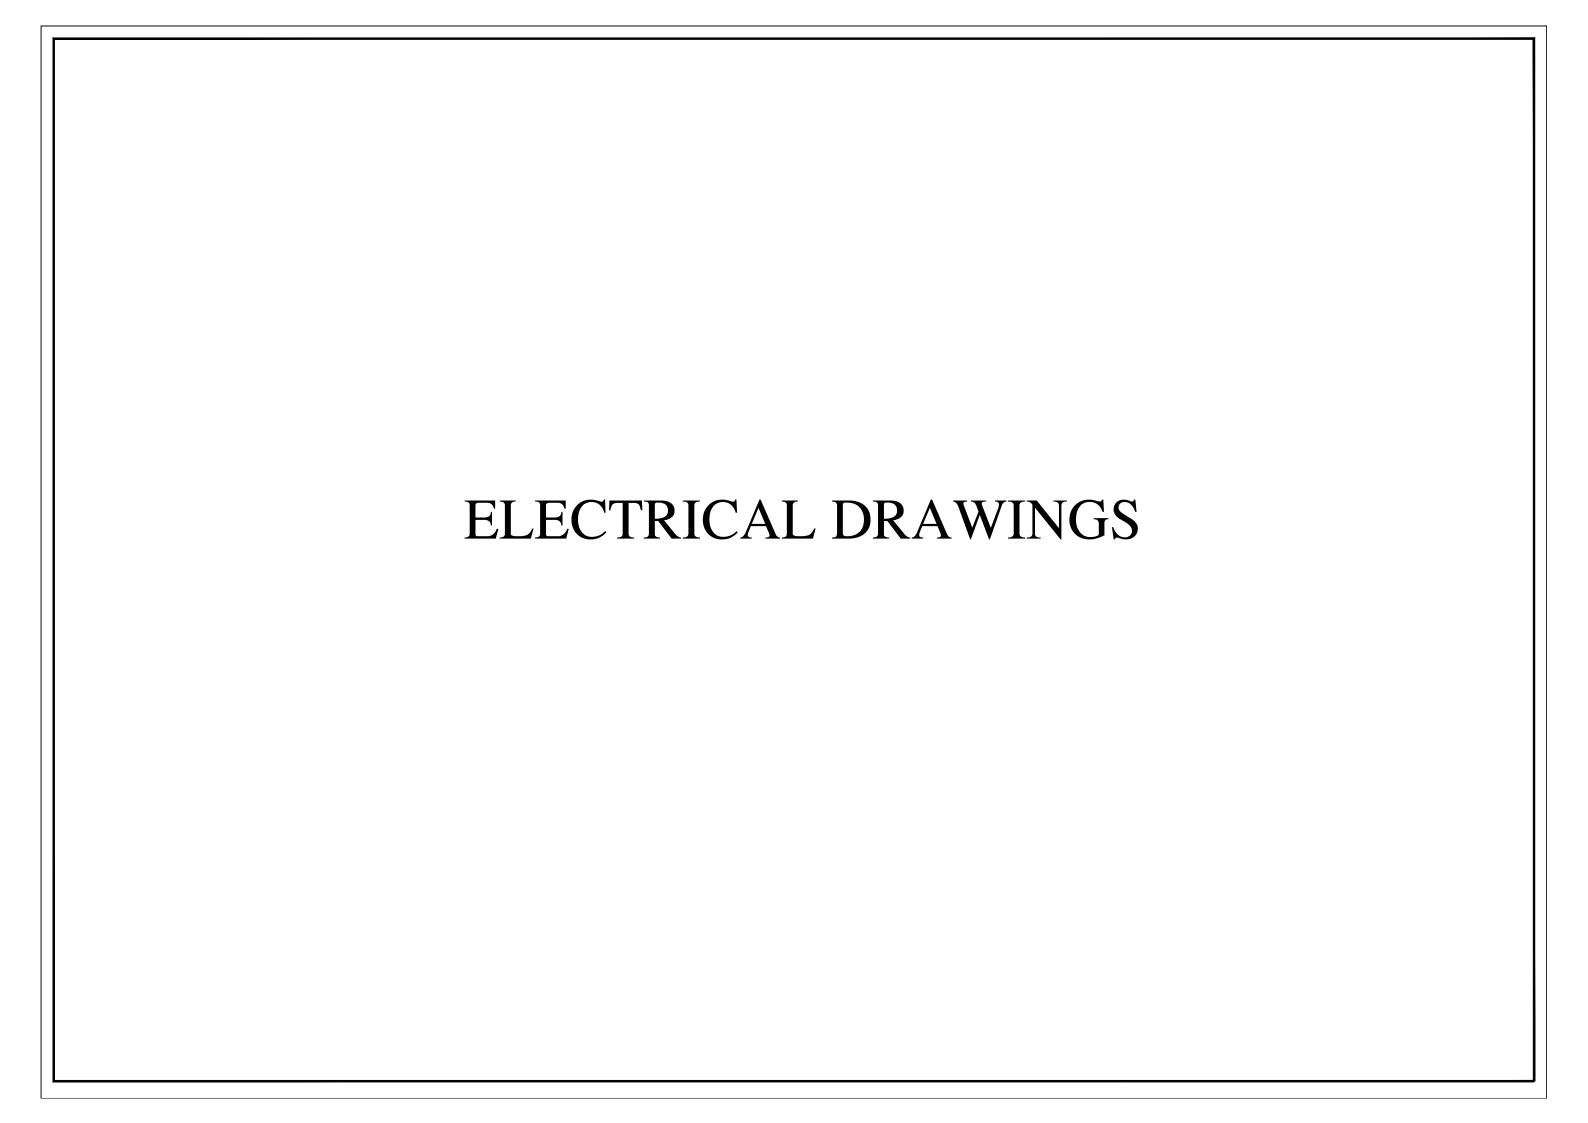

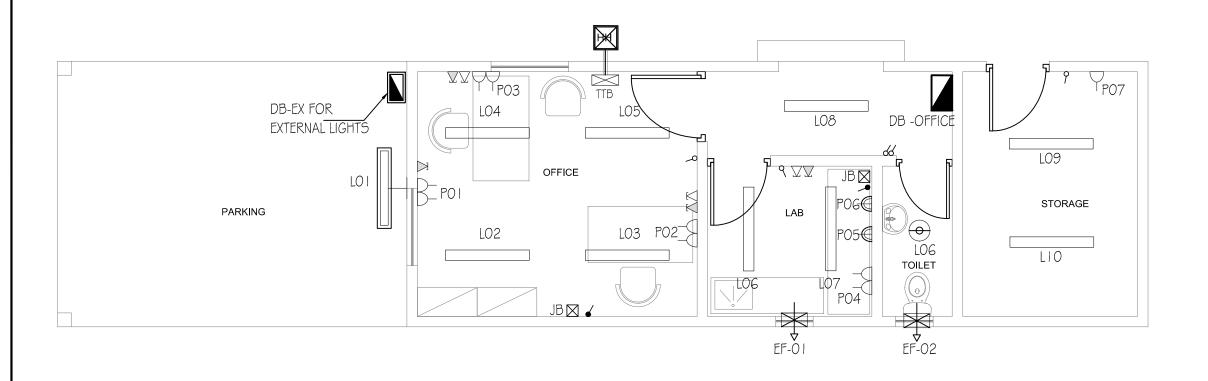

PLAN SCALE 1:100

- . ALL DIMENSIONS ARE IN mm EXCEPT AND OTHERWISE SPECIFIED.

 THIS DRAWING TO BE READ IN CONJUNCTION WITH ALL OTHER RELEVANT DRAWINGS AND SPECIFICATIONS.

 ALL ABOVE GROUND CONDUIT SHALL BE RIGID HOT DIP GALVANIZED EXCEPT AS NOTED.
- 4. ALL NEMA 3R GASKETED 5.5 ENCLOSURES TO HAVE LOCKABLE HANDLE AND 3 POINT LATCHING.

LEGENDS

	LLG	LINDO	
	TYPE	SYMBOL	DESCRIPTION
	В		I x 40W SURFACE MOUNTED FLUORESCENT LIGHT FITING
	С		I x 40W WALL MOUNTED FLUORESCENT LIGHT FITING-WEATHERPROOF
	E	⊕	I xGOW SURFACE MOUNTED FLUORESCENT DOWN LIGHT - WEATHERPROOF
		Ь	5A SWITCHED SOCKET OUTLET (1000W)
		Δ	5A SWITCHED SOCKET OUTLET AT HIGHT LEVEL-WEATHER PROOF (1000W)
		Δ	I 3A TWIN SWITCHED SOCKET OUTLET
		⋈	JUNCTION BOX
		4	20A DP SWITCH
		*	EXHAUST FAN (80W)
		TTB	TELEPHONE TERMINAL BOX
		Z	SINGLE OUTLET FOR DATA
		\square	SINGLE OUTLET FOR VOICE
		\boxtimes	0.6x0.6x0.6m HAND HOLE
Ι.			

	REFE	ERENCE DRAWINGS
	DRAWING No.	DESCRIPTION
1		

П						
ı						
	0	28-12-'15	DETAILED DESIGN SUBMISSION	BA	RDS	MA
ı	REV.	DATE	DESCRIPTION	DRAWN	CHKD.	APPR

REVISION





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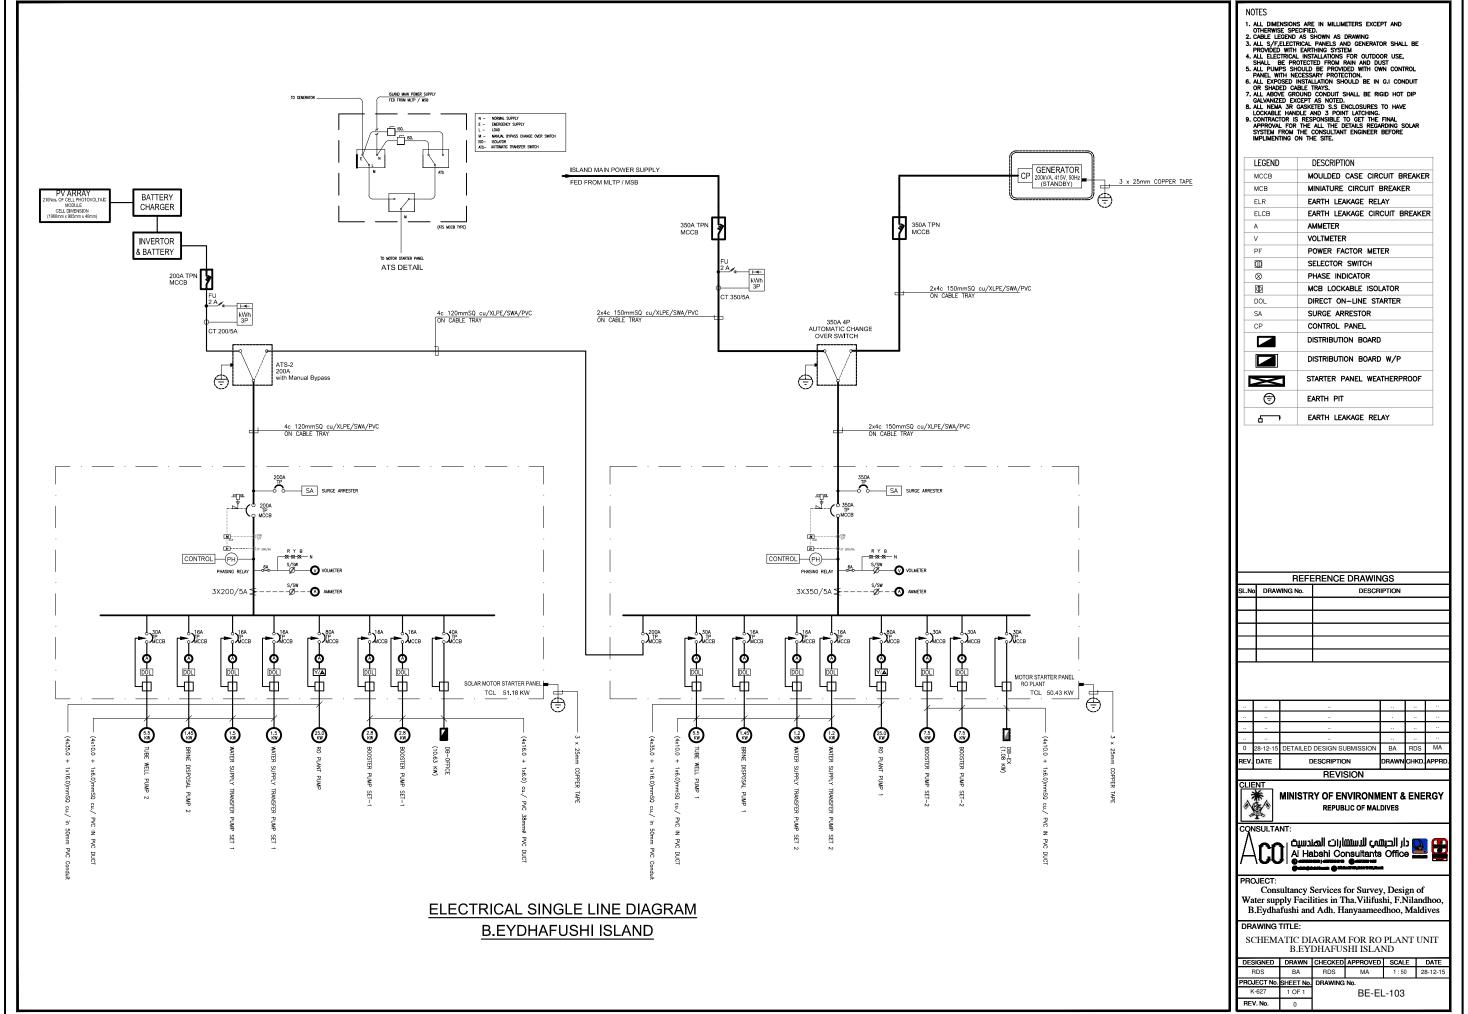
دار الحبشي للسنشارات المندسية (ال الحبشية Al Habshi Consultants Office

Consultancy Services for Survey, Design of Water supply Facilities in Tha. Vilifushi, F.Nilandhoo, B.Eydhafushi and Adh. Hanyaameedhoo, Maldives

PROJECT No. SHEET No. DRAWING
K-627 1 OF 1 BE-EL-100 REV. No.



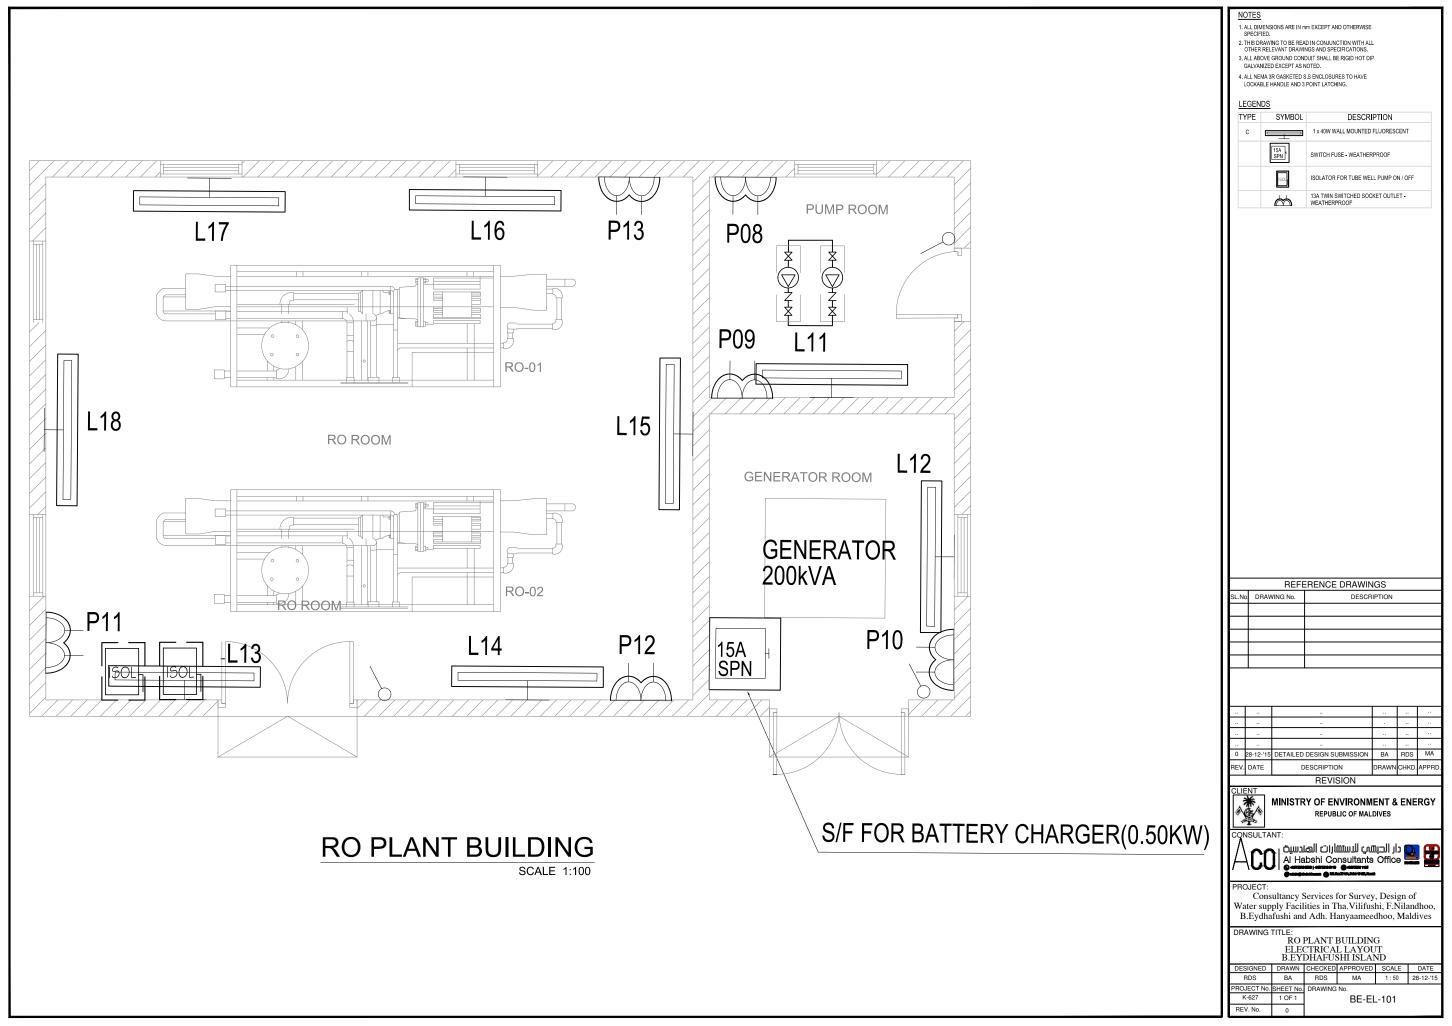

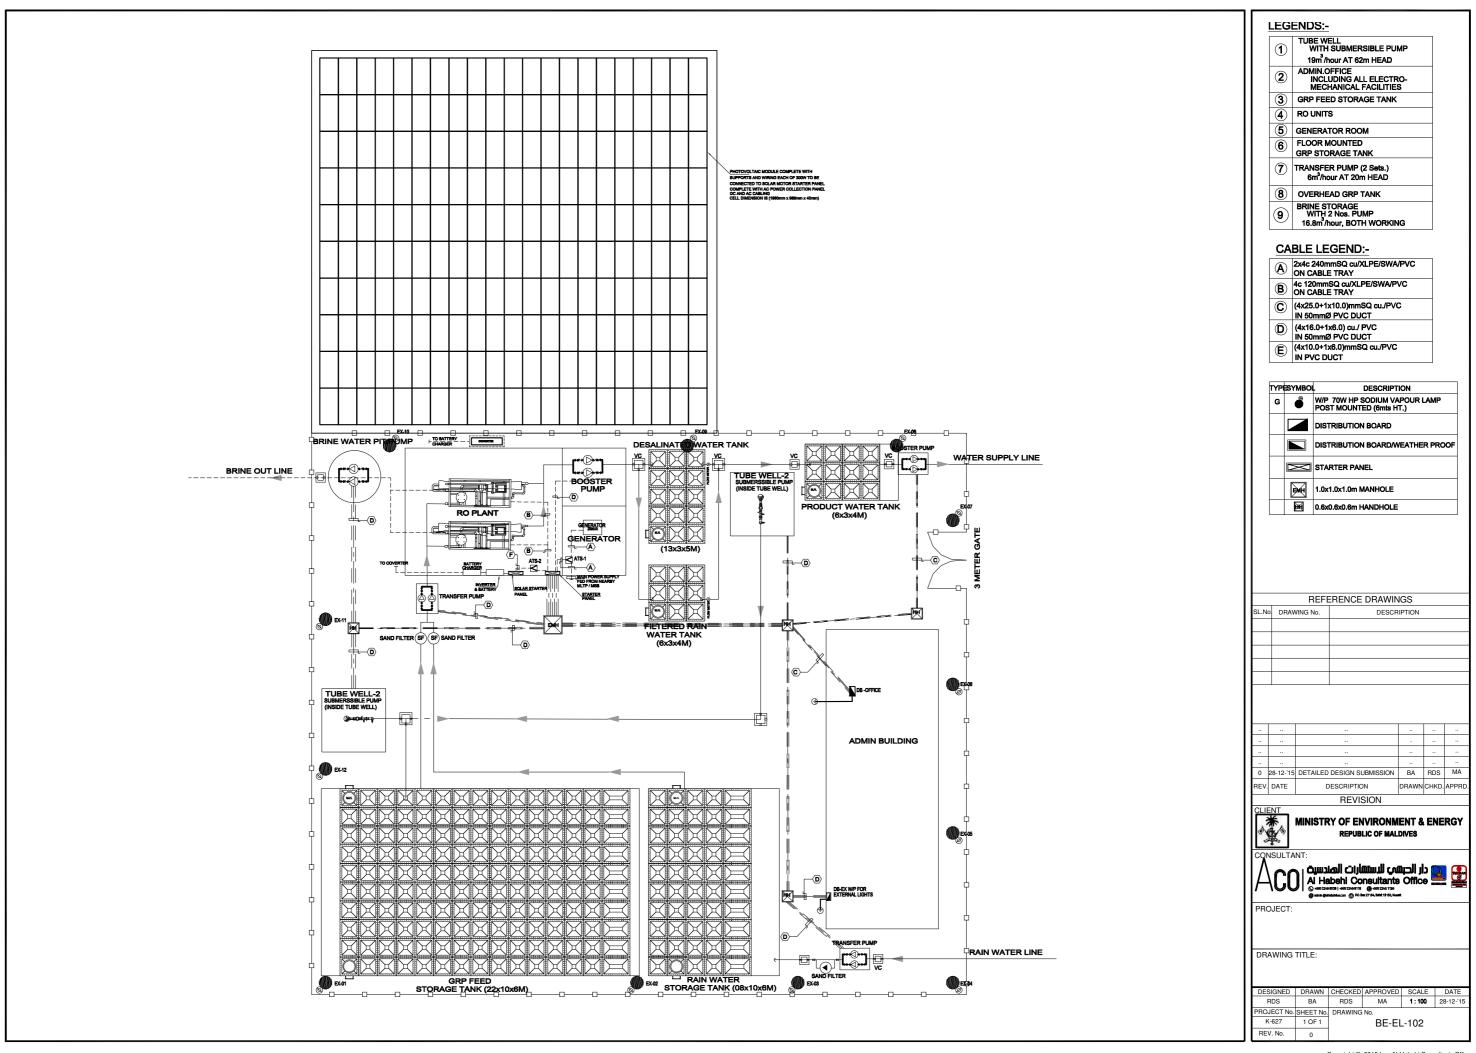

LO	CATIO	IN .		OFFICE					
	MCB	10	WAYS TPN		3 Nos. 63A	HRC FUSES +	ISOLATOR	100A TPN	
			TION		C.O.E.L.C.B.	40A,	300mA	4 POLE	
Phase	W.SIZE sq.mm	RATES AMP	LOCATION	TYPE OF LIGHT/POWER	NO. OF POINTS	CONTROLLED BY	R	Y	В
R	2.5	10	OFFICE BLDG.	LIGHT L02-L05	4(1x50)	SWITCH	200		
Y	2.5	10	LAB	LIGHT L6-L7	2(1x50)+1(1X80)	SWITCH		180	
В	2.5	10	TOILET/CORRIDOR	LIGHT L06,-L08	1(1x70)+1(1x50)+1 (1X80)	SWITCH			200
R	2.5	10	STORAGE	LIGHT L09-L10	2(1x50)	SWITCH	100		
Y	2.5	10	OFFICE-CAR PARK	LIGHT L01	1(1x50)	SWITCH		50	
В	3	10		SPARE					
R	2.5	15	RO PLANT BLDG.	LIGHT L13-L18	6(1x50)	SWITCH	300		
Y	2.5	10		SPARE					
В	-	10	ROPLANT BLDG.	LIGHT L11-L12	2(1x50)	SWITCH			100
			POW	ER SECTION C.O.	E.L.C.B 63A 30	mA 4 POLE			
R	4.0	15	OFFICE	P01-P03	3(1x200)	SWITCHED	600		
Y	4.0	15	OFFICE-LAB	P05	1(1x1000)	SWITCHED		1000	
В	4.0	15	OFFICE-LAB	P06	1(1x1000)	SWITCHED			1000
R	4.0	15		SPARE					
Y	4.0	15	OFFICE LAB	P04	1(1x200)	SWITCHED		200	
В	4.0	15	OFFICE-STORAGE	P07	1(1x1000)	SWITCHED			1000
R	4.0	15		SPARE					
Y	6.0	15		SPARE					
В	6.0	15		SPARE					
R	6.0	20	OFFICE BLDG.	SU-01	1(1x2000)	JB+DP SWITCH	2000		
Y	6.0	20	OFFICE BLDG.	SU-02	1(1x2000)	JB+DP SWITCH		2000	
В	4.0	15		SPARE					
R	-	10		SPARE					
Y	4.0	10	RO PLANT BLDG.	P11-P13	3(1x200)			600	
В	4.0	10	RO PLANT BLDG.	P08-P09	3(1x200)				600
R	4.0	10		SPARE					
Y	4.0	10		SPARE				-	
В	4.0	10	RO PLANT- GENERATOR ROOM	BATTERY CHARGER	1(1x500)	15A SPN S/F			500
R	4.0	10		SPARE			-		
Υ	4.0	10		SPARE				-	
В	4.0	10		SPARE					_
	8	MCB UIGH WSIZE sqmm R 2.5 Y 2.5 B 2.5 Y 2.5 B - R 2.5 Y 2.5 B - R 4.0 Y 4.0 B 4.0 Y 6.0 B 6.0 R 6.0 R 6.0 R 4.0 B 4.0 R 4.0 </td <td>MCB 10 LIGHT SEC sqmm AMP R 2.5 10 B 2.5 10 R 2.5 15 Y 2.5 10 B - 10 R 2.5 15 Y 2.5 10 B - 10 R 4.0 15 R 6.0 20 Y 6.0 20 Y 4.0 15 R - 10 Y 4.0 10 R 4.0 10 R 4.0 10<</td> <td>MCB 10 WAYS TPN LIGHT SECTION general AMP LOCATION R 2.5 10 OFFICE BLDG. Y 2.5 10 TOILET/CORRIDOR R 2.5 10 STORAGE Y 2.5 10 OFFICE-CAR PARK B - 10 RO PLANT BLDG. Y 2.5 10 RO PLANT BLDG. Y 2.5 10 POW R 4.0 15 OFFICE Y 4.0 15 OFFICE Y 4.0 15 OFFICE-LAB B 4.0 15 OFFICE-LAB B 4.0 15 OFFICE-LAB B 4.0 15 OFFICE-STORAGE R 4.0 15 OFFICE-STORAGE R 4.0 15 OFFICE BLDG. Y 6.0 20 OFFICE BLDG. Y 6.0 20 OFFI</td> <td> MCB</td> <td> MCB</td> <td> MCB 10 WAYS TPN C.O.E.L.C.B. 40A, </td> <td> MCB</td> <td> MCB</td>	MCB 10 LIGHT SEC sqmm AMP R 2.5 10 B 2.5 10 R 2.5 15 Y 2.5 10 B - 10 R 2.5 15 Y 2.5 10 B - 10 R 4.0 15 R 6.0 20 Y 6.0 20 Y 4.0 15 R - 10 Y 4.0 10 R 4.0 10 R 4.0 10<	MCB 10 WAYS TPN LIGHT SECTION general AMP LOCATION R 2.5 10 OFFICE BLDG. Y 2.5 10 TOILET/CORRIDOR R 2.5 10 STORAGE Y 2.5 10 OFFICE-CAR PARK B - 10 RO PLANT BLDG. Y 2.5 10 RO PLANT BLDG. Y 2.5 10 POW R 4.0 15 OFFICE Y 4.0 15 OFFICE Y 4.0 15 OFFICE-LAB B 4.0 15 OFFICE-LAB B 4.0 15 OFFICE-LAB B 4.0 15 OFFICE-STORAGE R 4.0 15 OFFICE-STORAGE R 4.0 15 OFFICE BLDG. Y 6.0 20 OFFICE BLDG. Y 6.0 20 OFFI	MCB	MCB	MCB 10 WAYS TPN C.O.E.L.C.B. 40A,	MCB	MCB

		DB-EX	(
			2	WAYS TPN			40A, TP,	ISOLATO	R	
	C.O.E.L.C.B. 40A, 300mA 4 POLE									
CR	se	W.SIZE	мсв wтн	LOCATION	DESCRIPTION	NO OF POINTS	CONTROLL	R	Y	В
No	Phase	sq.mm		LOCATION	DESCRIPTION	NO. OF POINTS	ED BY			
	R	6.0	15ASP	EXTERNAL LIGHTS	EX1-EX4	4(1x90)		360		
1	Y	6.0	15ASP	EXTERNAL LIGHTS	EX5-EX8	4(1x90)	Controlled by 20A 2P		360	
	В	6.0	15ASP	EXTERNAL LIGHTS	EX9-EX12	4(1x90)	contactor, Photocell and H-O-A			360
	R	-	15ASP		SPARE		selector			
2	Y	-	15ASP		SPARE					
	В	-	15ASP		SPARE					
				_	TOTAL CONN. LOAD	01.080 K.W.		360	360	360

REFERENCE DRAWINGS SL.No. DRAWING No. DESCRIPTION



MINISTRY OF ENVIRONMENT & ENERGY REPUBLIC OF MALDIVES

consultant: المدسية المسلمان المدسية المدسية Al Habshi Consultants Office

0 28-12-15 DETAILED DESIGN SUBMISSION BA RDS MA DESCRIPTION REVISION

Consultancy Services for Survey, Design of Water supply Facilities in Tha. Vilifushi, F.Nilandhoo, B.Eydhafushi and Adh. Hanyaameedhoo, Maldives

DRAWING TITLE:

ELECTRICAL DB SCHEDULE


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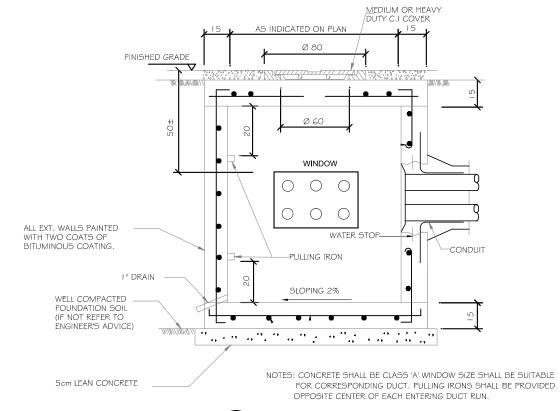
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 SHEET No.
 DRAWING No.

 K-627
 1 OF 1
 BE-EL-104


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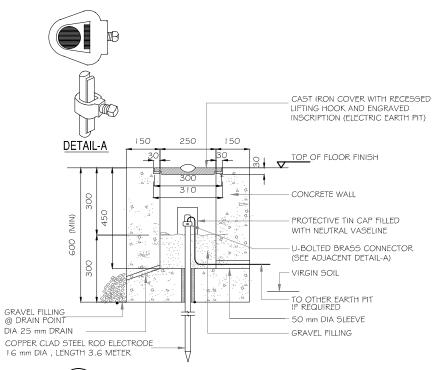




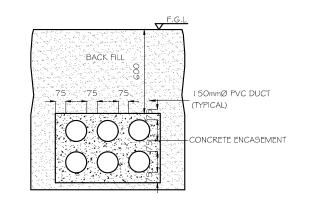

MANHOLE DETAIL



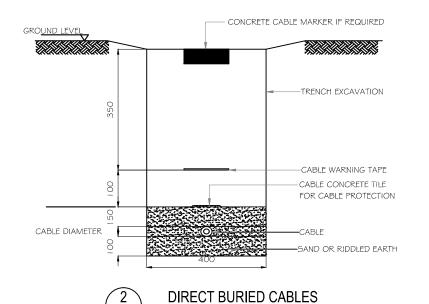

EARTH PIT CONSTRUCTION (OUTDOOR)

REFERENCE DRAWINGS SL.No DRAWING No. DESCRIPTION 0 28-12-'15 DETAILED DESIGN SUBMISSION BA RDS MA REV. DATE DESCRIPTION REVISION MINISTRY OF ENVIRONMENT & ENERGY REPUBLIC OF MALDIVES Consultancy Services for Survey, Design of Water supply Facilities in Tha.Vilifushi, F.Nilandhoo, B.Eydhafushi and Adh. Hanyaameedhoo, Maldives ELECTRICAL TYPICAL DETAILS
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