

MINISTRY OF ENVIRONMENT AND ENERGY

REPUBLIC OF MALDIVES

TENDER DRAWINGS

01 MARCH 2016

PROJECT:


PROVISION OF WATER SUPPLY FACILITIES IN TH. VILUFUSHI, MALDIVES


CONSULTANT:



DWG. NOS	DRAWING TITLES
GENERAL	•
TV-WS-100	LIST OF DRAWINGS
WATER SUPPL	Y
TV-WS-101 (01 OF 02)	WATER SUPPLY LAYOUT-PART-A
TV-WS-101 (02 OF 02)	WATER SUPPLY LAYOUT-PART-B
TV-WS-102	RAIN WATER COLLECTION LAYOUT
TV-WS-103 (1 OF 2)	BRINE OUTFALL LAYOUT & SECTION
TV-WS-103 (2 OF 2)	BRINE OUTFALL DETAILS
TV-WS-104	INTEGRATED WATER SUPPLY NETWORK SCHEMATIC
TV-WS-105	RO PLANT LAYOUT
TV-WS-106	BRINE PUMP DETAILS
TV-WS-107	TUBE WELL DETAIL
TV-WS-109 (1 OF 4)	TYPICAL DETAILS-WATER SUPPLY - (SHEET-OI)
TV-WS-109 (2 OF 4)	TYPICAL DETAILS-WATER SUPPLY - (SHEET-02)
TV-WS-109 (3 OF 4)	TYPICAL DETAILS-WATER SUPPLY - (SHEET-03)
TV-WS-109 (4 OF 4)	TYPICAL DETAILS-WATER SUPPLY - (SHEET-04)
TV-WS-110	TYPICAL PIPE BENDING DETAILS
TV-WS-111	GRP WATER TANK
TV-WS-113	RO PLANT ADMIN BUILDING - FLOOR AND ROOF PLAN
TV-WS-114	RO PLANT ADMIN BUILDING - ELEVATIONS AND SECTION
TV-WS-115	RO PLANT ADMIN BUILDING - DOOR, WINDOW & EXHAUST FAN DETAILS
TV-WS-116	RO PLANT ADMIN BUILDING - SEWERAGE AND WATER SUPPLY LAYOUT
TV-WS-117	RO PLANT ADMIN BUILDING - STRUCTURAL DRAWINGS
TV-WS-119	REVERSE OSMOSIS UNIT STRUCTURAL PLANS
TV-WS-120	REVERSE OSMOSIS UNIT STRUCTURAL DETAIL & SCHEDULES
TV-WS-121	REVERSE OSMOSIS UNIT DETAILS

LIST OF DRAWINGS					
DWG. NOS	DRAWING TITLES				
ELECTRICAL					
TV-EL- I 00	RO PLANT ADMIN BUILDING ELECTRICAL LAYOUT				
TV-EL-101	RO PLANT BUILDING ELECTRICAL LAYOUT				
TV-EL-102	RO PLANT ELECTRICAL LAYOUT				
TV-EL-103	SCHEMATIC DIAGRAM FOR RO PLANT				
TVEL-104	ELECTRICAL DB SCHEDULE				
TV-EL-105	ELECTRICAL TYPICAL DETAILS				

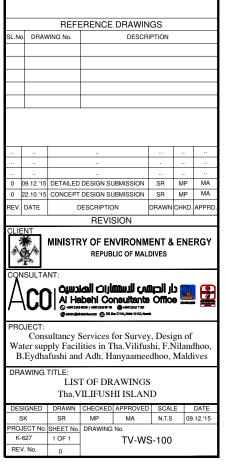

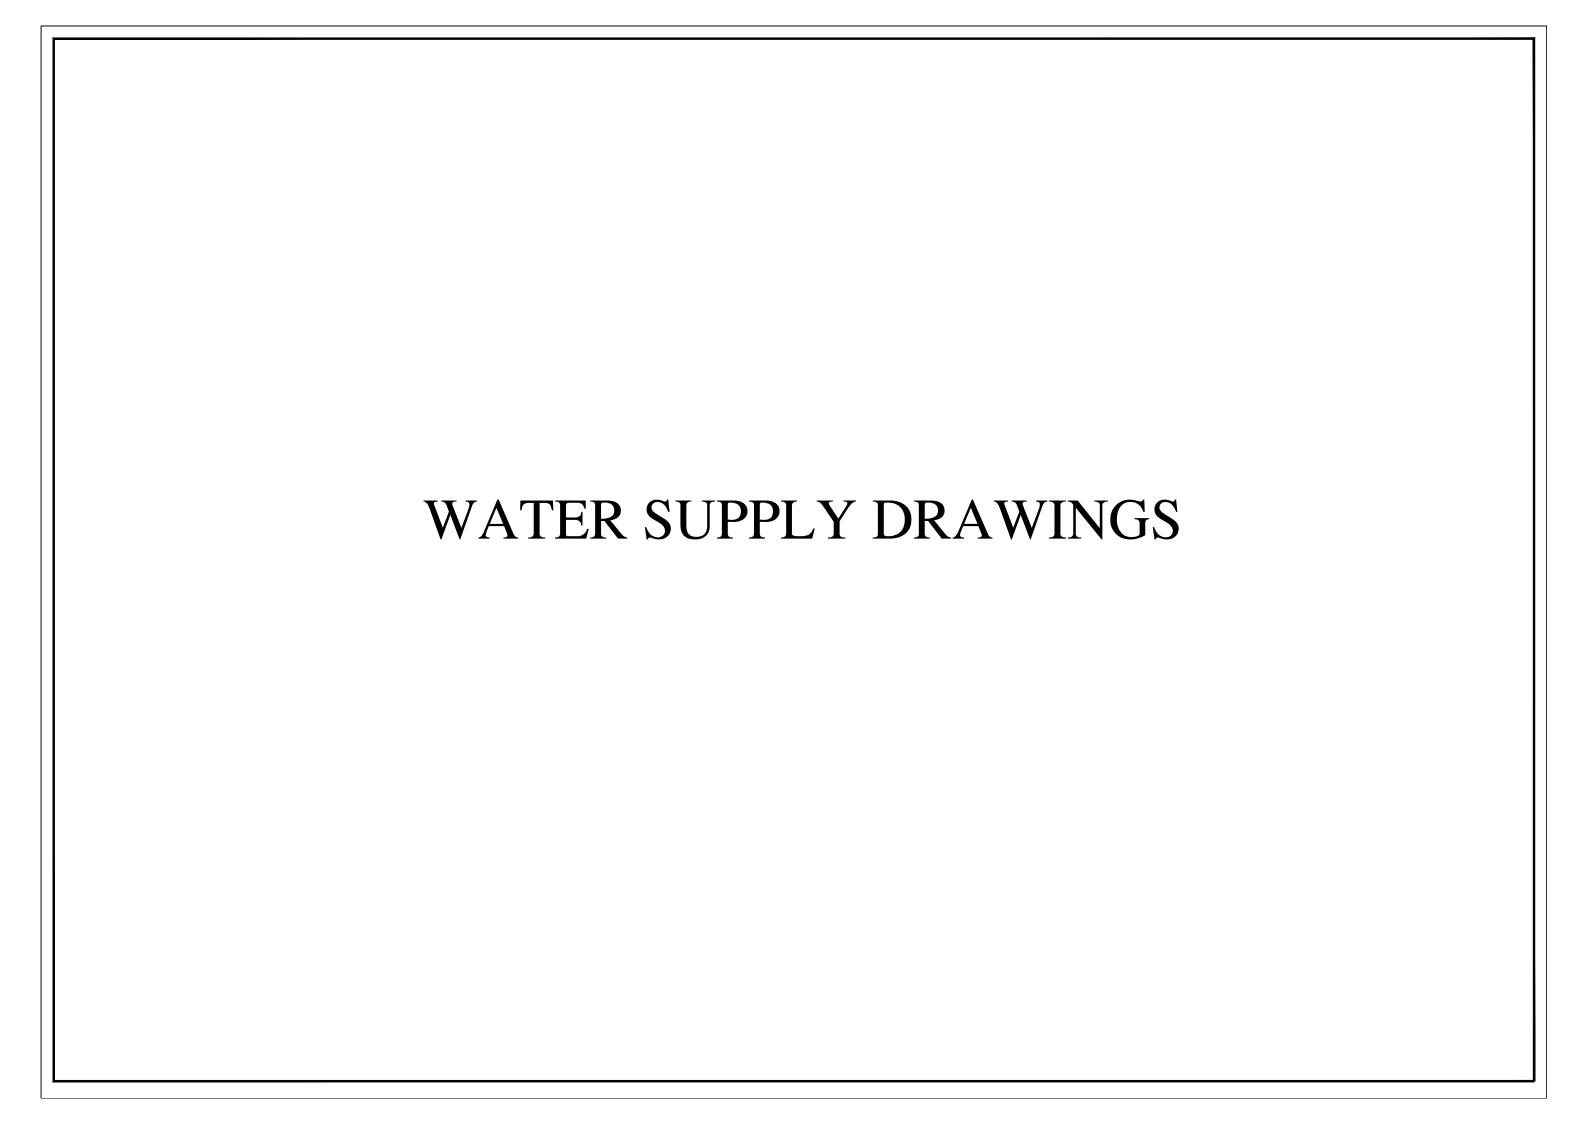









- ALL DIMENSIONS SHOWN ARE IN MILLIMETERS (MM),
 UNLESS OTHERWISE SHOWN
 ALL LEVELS SHOWN ARE IN METERS.
 ALL LEVELS SHOWN ARE FROM MEAN SEA LEVEL
 3. THIS DRAWING TO BE READ IN CONJUNCTION WITH ALL OTHER RELEVANT DRAWINGS,GENERAL NOTES AND SPECIFICATIONS.

REFERENCE DRAWINGS

09.12.'15 DETAILED DESIGN SUBMISSION 0 22.10.'15 CONCEPT DESIGN SUBMISSION SR MP



MINISTRY OF ENVIRONMENT & ENERGY






Consultancy Services for Survey, Design of Water supply Facilities in Tha. Vilifushi, F.Nilandhoo, B.Eydhafushi and Adh. Hanyaameedhoo, Maldives

BRINE OUTFALL LAYOUT & SECTION Tha. VILIFUSHI ISLAND


TV-WS-103

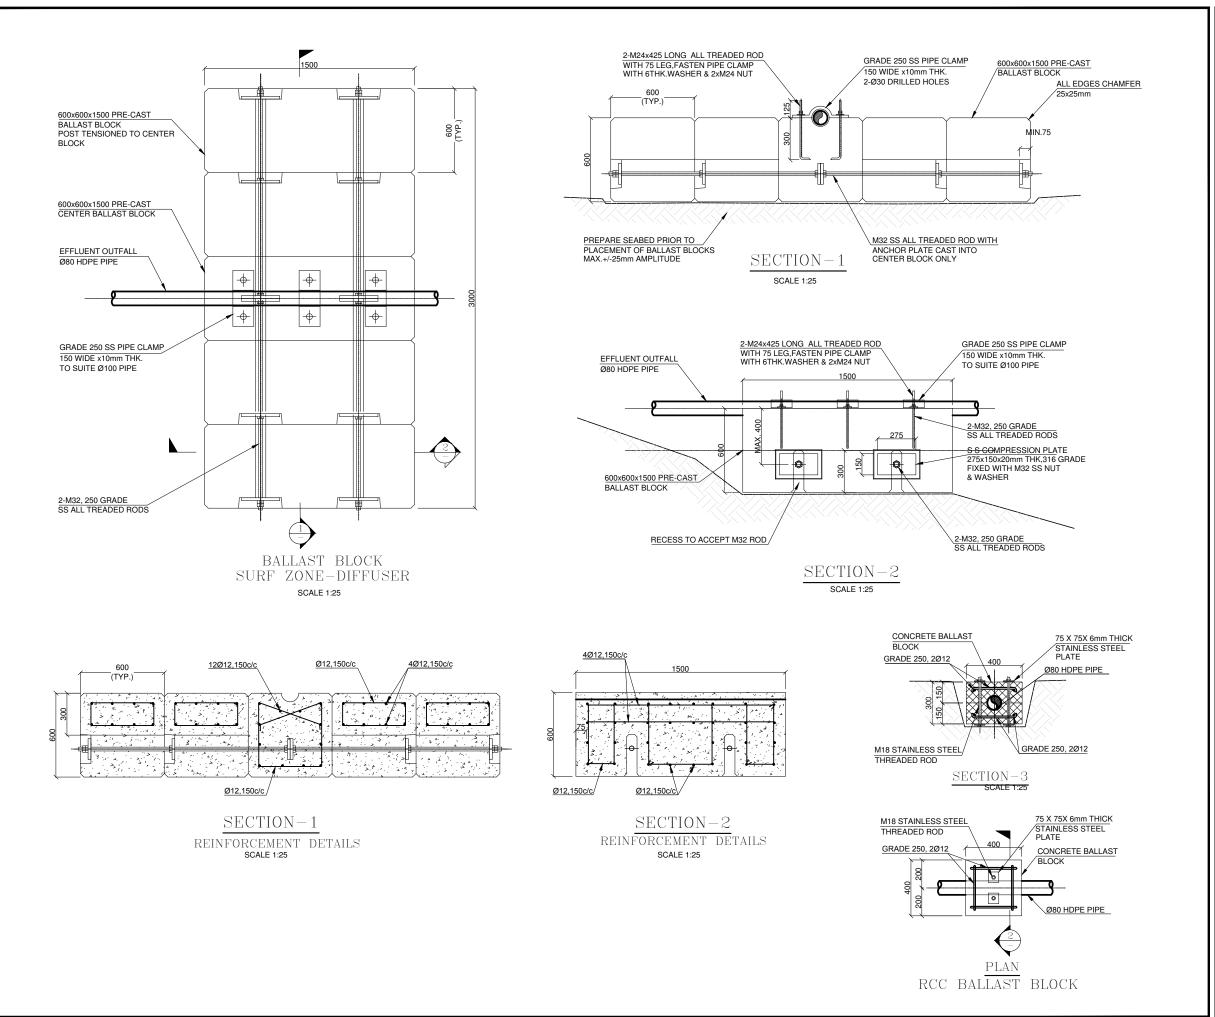


NOTES:-

. ALL DIMENSIONS SHOWN ARE IN MILLIMETERS (MM) UNLESS OTHERWISE SHOWN
2. ALL LEVELS SHOWN ARE IN METERS.


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RELEVANT DRAWINGS, GENERAL NOTES AND SPECIFICATIONS.

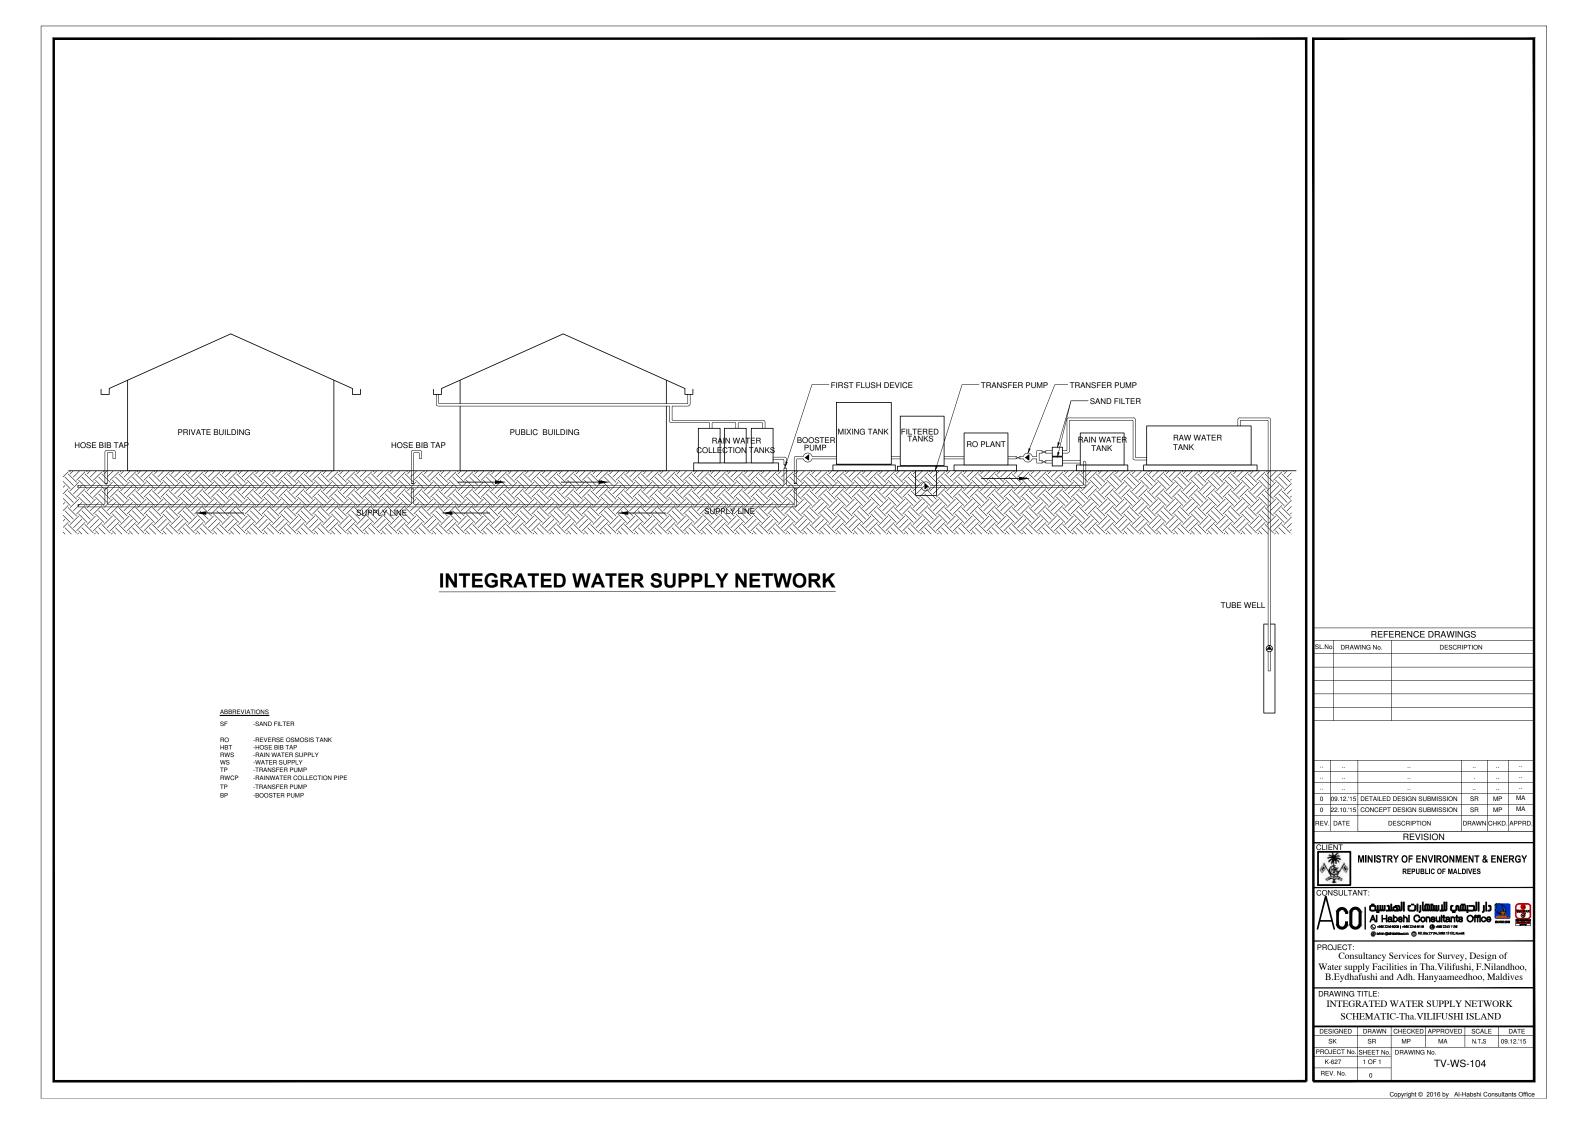

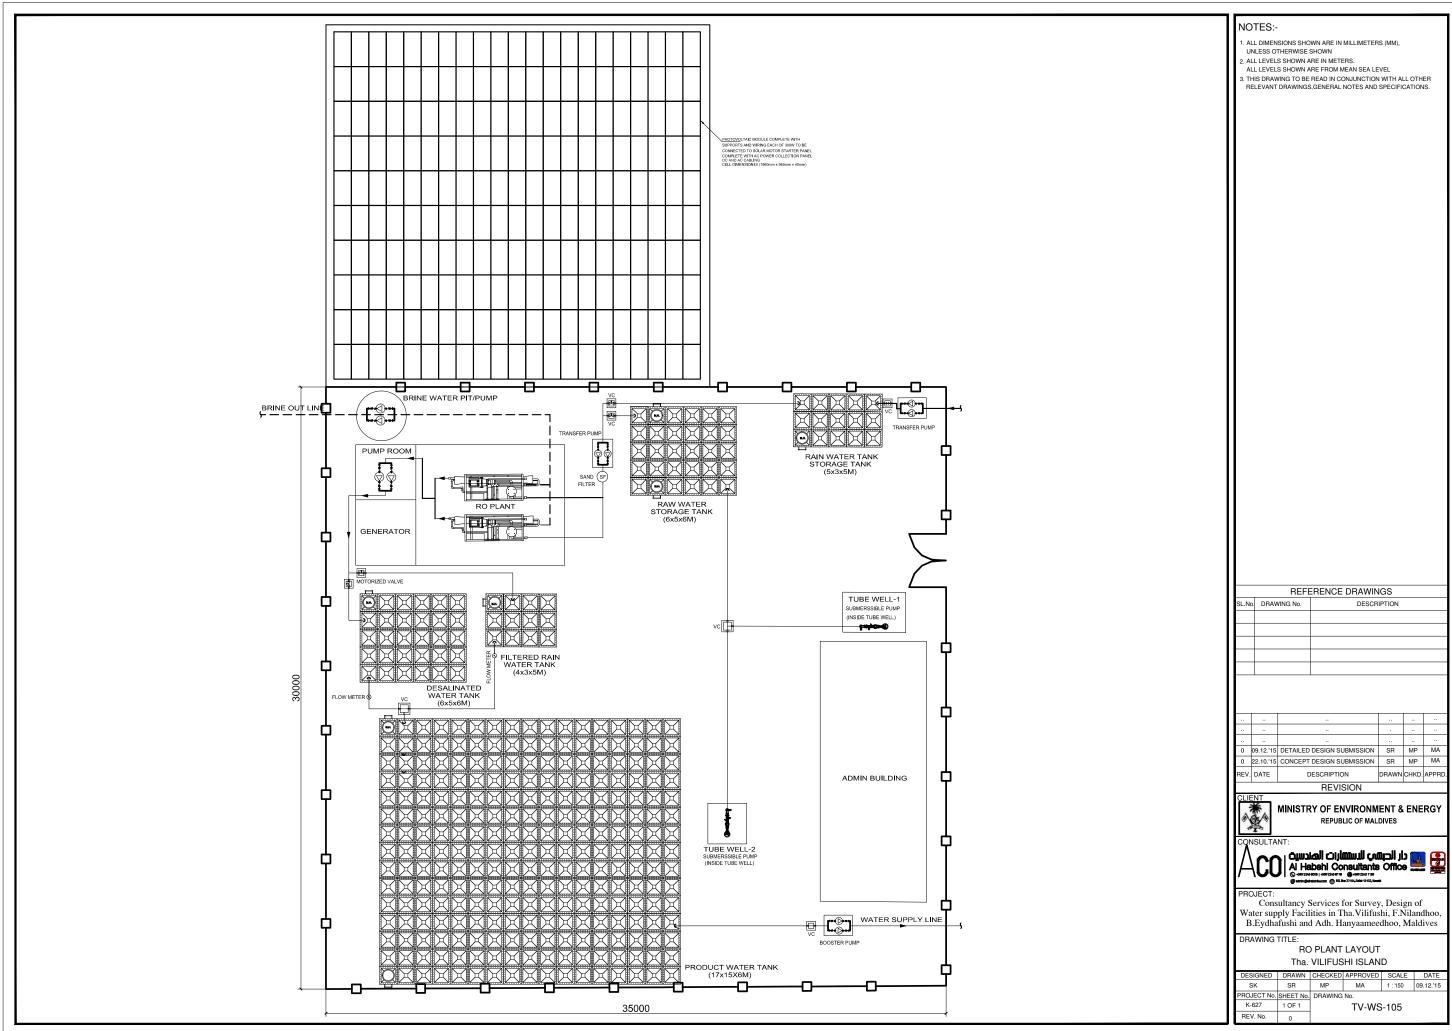

ACCESS DOORS CENTERED OVER PUMPS \HDPE.PRESSURE LINE VALVE CHAMBER 250mm THK RCC VENT PIPE

BRINE PUMP DETAILS - PLAN

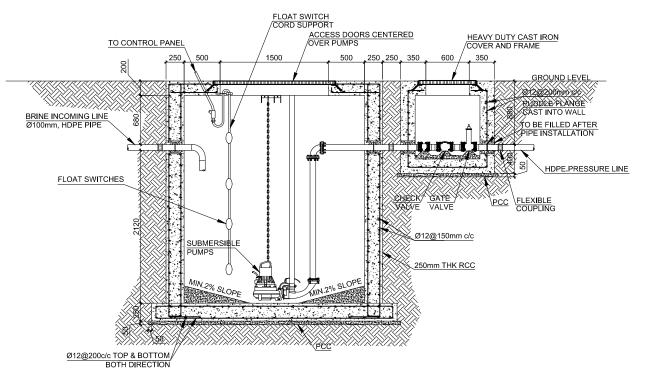

BRINE PUMP DETAILS - SECTION

NOTES:-

- 1. ALL DIMENSIONS SHOWN ARE IN MILLIMETERS (MM), UNLESS OTHERWISE SHOWN

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SL.No.	DRAWING No.	DESCRIPTION

0	09.12.'15	DETAILED DESIGN SUBMISSION	SR	MP	MA
0	22.10.'15	CONCEPT DESIGN SUBMISSION	SR	MP	MA
REV.	DATE	DESCRIPTION	DRAWN	CHKD.	APPRD.

REVISION



MINISTRY OF ENVIRONMENT & ENERGY REPUBLIC OF MALDIVES





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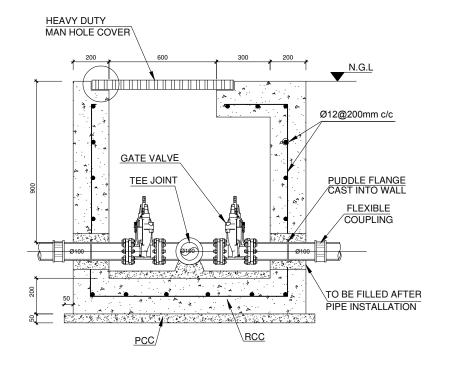
Consultancy Services for Survey, Design of Water supply Facilities in Tha.Vilifushi, F.Nilandhoo, B.Eydhafushi and Adh. Hanyaameedhoo, Maldives


BRINE PUMP DETAILS Tha. VILIFUSHI ISLAND

DESIGNED	DRAWN	CHECKED	APPROVED	SCALE	DATE				
SK	SR	MP	MA	1:50	09.12.'15				
PROJECT No.	SHEET No.	DRAWING No.							
K-627	1 OF 1	TV-WS-106							
REV. No.	_	1	1 7 770 100						



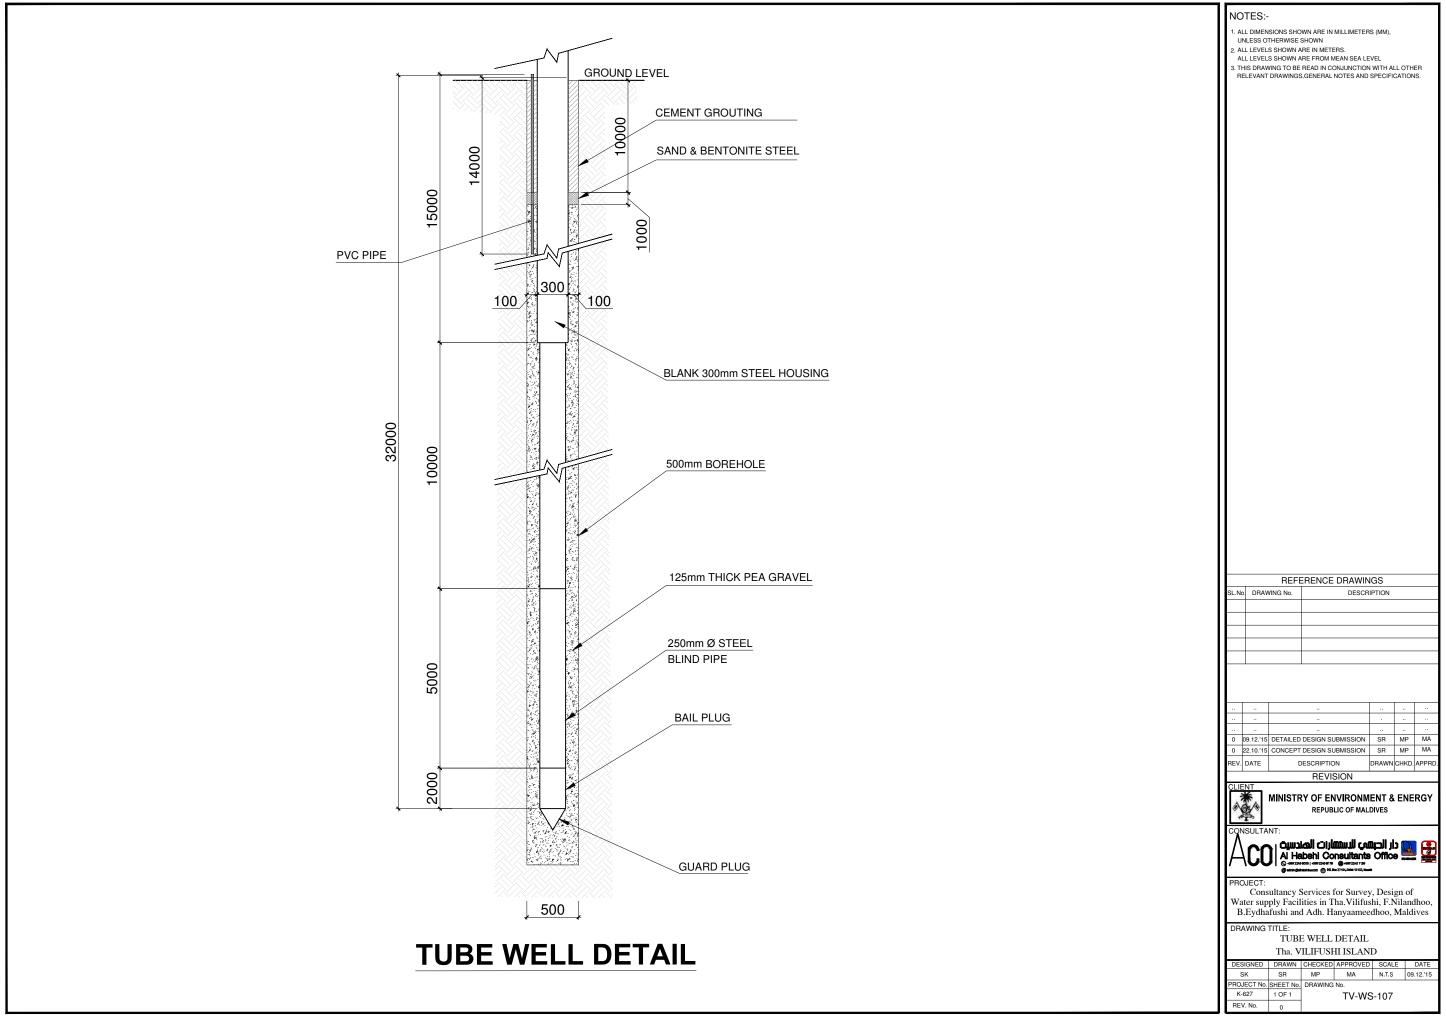

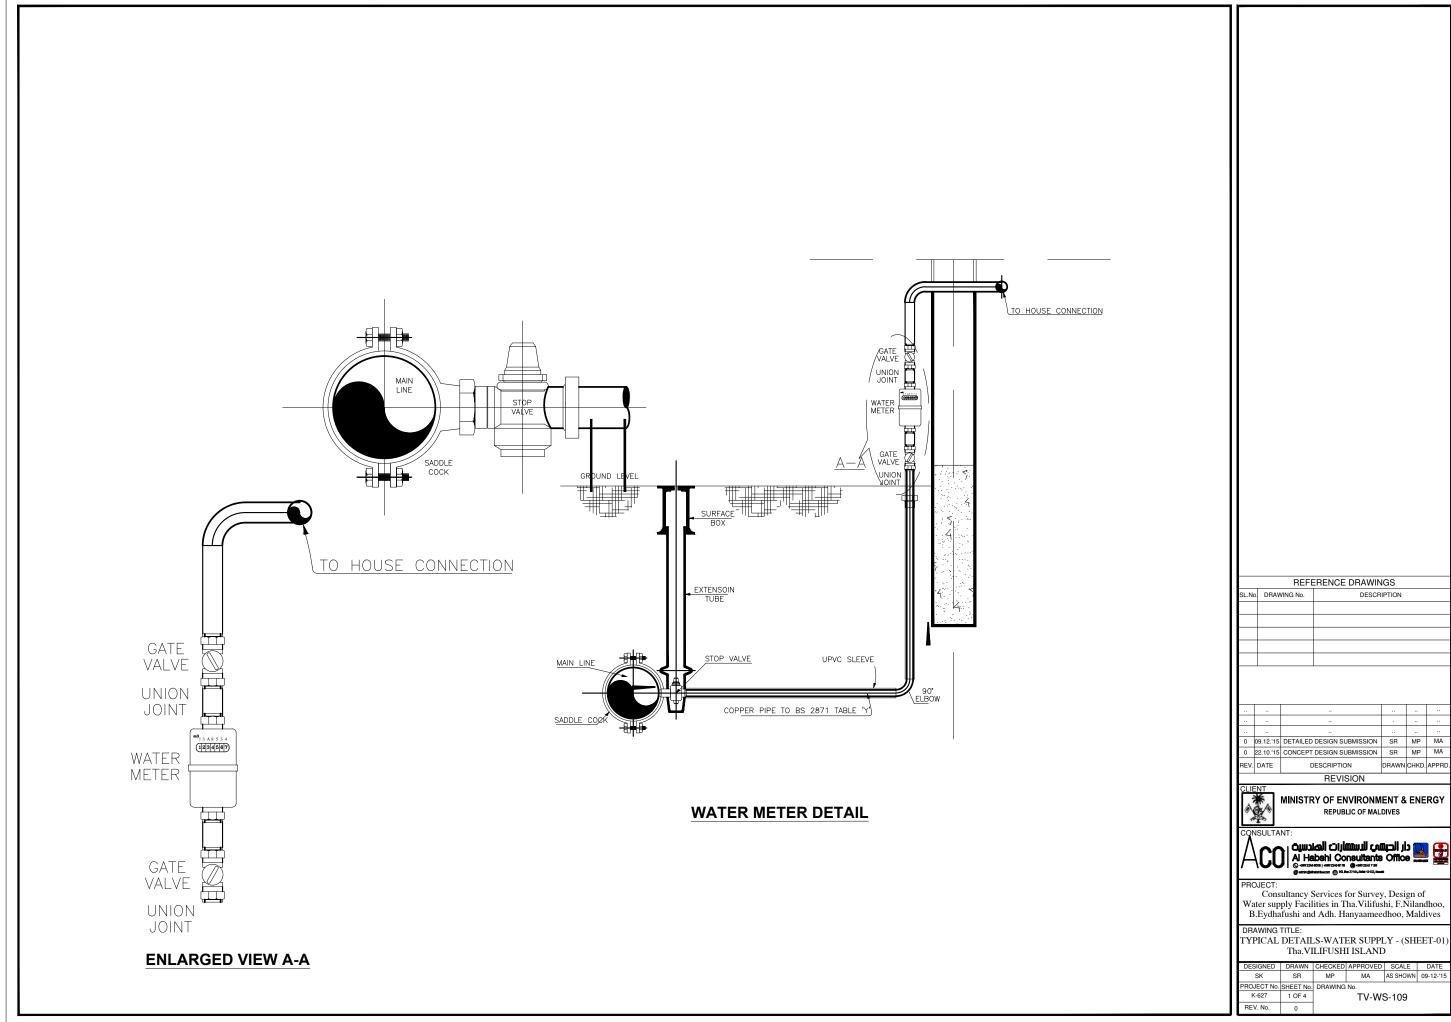

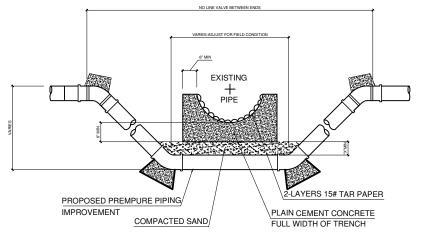

PIPE CROMPING DETAIL


"X" DIMENSION REQUIRMENTS

- A 6" FOR (GAS & OBT LINE CROMPING W/NO CRADLE NEEDED)
- B 18" FOR STORM SEWER PIPE
- C IF CROMPING SPACE IS MORE THAN MIN.SPACE OF CRADLE BELOE PIPE BOTTOM PLUS AFORMENTIONED "X" DIMENSION THEN EXTEND "X" DIMENSION TO MAKE UP DIFFERENCE.

CONCRETE CRADLE CONDITIONS


- A IF SANITORY OR SEWER PIPE JOINT IS WITHIN PROPOSED IMPROVEMENT TRENCH LIMIT
- B IF CROMPING SPACE IS LEMP THAN MIN.SPACE OF CRADLE BELOW PIPE BOTTOM PLUS "X" DIMENSION THEN OMIT SAND FILL AND USE CONCRETE

USE OF BENDS & THRUST BLOCKS OR JOINT DEFLECTION TO BE DETERMINED IN FIELD FOR EACH CROMPING

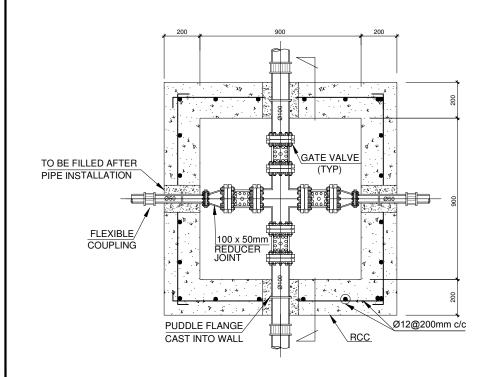

VALVE CHAMBER

MARKER TAPE BURIED 300mm DEEP BACK FILLING ABOVE CENTER LINE OF PIPE GROUND LEVEL MIN.COVER. SAND BED ALL AROUND PIPE UPVC WATER SUPPLY LINE INVERT LEVEL GROUNDWATER LEVEL OD + 300mm

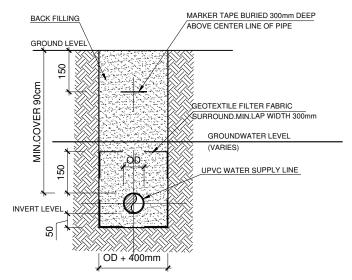

TYPICAL PIPE TRENCH DETAIL (WATER TABLE BELOW TRENCH BASE)

(WATER TABLE ABOVE TRENCH BASE)

TYPICAL PIPE TRENCH DETAIL


REFERENCE DRAWINGS .No. DRAWING No. 0 09.12.'15 DETAILED DESIGN SUBMISSION SR MP MA 0 22.10.'15 CONCEPT DESIGN SUBMISSION SR MP MA REVISION MINISTRY OF ENVIRONMENT & ENERGY REPUBLIC OF MALDIVES Consultancy Services for Survey, Design of Water supply Facilities in Tha.Vilifushi, F.Nilandhoo B.Eydhafushi and Adh. Hanyaameedhoo, Maldives


TYPICAL DETAILS-WATER SUPPLY - (SHEET-02 Tha.VILIFUSHI ISLAND


K-627 2 OF 4

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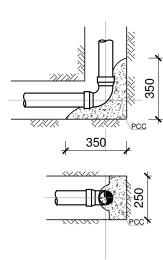
TV-WS-109



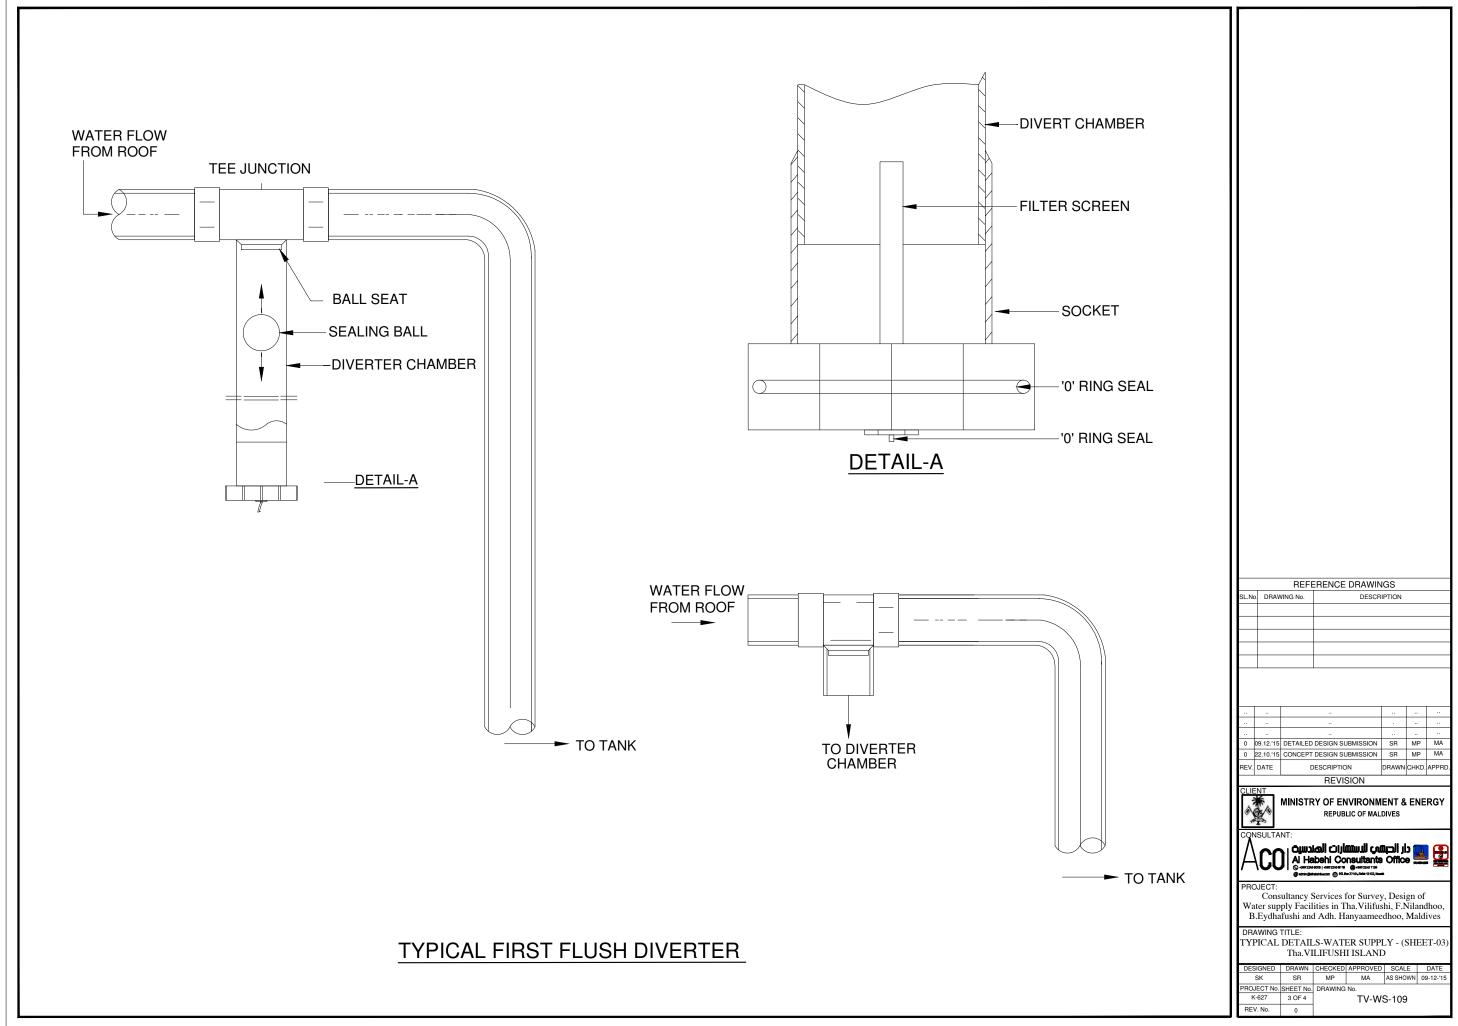


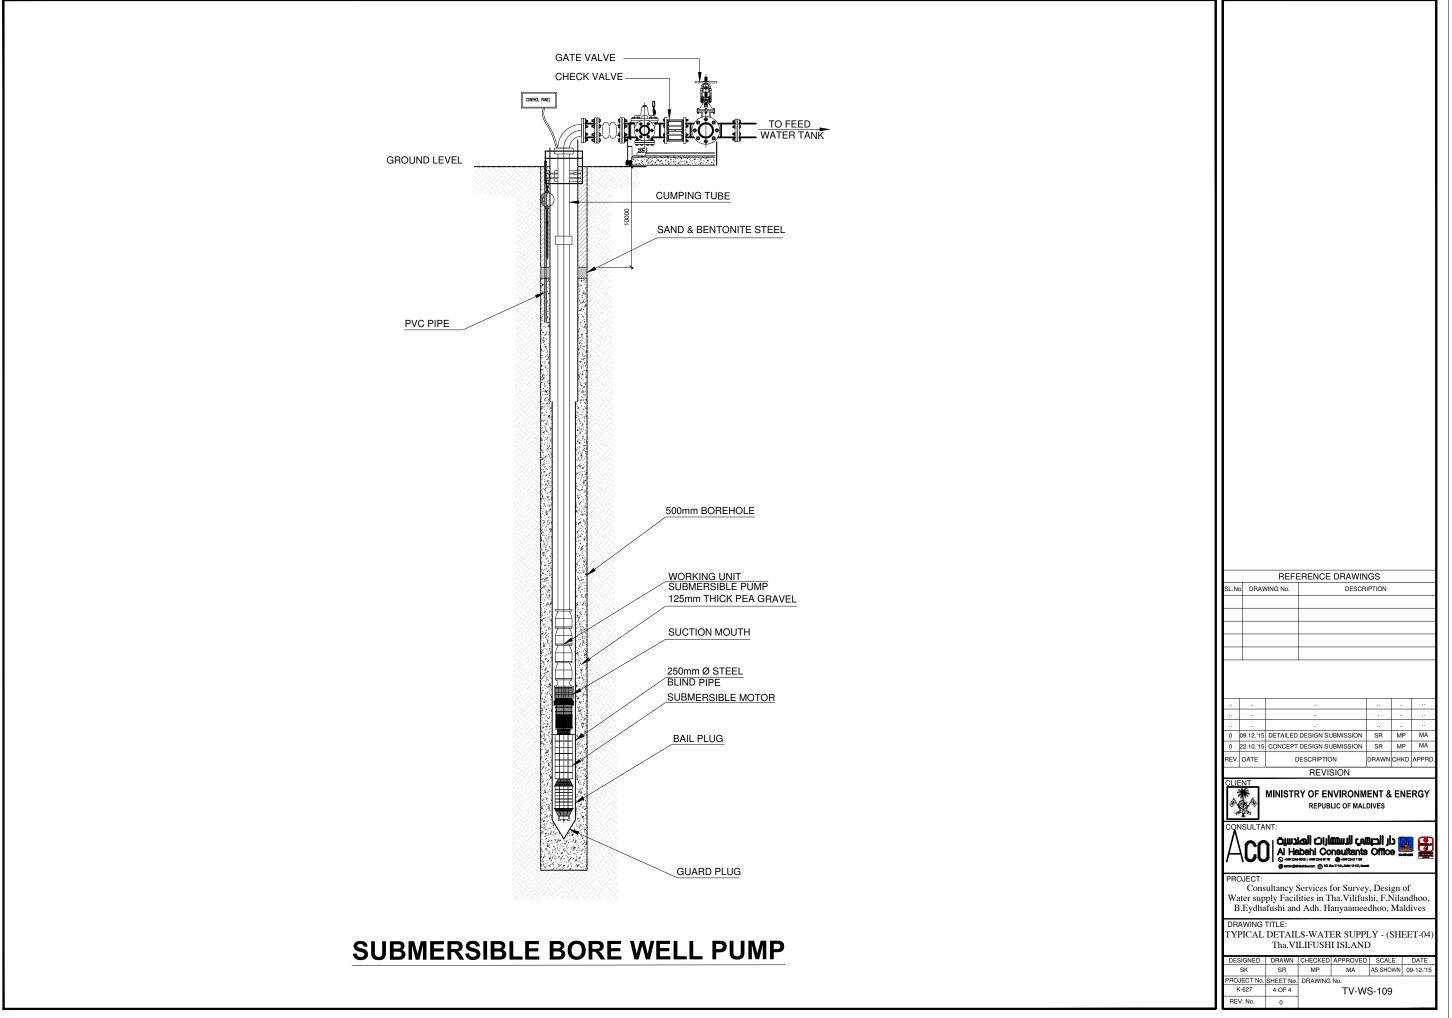

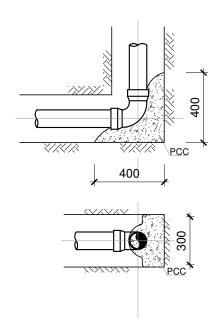





90° HORIZONTAL BEND (BTM) FOR Ø80 WS PIPE

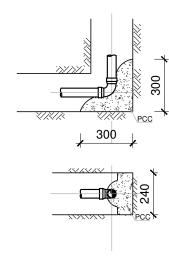


90° VERTICAL BEND (BTM) FOR Ø50 WS PIPE

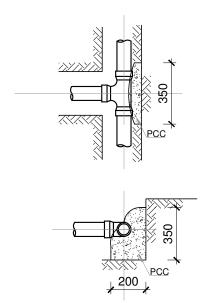



ANGLE BRANCH & TEE FOR Ø80 WS PIPE

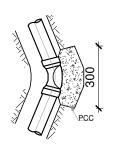

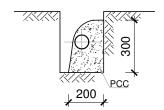


HORIZONTAL BEND FOR Ø80 WS PIPE

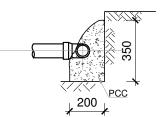

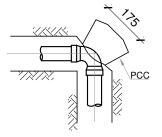


90° VERTICAL BEND (BTM) FOR Ø80 WS PIPE

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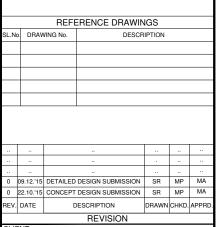
PLAN GRP WATER TANK

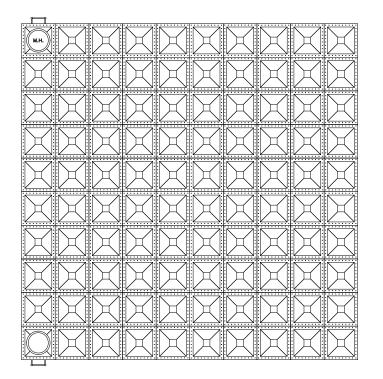- Size: 6000x5000x6000mm
- Size: 3000x5000x5000mm
- 3) Size: 6000x5000x6000mm
- 4) Size: 4000x3000x5000mm
- Size: 17000x15000x6000mm



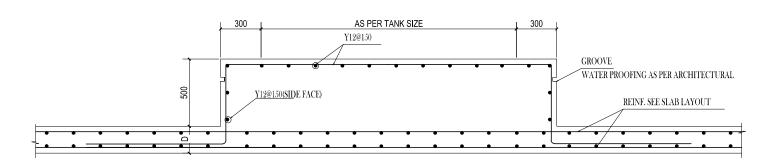

- I. ALL DIMENSION ARE IN MILLIMETER, UNLESS OTHERWISE
- 2. ALL LEVELS SHOWN ARE IN METERS.
- 3. THIS DRAWING TO BE READ IN CONJUNCTION WITH ALL OTHER RELEVANT DRAWINGS, GENERAL NOTES AND SPECIFICATIONS. 4. THE DESIGN IS INDICATIVE ONLY, THE CONTRACTOR TO DESIGN & BUILD THE TANK TOWER STRUCTURE.
- 5. WATER STOPS SHALL BE 210x9mm THICK MULTI-RIB TYPE WITH CANTER BULB FOR CONSTRUCTION, CONTROL AND EXPANSION JOINTS.



MINISTRY OF ENVIRONMENT & ENERGY REPUBLIC OF MALDIVES

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Al Habehi Consultants Office


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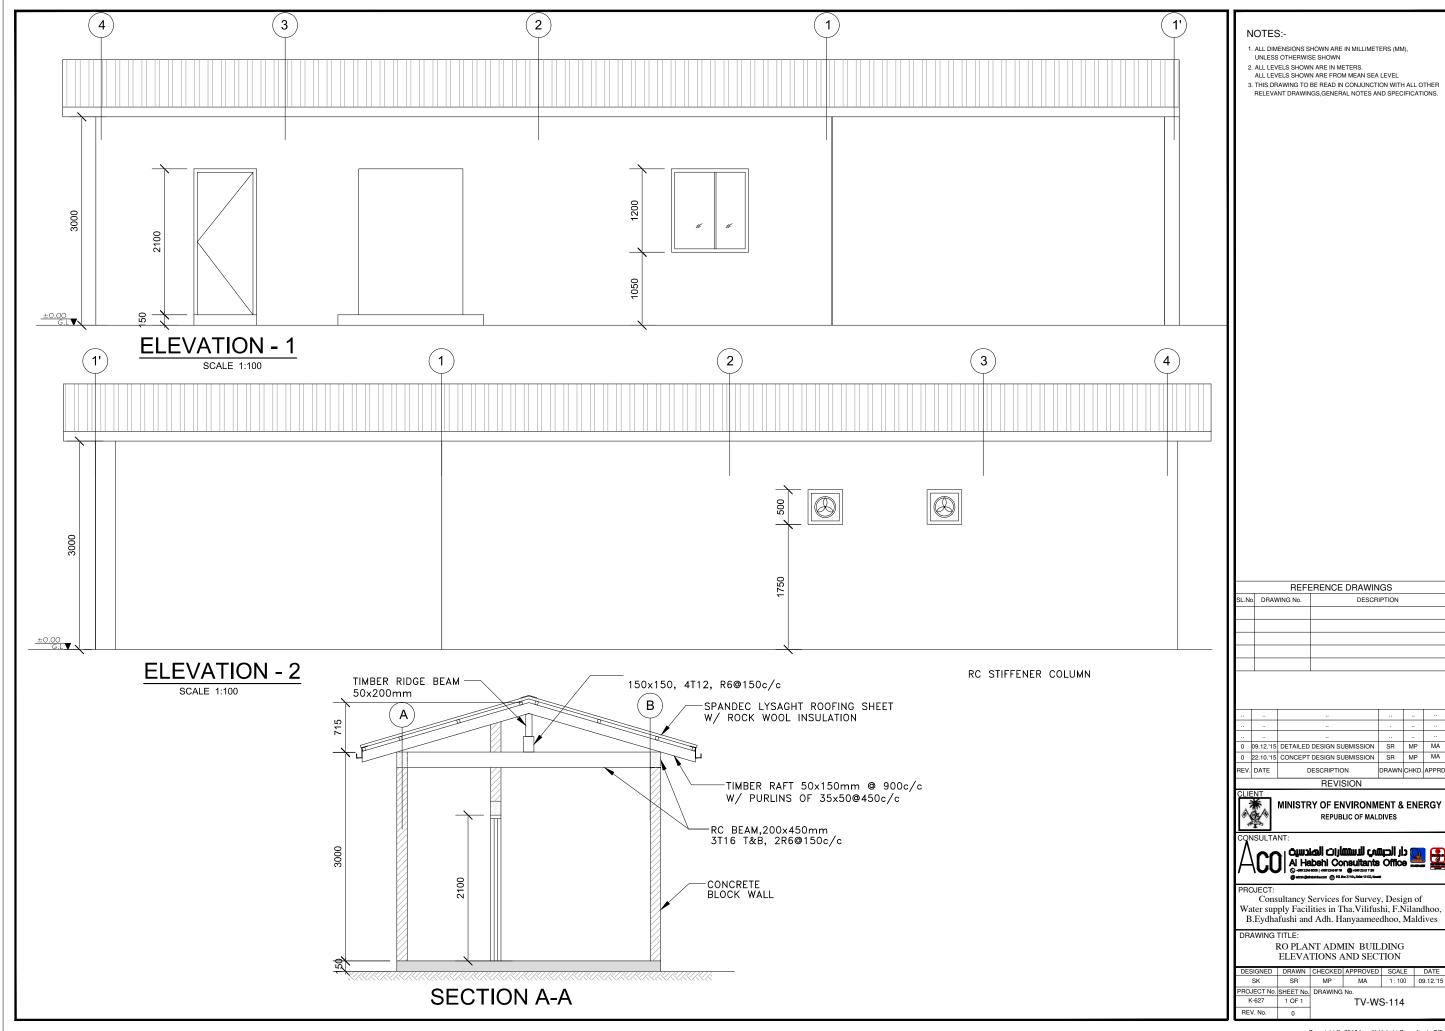
Consultancy Services for Survey, Design of Water supply Facilities in Tha. Vilifushi, F.Nilandhoo, B.Eydhafushi and Adh. Hanyaameedhoo, Maldives


GRP WATER TANK Tha, VILIFUSHI ISLAND


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PROJECT No.	SHEET No.	DRAWING	No.		
K-627	1 OF 1		TV-WS	S-111	
REV. No.	0				

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				FANS	SCHE	DULE					
REFERENCE	LOCATION	SERVICE	FLOW RATE	SP		POW	ER		FAN SPEED	FAN	REMARKS
	AREA	AREA	CFM	IWG	KW	VOLTS	PH	HZ	RPM	FAN TYPE	Constitution of the Consti
EXF-1	LABORATORY	LABORATORY	120	0.5	0.25	230	1	50	1450	AXAL	
EXF-2	TOILET	TOILET	60	0.5	0.25	230	1	50	1450	AXAL	

TYP.EXHAUST FAN

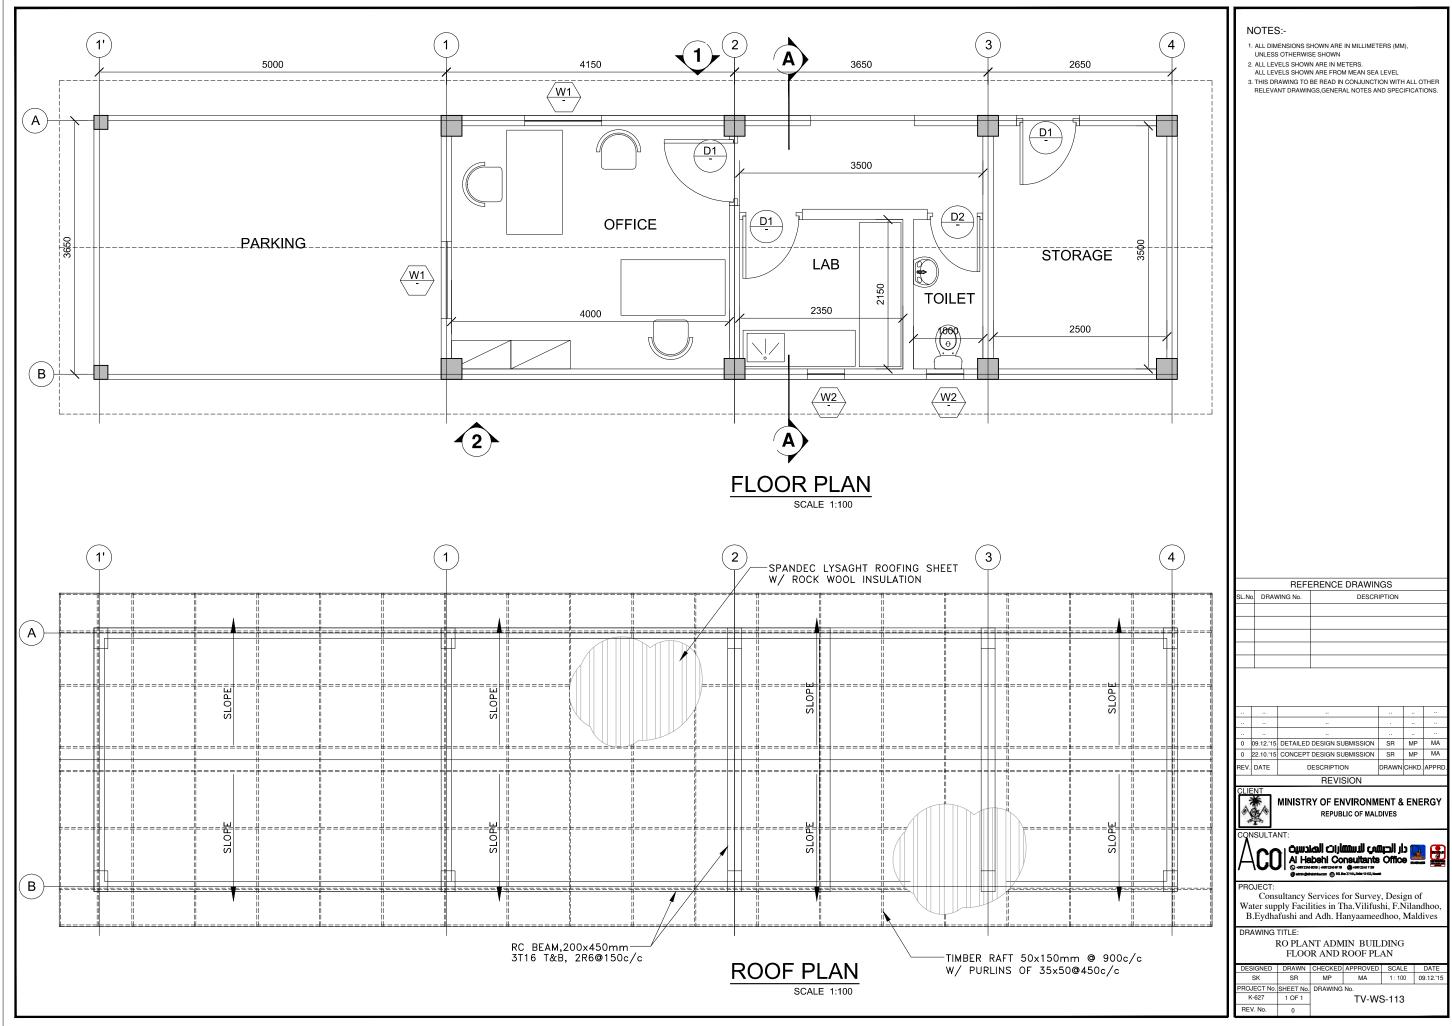
EXHAUST FAN SCHEDULE

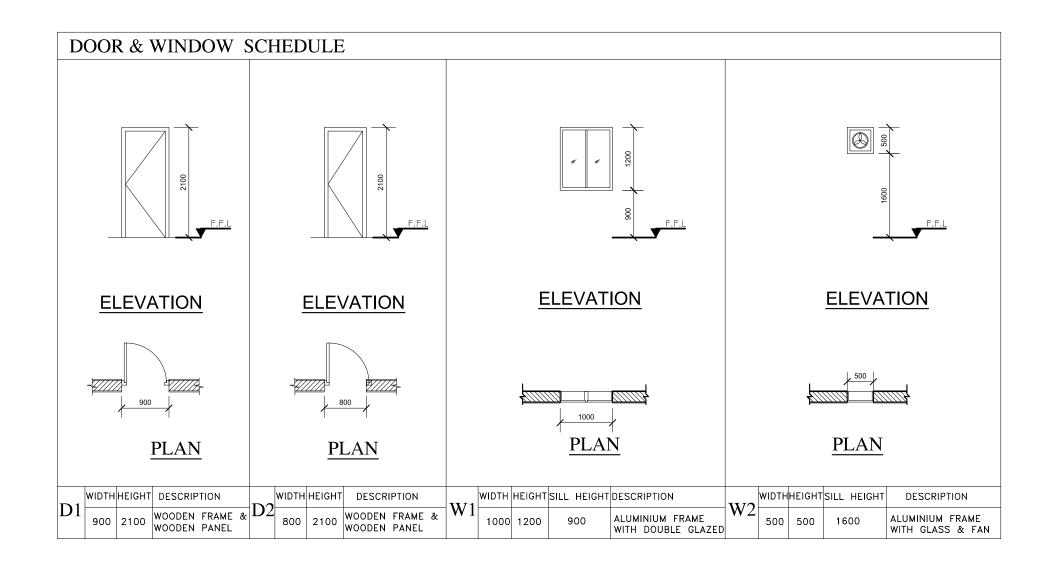
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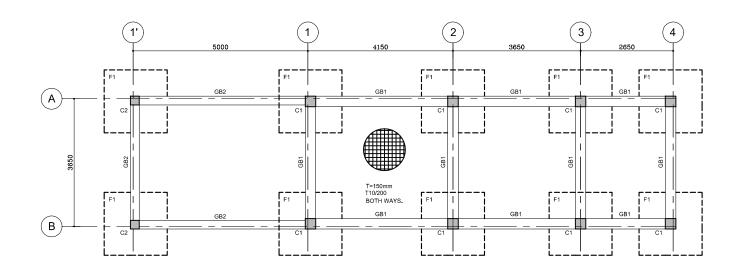
- ALL DIMENSIONS SHOWN ARE IN MILLIMETERS (MM), UNLESS OTHERWISE SHOWN
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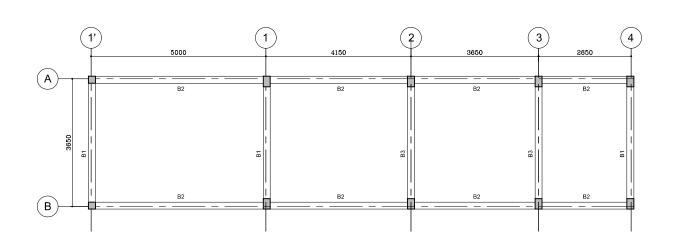
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TV-WS-115

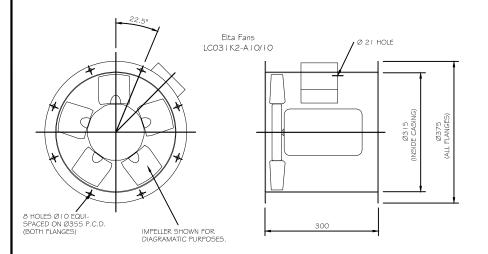






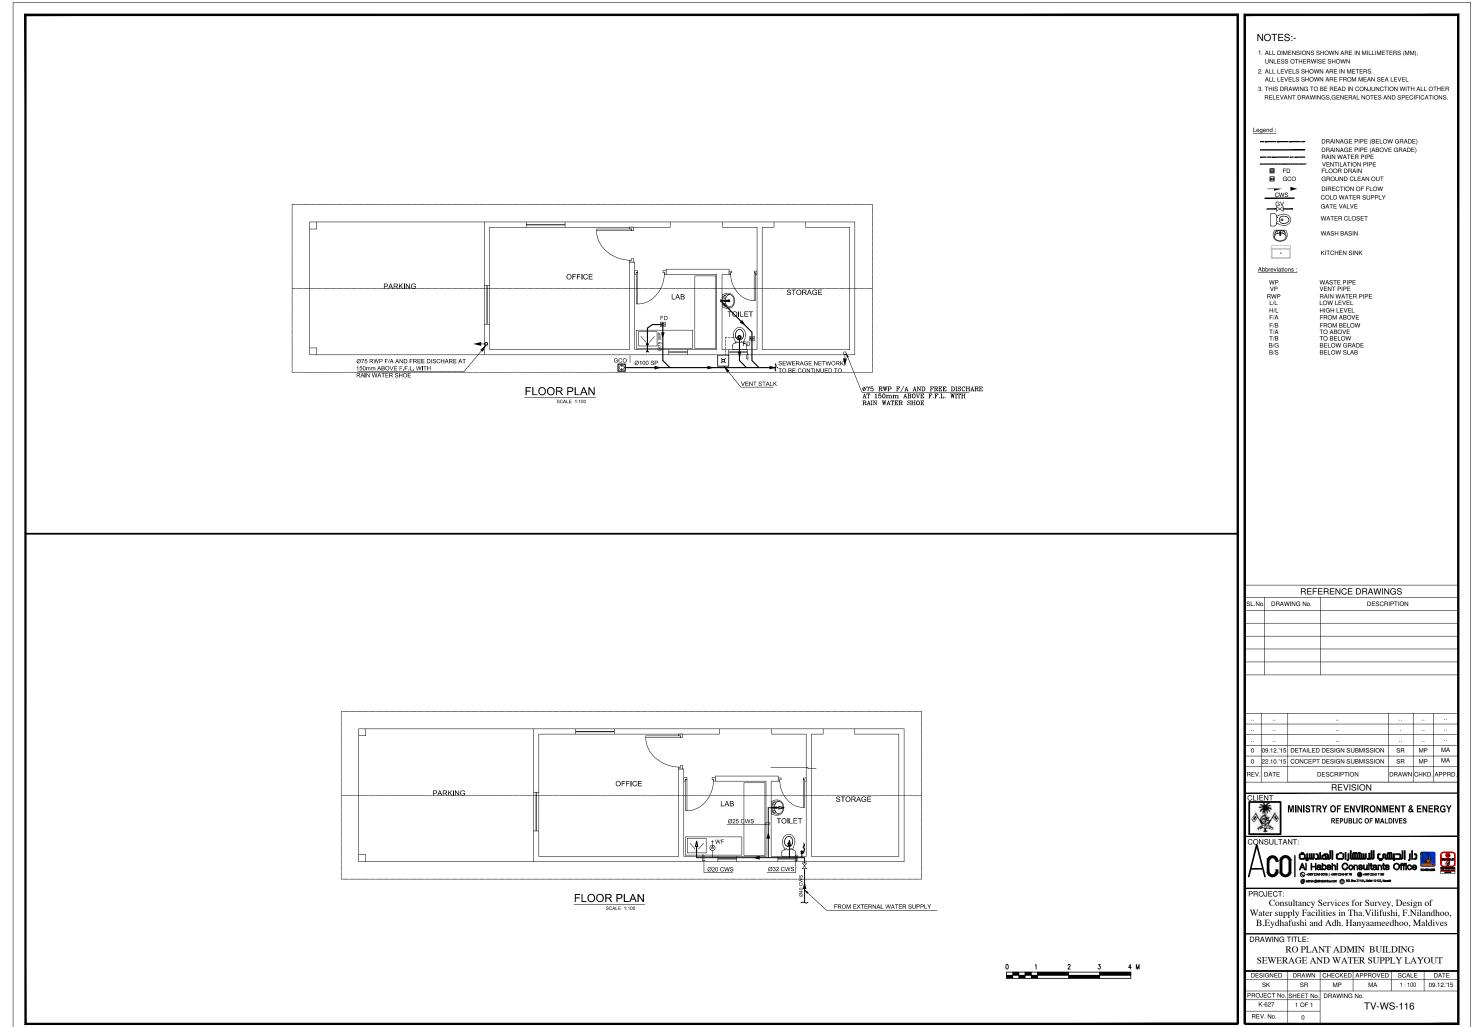

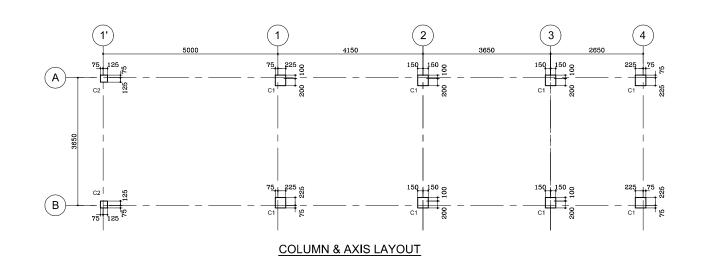ROOF BEAM LAYOUT


FOOTING & GRADE BEAM LAYOUT

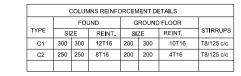


MARK		DIMENSIO	N	REINFORCEMENT	BOXED	REMARKS
W/AICIC	L	W	Н		BOXED	REMARKS
F1	1800	1800	400	T12@100 c/c B/W, T&B		

	GRADE BEAM REINFORCEMENT DETAILS										
MARK	SIZ	E	воттом	TOP	STIRRUPS	SIDE	DELLABOR				
IVIARK	b	h	BARS	BARS	STIRRUPS	BARS	REMARKS				
GB1	300	300	4T16	3T16	T6/125 c/c						
GB2	250	300	4T16	3T16	T6/125 c/c						

	BEAM REINFORCEMENT DETAILS										
MARK	SIZ	E	воттом	TOP	STIRRUPS	SIDE	REMARKS				
WALKIN	b	h	BARS	BARS	STIKKUFS	BARS	REMARKS				
B1	200	500	5T16	3T16	T6/125 c/c						
B2	200	500	4T16	3T16	T6/125 c/c						
В3	200	500	5T16	3T16	T6/100 c/c						

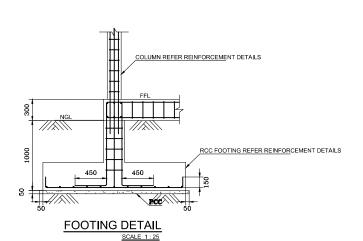

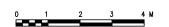

NOTES:-

- 1. ALL DIMENSIONS SHOWN ARE IN MILLIMETERS (MM),

- UNLESS OTHERWISE SHOWN

 2. ALL LEVELS SHOWN ARE IN METERS.
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- INVESTIGATION TO CONFORM THE BEARING CAPACITY OF S 150 KN / M²
 4. THE CONCRETE COVER TO ALL REINFORCEMENT SHALL BE

- 4. INE CONCENTE COVERT TO ALL REINFORCEMENT SHALL
 AS FOLLOW:
 COLUMN / BEAM = 40 mm
 SLAB = 30 mm
 FOUNDATION = 50 mm

 5. WATER CEMENT RATIO SHALL BE 0.50

 6. FOR ALL GENERAL NOTES REFER BY DWG UT-GN-01
- 7. GRADE OF CONCRETE IS M30 AND GRADE OF STEEL IS Fy 460

LEGEND:-

1. NGL - NATURAL GROUND LEVEL 2. FFL - FINISHED FLOOR LEVEL 3. PCC - PLAIN CEMENT CONCRETE

ABBREVIATIONS:-

- GRID MARK (HORIZONTAL)



- GRID MARK (VERTICAL)

REFERENCE DRAWINGS

SL.No. DRAWING No. DESCRIPTION

0 09.12.15 DETAILED DESIGN SUBMISSION SR MP MA 0 22.10.'15 CONCEPT DESIGN SUBMISSION SR MP MA REV. DATE DESCRIPTION

REVISION



MINISTRY OF ENVIRONMENT & ENERGY REPUBLIC OF MALDIVES




Consultancy Services for Survey, Design of Water supply Facilities in Tha. Vilifushi, F.Nilandhoo, B.Eydhafushi and Adh. Hanyaameedhoo, Maldives

RO PLANT ADMIN BUILDING
STRUCTURAL DRAWINGS

SK SR MP MA 1:100 09.12.'1 PROJECT No. SHEET No. DRAWING No K-627 1 OF 1 TV-WS-117 REV. No.

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GB1

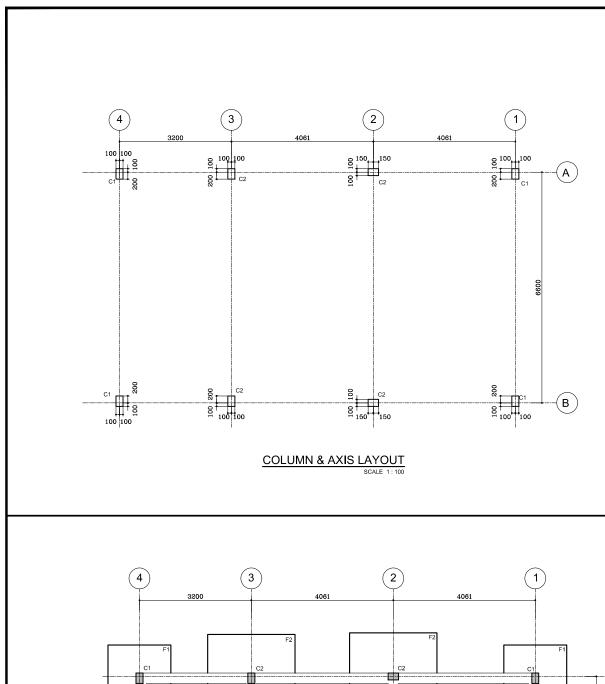FOOTING & GRADE BEAM LAYOUT

SCALE 1:100

T=250mm Y12/200 BOTH WAYS. T&B

COLUMNS REINFORCEMENT DETAILS										
	FOUND			G	ROUND					
TYPE	SIZE		REINT.	SIZE		REINT.	STIRRUPS			
C1	200	300	6Y16	200	200	4Y16	Y8/200			
C2	200	300	8Y16	200	300	8Y16	Y8/200			

FOOTING REINFORCEMENT DETAILS											
MARK		DIMENSIO	N	REINFORCEMENT		BOXED	REMARKS				
	L	W	Н	WIDTH	LENGTH	b	T LIMATO				
F1	1800	1800	300	5Y16/m	5Y16/m						
F2	2500	2500	400	8Y16/m	8Y16/m						
				•	•		•				

GRADE BEAM REINFORCEMENT DETAILS									
MARK	SIZE		воттом	TOP	STIRRUPS	SIDE	REMARKS		
	b	h	BARS	BARS	O I I I I I I I	BARS	I TEMPORATO		
GB1	300	300	3Y16	3Y16	Y8/200				
					•		•		

	BEAM REINFORCEMENT DETAILS											
MARK S	SIZE		воттом	TOP	OTIDDUDO	SIDE						
	b	h	BARS	BARS	STIRRUPS	BARS	REMARKS					
B1	200	500	3Y16 + 2Y16	2Y16	Y8/150							
B2	200	400	3Y16	3Y16	Y8/150							
В3	200	400	5Y16	3Y16	Y8/150							
						•						

	SLABS REINFORCEMENT DETAILS										
MARK	THICK	REINFORCE	REMARKS								
IVIARIA	THICK	WIDTH LENGTH									
S1	150	Y10/150	Y10/150								



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4. CONTRACTOR SHALL CONDUCT INDEPENDENT GEOTECHNICAL INVESTIGATION TO CONFORM THE BEARING CAPACITY OF SOIL 65 KN / M AT 1M DEPTH AS DESIGNED IS APPROPRIATE SHOULD THERE BE A VARIANCE CONTRACTOR SHALL REVISE THE DESIGN TO CONSTRUCT THE WORK

5. THE CONCRETE COVER TO ALL REINFORCEMENT SHALL BE AS FOLLOW:

COLUMN / BEAM = 40 mm
SLAB = 30 mm
FOUNDATION = 50 mm

6. WATER CEMENT RATIC SHALL RE 0.50

WATER CEMENT RATIO SHALL BE 0.50
 FOR ALL GENERAL NOTES REFER BY DWG_UT-GN-01

LEGEND:-

1. NGL - NATURAL GROUND LEVEL 2. FFL - FINISHED FLOOR LEVEL 3. PCC - PLAIN CEMENT CONCRETE

ABBREVIATIONS:-




GRID LINE - GRID MARK (HORIZONTAL)



- GRID MARK (VERTICAL)

4061	1		
F2	C1 F1	A)	
189	081	0099	
F2 C2	F1 C1	В	

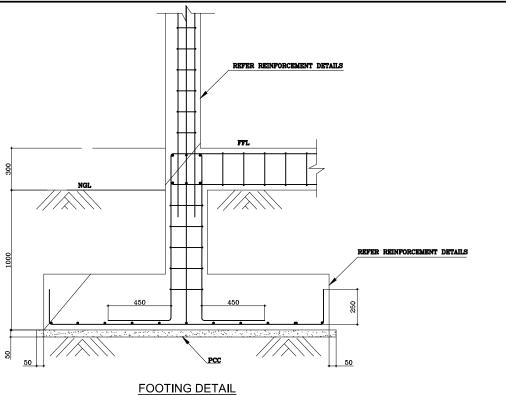

		REF	EREN	CE DR	AWIN	IGS				
SL.No.	DRAV	VING No.	DESCRIPTION							
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0 09.12.15 DETAILED DESIGN SUBMISSION SR MP MA 0 22.10.15 CONCEPT DESIGN SUBMISSION SR MP MA REV. DATE REVISION


MINISTRY OF ENVIRONMENT & ENERGY REPUBLIC OF MALDIVES



Consultancy Services for Survey, Design of Water supply Facilities in Tha. Vilifushi, F.Nilandhoo, B.Eydhafushi and Adh. Hanyaameedhoo, Maldives

REVERSE OSMOSIS UNIT STRUCTURAL PLANS Tha.VILIFUSHI ISLAND

DESIGNED	DRAWN	CHECKED	APPROVED	SCALE	DATE		
SK	SR	MP	MA	1:100	09.12.'15		
PROJECT No.	SHEET No.	. DRAWING No.					
K-627	1 OF 1	TV-WS-119					
DEV No	•						

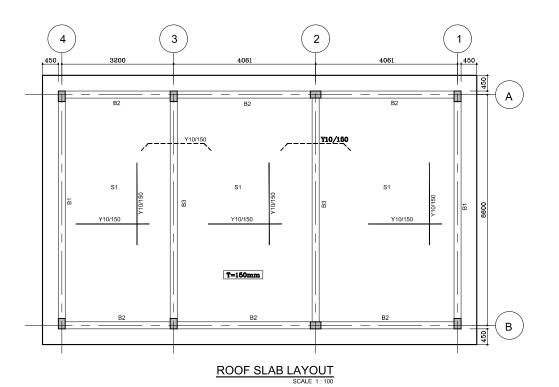

COLUMNS REINFORCEMENT DETAILS												
		FOL	JND	G	ROUND							
TYPE	SIZE		REINT.	SIZE		REINT.	STIRRUPS					
C1	200	300	6Y16	200	200	4Y16	Y8/200					
C2	200	300	8Y16	200	300	8Y16	Y8/200					
			•			•						

	FOOTING REINFORCEMENT DETAILS												
MARK		DIMENSIO	N	REINFOR	CEMENT	BOXED	REMARKS						
WIFTE	L	W	Н	WIDTH	LENGTH	BOXED							
F1	1800	1800	300	5Y16/m	5Y16/m								
F2	2500	2500	400	8Y16/m	8Y16/m								

GRADE BEAM REINFORCEMENT DETAILS										
MARK	SIZ b	E h	BOTTOM BARS	TOP BARS STIRRUPS		SIDE BARS	REMARKS			
GB1	300	300	3Y16	3Y16	Y8/200					
					•	•	•			

	BEAM REINFORCEMENT DETAILS										
MARK	SIZE b h		BOTTOM BARS	TOP BARS	STIRRUPS	SIDE BARS	REMARKS				
B1	200	500	3Y16 + 2Y16	2Y16	Y8/150						
B2	200	400	3Y16	3Y16	Y8/150						
В3	200	400	5Y16	3Y16	Y8/150						
			•				•				

SLABS REINFORCEMENT DETAILS								
MARK	THICK	REINFORCE	REMARKS					
WARK		WIDTH	LENGTH					
S1	150	Y10/150	Y10/150					

- 1. ALL DIMENSIONS ARE IN MILLIMETERS (MM).
- 2. ALL LEVELS SHOWN ARE IN METERS.
- THIS DRAWING TO BE READ IN CONJUNCTION WITH ALL OTHER RELEVANT DRAWINGS, GENERAL NOTES AND SPECIFICATIONS.
 CONTRACTOR SHALL CONDUCT INDEPENDENT GEOTECHNICAL INVESTIGATION TO CONFORM THE BEARING CAPACITY OF SOIL 65 KN / M AT IM DEPTH AS DESIGNED IS APPROPRIATE SHOULD THERE BE A VARIANCE CONTRACTOR SHALL REVISE THE DESIGN TO CONSTRUCT THE WORK
- 5. THE CONCRETE COVER TO ALL REINFORCEMENT SHALL BE 5. THE CONCRETE COVERT TO ALL HEINFORCEMENT SHALL
 AS FOLLOW.

 COLLIMN / BEAM = 40 mm
 SLAB = 30 mm
 FOUNDATION = 50 mm
 6. WATER CEMENT RATIO SHALL BE 0.50
 7. FOR ALL GENERAL NOTES REFER BY DWG UT-GN-01

LEGEND:-

1. NGL - NATURAL GROUND LEVEL 2. FFL - FINISHED FLOOR LEVEL 3. PCC - PLAIN CEMENT CONCRETE

ABBREVIATIONS:-





- GRID MARK (VERTICAL)

	REFERENCE DRAWINGS							
0.	DRAWING No.	DESCRIPTION						
_								

		**			
		**	-		
0	09.12.'15	DETAILED DESIGN SUBMISSION	SR	MP	MA
0	22.10.'15	CONCEPT DESIGN SUBMISSION	SR	MP	MA
REV.	DATE	DESCRIPTION	DRAWN	CHKD.	APPRE

REVISION




MINISTRY OF ENVIRONMENT & ENERGY REPUBLIC OF MALDIVES

COL | Communication | Consultants Office |
Al Haberl Consultants Office |
Omercan office |

Consultancy Services for Survey, Design of Water supply Facilities in Tha. Vilifushi, F.Nilandhoo, B.Eydhafushi and Adh. Hanyaameedhoo, Maldives

REVERSE OSMOSIS UNIT STRUCTURAL DETAIL & SCHEDULES


DE:	SIGNED	DRAWN	CHECKED	APPROVED	SCALE	DATE	
	SK	SR	MP	MA	AS SHOWN	09.12.'15	
PRO	JECT No.	SHEET No.	DRAWING	No.			
ŀ	(-627	1 OF 1	TV-WS-120				
			1				

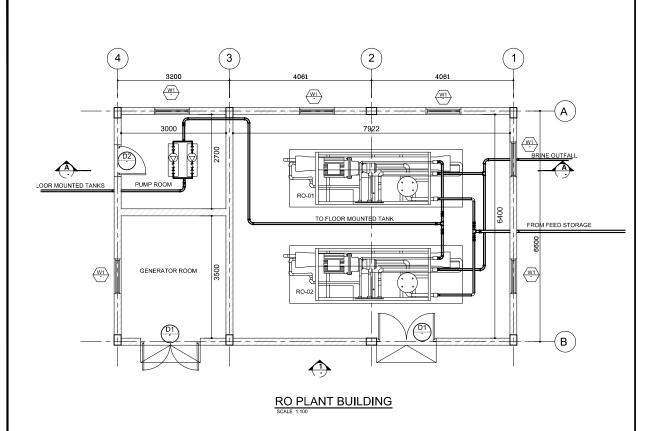

(3) (2) (4) ±0.00 GF.F.L_ VIEW-1 SCALE 1:100

NOTES:-

- ALL DIMENSION ARE IN MILLIMETER (MM),UNLESS OTHERWISE NOTED
 ALL LEVELS SHOWN ARE IN METERS.
- THIS DRAWING TO BE READ IN CONJUNCTION WITH ALL OTHER RELEVANT DRAWINGS, GENERAL NOTES AND SPECIFICATIONS.

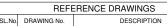

DESCRIPTION

 **			

0 09.12.15 DETAILED DESIGN SUBMISSION SR MP MA 0 22.10.15 CONCEPT DESIGN SUBMISSION SR MP MA DESCRIPTION REVISION

MINISTRY OF ENVIRONMENT & ENERGY REPUBLIC OF MALDIVES

Consultancy Services for Survey, Design of Water supply Facilities in Tha. Vilifushi, F.Nilandhoo, B.Eydhafushi and Adh. Hanyaameedhoo, Maldives

REVERSE OSMOSIS UNIT DETAILS Tha.VILIFUSHI ISLAND

DESIGNED	DRAWN	CHECKED	APPROVED	SCALE	DATE
SK	SR	MP	MA	1:100	09.12.'15
PROJECT No.	SHEET No.	DRAWING	No.		
K-627	1 OF 1		TV-WS	S-121	
REV. No.	0				
	SK PROJECT No. K-627	SK SR PROJECT No. SHEET No. K-627 1 OF 1	SK SR MP PROJECT No. SHEET No. DRAWING K-627 1 OF 1	SK SR MP MA PROJECT No. SHEET No. K-627 DRAWING No. TV-WS	SK SR MP MA 1 : 100 PROJECT No. SHEET No. K-627 DRAWING No. TV-WS-121

DOOR & LOUVER SCHEDULE 2000 LOUVERS LOUVERS WIDTH HEIGHT DESCRIPTION WIDTH HEIGHT DESCRIPTION 1W1 | 1000 WIDTH HEIGHT DESCRIPTION D2 D1 STEEL FRAME WITH LOUVERS STEEL DOOR WITH LOUVERS STEEL DOOR WITH LOUVERS 2500 1000 2000 2000

RO PLANT SCHEDULE FOR XXXXXXX ISLAND MOTOR


35 KW(46.90 BHP)


400-415/3/50


25.0M /HRS

REMARKS

TWO NOS OF RO PLANT WORKING ACCORDING TO FLOAT SENSOR

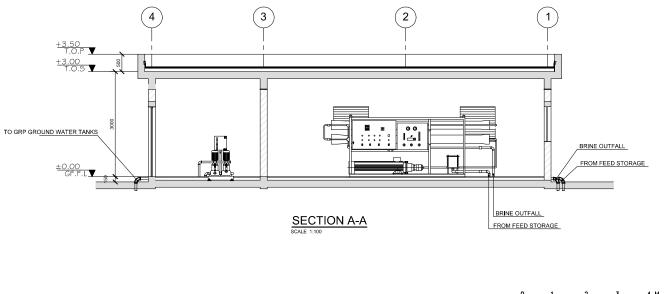

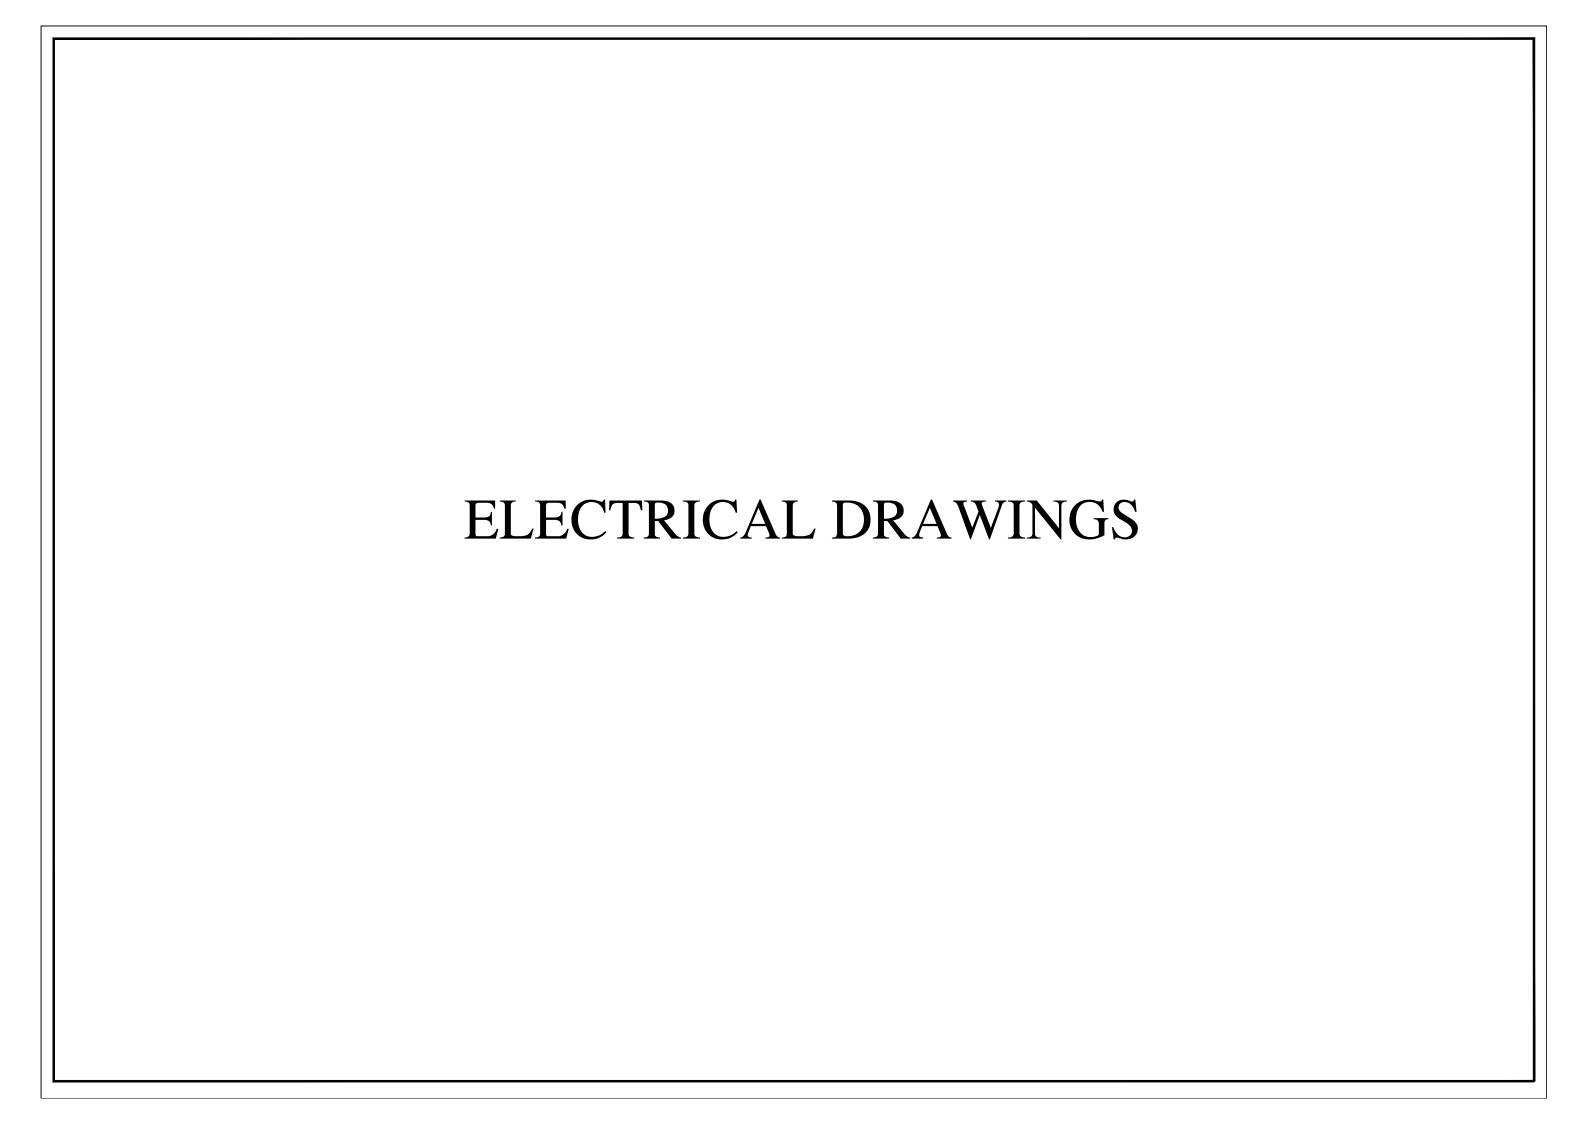

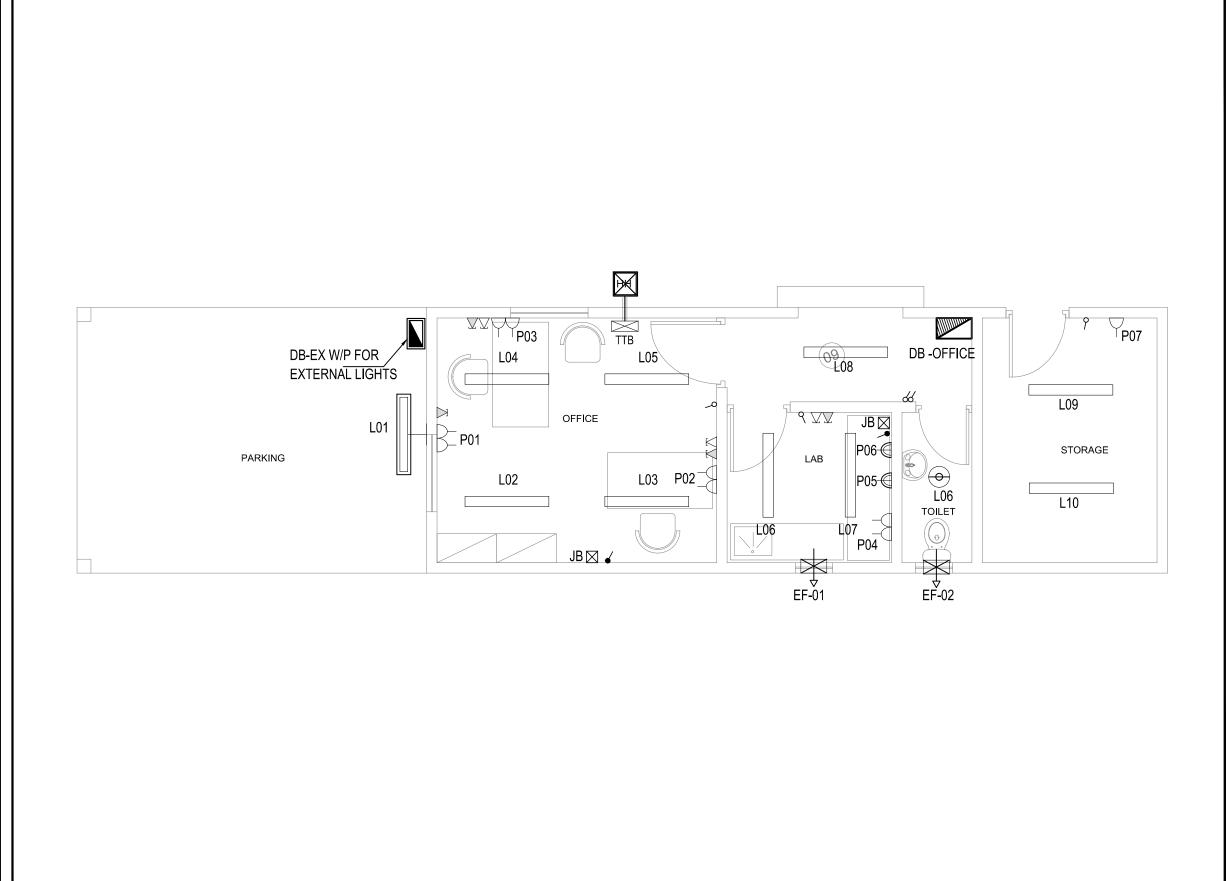

NOTES:-

- 1. ALL DIMENSIONS ARE IN mm EXCEPT AND OTHERWISE SPECIFICD.
 2. THIS DRAWING TO BE READ IN CONJUNCTION WITH ALL OTHER RELEVANT DRAWINGS AND SPECIFICATIONS.
 3. ALL ABOVE GROUND CONDUIT SHALL BE RIGID HOT DIP GALVANIZED EXCEPT AS NOTED.
- 4. ALL NEMA 3R GASKETED S.S ENCLOSURES TO HAVE LOCKABLE HANDLE AND 3 POINT LATCHING.

LEGENDS

TYPE	SYMBOL	DESCRIPTION
В		1 x 40W SURFACE MOUNTED FLUORESCENT LIGHT FITING
С		1 x 40W WALL MOUNTED FLUORESCENT LIGHT FITING-WEATHERPROOF
E	⊕	1x60W SURFACE MOUNTED FLUORESCENT DOWN LIGHT - WEATHERPROOF
	\vdash	5A SWITCHED SOCKET OUTLET (1000W)
	Δ	5A SWITCHED SOCKET OUTLET AT HIGHT LEVEL-WEATHER PROOF (1000W)
	\Box	13A TWIN SWITCHED SOCKET OUTLET
	⊠	JUNCTION BOX
	4	20A DP SWITCH
	*	EXHAUST FAN (80W)
	TTB	TELEPHONE TERMINAL BOX
	\triangle	SINGLE OUTLET FOR DATA
	\square	SINGLE OUTLET FOR VOICE
	\bowtie	0.6x0.6x0.6m HAND HOLE

REFERENCE DRAWINGS SL.No DRAWING No.

DESCRIPTION

0 28-12-'15 DETAILED DESIGN SUBMISSION BA RDS MA DESCRIPTION

REVISION





MINISTRY OF ENVIRONMENT & ENERGY REPUBLIC OF MALDIVES


دار الحبسي لاستشارات الملدسية (Al Habshi Consultants Office

Consultancy Services for Survey, Design of Water supply Facilities in Tha. Vilifushi, F.Nilandhoo, B.Eydhafushi and Adh. Hanyaameedhoo, Maldives

PROJECT No. SHEET No. DRAWING NO.
K-627 1 OF 1 TV-EL-100 REV. No.

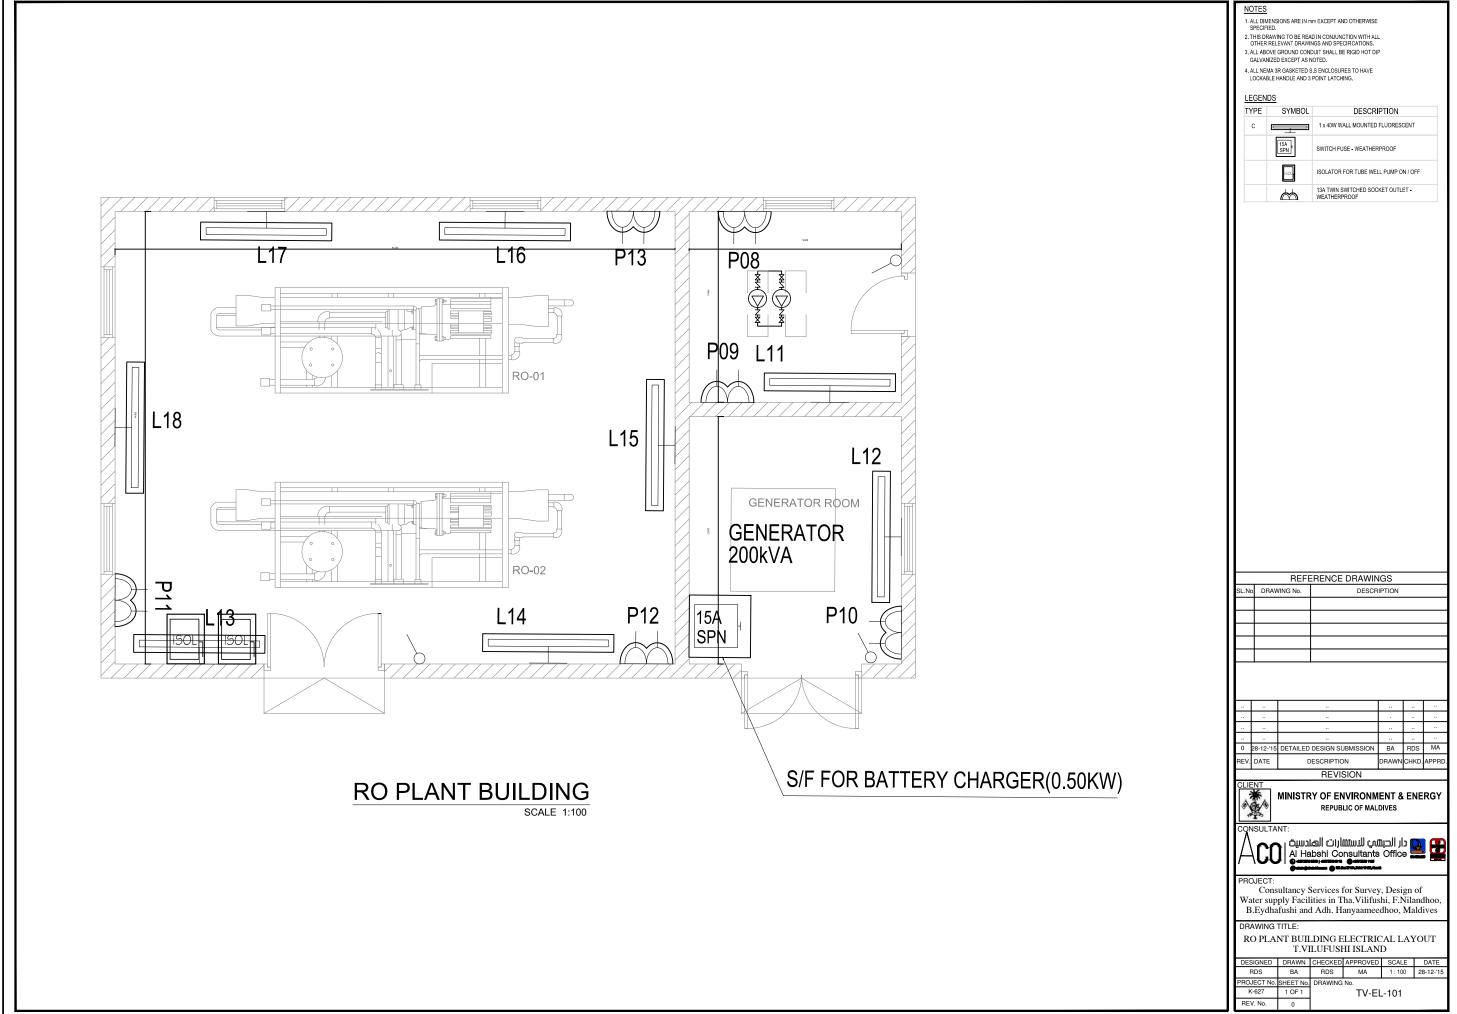

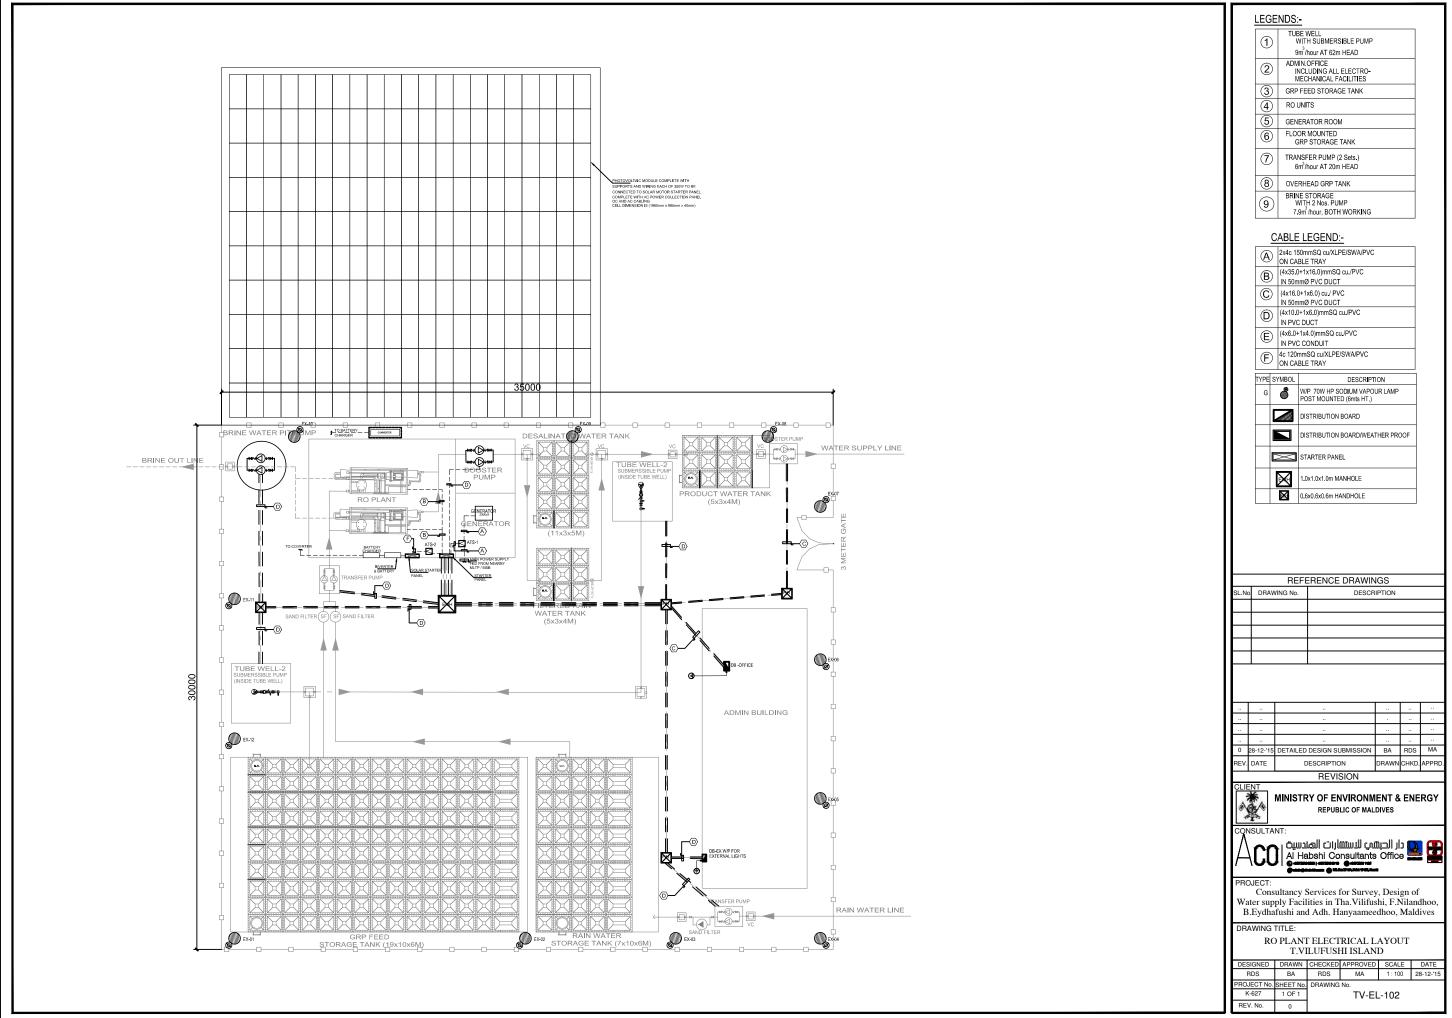

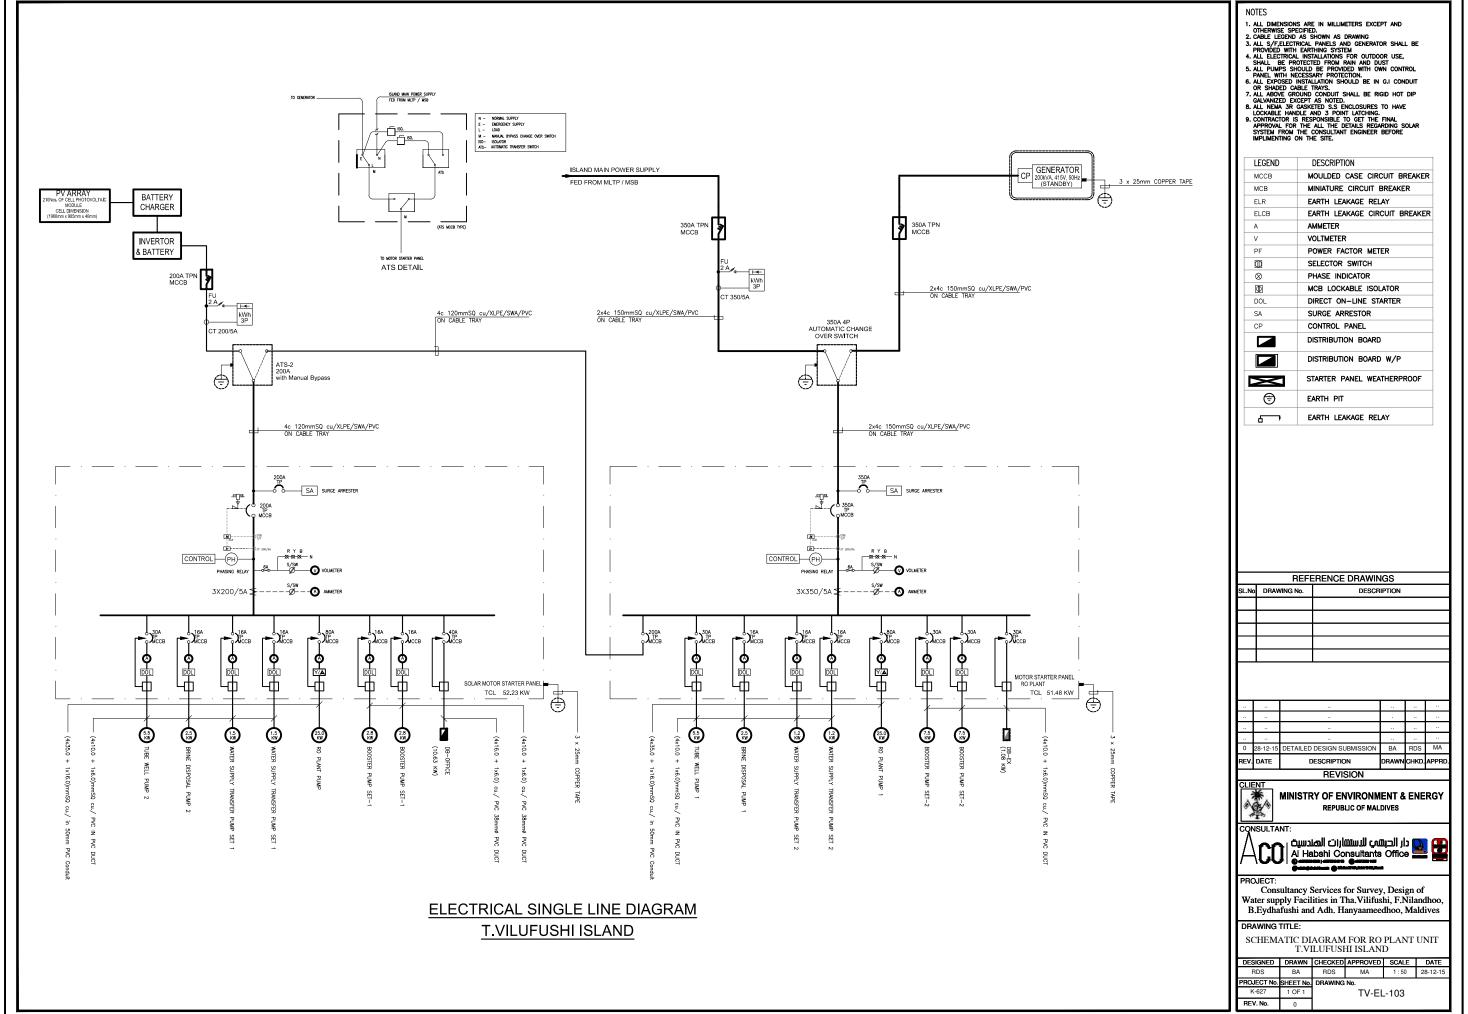

DB-OFFICE

LOCATION: ADMIN BUILDING

		MCB		WAYS TPN			HRC FUSES +			
200.0		C THE STATE OF THE	TSEC	HON		C.O,E.L.C.B.	40A,	300mA	4 POLE	1160
R No	Phase	W.SIZE samm	AMP	LOCATION	TYPE OF LIGHT/POWER	NO. OF POINTS	CONTROLLED	R	Y	В
	R	2.5	10	OFFICE BLDG.	LIGHT L02-L05	4(1x50)	SWITCH	200		
1	Y	2.5	10	LAB	LIGHT L6-L7	2(1x50)+1(1X80)	SWITCH		180	
	В	2.5	10	TOILET/CORRIDOR	LIGHT L06,-L08	1(1x70)+1(1x50)+1 (1X80)	SWITCH			200
	R	2.5	10	STORAGE	LIGHT L09-L10	2(1x50)	SWITCH	100		
2	Y	2.5	10	OFFICE-CAR PARK	LIGHT L01	1(1x50)	SWITCH		50	
	В	9.	10		SPARE					
	R	2.5	15	RO PLANT BLDG	LIGHT L13-L18	6(1x50)	SWITCH	300		
3	Y	2.5	10		SPARE					
	В		10	RO PLANT BLDG.	LIGHT L11-L12	2(1x50)	SWITCH			100
_		le .		POW	ER SECTION C.O	E.L.C.B 63A 30	mA 4 POLE)	
	R	4.0	15	OFFICE	P01-P03	3(1x200)	SWITCHED	600		
4	Y	4.0	15	OFFICE-LAB	P05	1(1x1000)	SWITCHED		1000	
	В	4.0	15	OFFICE LAB	P06	1(1x1000)	SWITCHED			100
	R	4.0	15		SPARE			3		
5	Y	4.0	15	OFFICE LAB	P04	1(1x200)	SWITCHED	-	200	
	В	4.0	15	OFFICE-STORAGE	P07	1(1x1000)	SWITCHED			1000
	R	4.0	15		SPARE					
6	Y	6.0	15		SPARE					
	В	6.0	15		SPARE		8			
	R	6.0	20	OFFICE BLDG	SU-01	1(1x2000)	JB+DP SWITCH	2000		
7	Y	6.0	20	OFFICE BLDG.	SU-02	1(1x2000)	JB+DP SWITCH		2000	
	В	4.0	15	3	SPARE				*	
	R	24	10		SPARE					
8	Y	4.0	10	RO PLANT BLDG	P11-P13	3(1x200)			600	
	В	4.0	10	RO PLANT BLDG.	P08-P09	3(1x200)				600
	R	4.0	10		SPARE					
9	Y	4.0	10		SPARE				-	
~	В	4.0	10	RO PLANT- GENERATOR ROOM	BATTERY CHARGER	1(1x500)	15A SPN S/F			500
П	R	4.0	10		SPARE			5)		
10	Y	4.0	10		SPARE				-	
,,,	В	4.0	10		SPARE					

DB-EX

			2	WAYS TPN		40A, TP, ISOLATOR				
						C.O.E.L.C.B.	40A,	300mA	4 POLE	
CR No	Phase	w5lZE xqmm	мсвжтн	LOCATION	DESCRIPTION	NO. OF POINTS	CONTROLL ED BY	R	Y	В
	R	60	15ASP	EXTERNAL LIGHTS	EX1-EX4	4(1x90)	Controlled by 20A2P	360		
1	γ	60	15ASP	EXTERNAL LIGHTS	EX5-EX8	4(1x90)	contactor, Photocell		360	
	В	in.	15ASP	EXTERNAL LIGHTS	EX9-EX12	4(1x90)	and H-O-A selector			360
	R	-	15ASP		SPARE					
2	Y		15ASP		SPARE					
	В	-	15ASP		SPARE					
	•				TOTAL CONN. LOAD	01.080 K.W.		360	360	360

REFERENCE DRAWINGS

SL.No DRAWING No.

0	28-12-'15	DETAILED DESIGN SUBMISSION	BA	RDS	MA
REV.	DATE	DESCRIPTION	DRAWN	CHKD.	APPRD.

REVISION



MINISTRY OF ENVIRONMENT & ENERGY REPUBLIC OF MALDIVES






PROJECT:
Consultancy Services for Survey, Design of
Water supply Facilities in Tha.Vilifushi, F.Nilandhoo,
B.Eydhafushi and Adh. Hanyaameedhoo, Maldives


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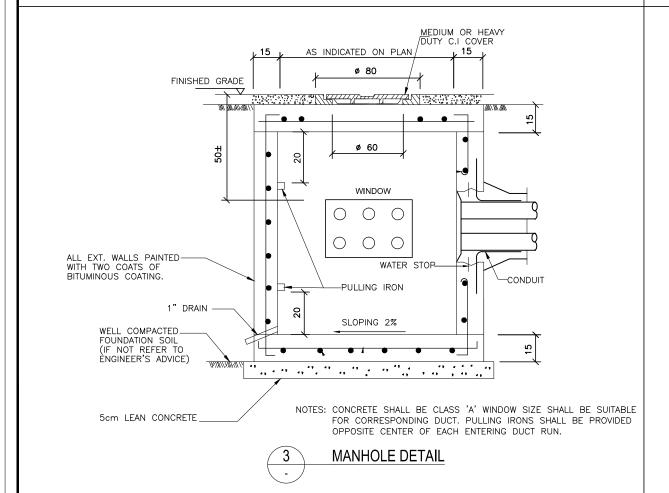
ELECTRICAL DB SCHEDULE


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	PROJECT No.	SHEET No.	DRAWING	No.			
	K-627	1 OF 1	TV-EL-104				
	BEV No	0	l				

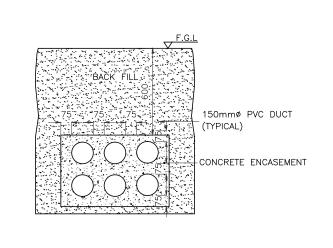


DUCT BANK DETAIL



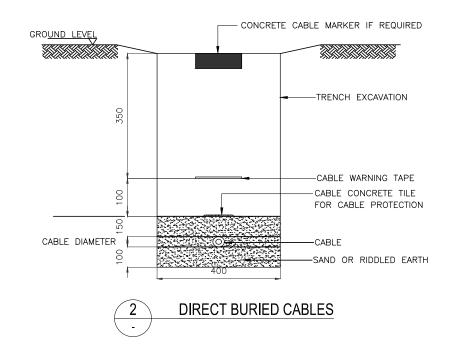

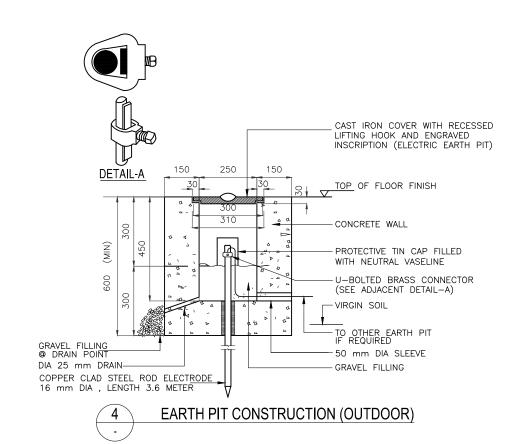

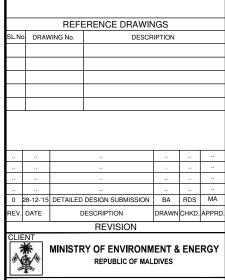

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Consultancy Services for Survey, Design of Water supply Facilities in Tha.Vilifushi, F.Nilandhoo, B.Eydhafushi and Adh. Hanyaameedhoo, Maldives

DRAWING TITLE

ELECTRICAL TYPICAL DETAILS T.VILUFUSHI ISLAND

П	DESIGNED	DRAWN	CHECKED	APPROVED	SCALE	DATE
	RDS	BA	RDS	MA	1:50	28-12-'15
П	PROJECT No.	SHEET No.	DRAWING	No.		
	K-627	1 OF 1	1 TV-EL-105			
	REV. No.	0				